ILLUSTRATION



LOCATION MAP



KEY MAP

### SHEET INDEX

P & SHEET INDEX GENERAL NOTES

& DEMOLITION PLAN \_AN, DETAILS & NOTES

ROSION & SEDIMENT CONTROL PLAN SERVICE AND VEHICULAR & SEDIMENT CONTROL AND STORMWATER

S REFERENCE PLAN RIALS PLAN ATEWAY PLAZA EXTENSION MATERIALS PLAN G LAYOUT LAYOUT PRETIVE PAING & BENCH LAYOUT ATEWAY PLAZA EXTENSION LAYOUT PLAN

DETAILS TAILS

OLS & ABBREVIATIONS A – PART 01 A – PART 02 LAN DIAGRAM

NTERPRETIVE PANEL ELEVATIONS RETIVE PANEL ELEVATIONS Y INTERPRETIVE PANEL ELEVATIONS WALL ELEVATION

RECAST WALL DETAILS

OUT LIGHTING PLAN YOUT NG LAYOUT CE AT GRADE

## GREENVILLE TOWN COMMON SYCAMORE HILL GATEWAY PLAZA


90% DESIGN SUBMISSION

ADDRESS: 201 W 1ST ST, GREENVILLE, NC 27858 Tel. 252.329.4567

OWNER:



DESIGN TEAM:

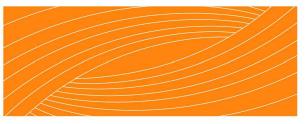

**RHODESIDE & HARWELL** 

510 King Street Suite 300 Alexandria, VA 22314 703-683-7447 ph 703-683-7449 fx www.rhodeside-harwell.com

## PERKINS+WILL

411 W. Chapel Hill St., Suite 200, Durham, NC 27701 919-433-5300 ph 919-433-5301 fx www.perkinswill.com

THE EAST GROUP GALLAGHER & ASSOCIATES BREE & ASSOCIATES LIGHT DEFINES FORMS INC ENGINEERING SOURCE

### NOT FOR CONSTRUCTION OR BIDDING

REVISION:

SCALE:

SHEET NAME:

COVER SHEET, KEY MAP & SHEET INDEX

SHEET NUMBER:

G-001

N.T.S.

DATE:


ARCH	ARCHITECT/ARCHITECTURAL	NTS	NOT TO SCALE	
ASSOC	ASSOCIATED	OC	ON CENTER	SUPER BL/
B&B BLDG	BALLED AND BURLAPPED BUILDING	P.A.	PLANTING AREA	LIMESTONE FINISH: TU
BB BOW	BOTTOM OF BENCH BOTTOM OF WALL	POB POC	POINT OF BEGINNING POINT OF CURVE	2 CONCRETE UI
CEHA	COASTAL EROSION HAZARD AREA	PROP	PROPOSED	SUPER BL
CIVIL CAL	CIVIL ENGINEER CALIPER	R RD ROW	RADIUS ROAD DICUT OF WAX	LIMESTONE FINISH: TU
CL CJ	CENTERLINE CONTROL JOINT	ROW	RIGHT-OF-WAY	3 RESIN BOUND
DEMO DIA	DEMOLISH DIAMETER	SAN SD	SANITARY/SANITARY SEWER STORM DRAIN	
DIM DWG	DIMENSION DRAWING	SF SIM	SQUARE FEET SIMILAR	4 POUR-IN-PL
EJ	EXPANSION JOINT	SPEC SQ	SPECIFICATIONS/SPECIFIED SQUARE	5 ENGRAVED IN INTERPRETIVE
EQ	EQUAL	SS ST	STAINLESS STEEL STORM	
FC FF	FACE OF CURB FINISHED FLOOR	TAC	THOMPSON ATHLETIC CENTER	6 DECOMPOSED IN METAL FR
FG FH	FINISHED GRADE (PAVED AREA) FIRE HYDRANT	TOC TEMP	TOP OF CURB TEMPORARY	7 WOOD BENCH
FOB FOW	FACE OF BUILDING FACE OF WALL	TB TOW TYP	TOP OF BENCH TOP OF WALL TYPICAL	
FT	FOOT/FEET	UTIL	UTILITY	8 PRECAST CO
IJD	ISOLATION JOINT	VAR	VARIES/VARIABLE	
LA LOW	LANDSCAPE ARCHITECT LIMIT OF WORK	W/	WITH	9 WOOD BENCH
	MAXIMUM MECHANICAL ENGINEER	W/O	WITHOUT	10 INTERPRETIVE SEE ARCH D
MECH MFR MIN	MANUFACTURER MINIMUM			
				11 EDGE RESTRA
REFEREN	<u>CE SYMBOLS</u>			12 EDGE RESTRA
0				
	ROPOSED CONTOUR			13 CURB RAMP
$\Delta \Delta \Delta$	ROPOSED SPOT LEVATION (THIS CONTRACT)			14 DRINKING FO
·				
	XISTING SPOT ELEVATION			15 POUR-IN-PL CONCRETE S
(1	TO REMAIN)			21 LIGHTING FIX
<u>0%</u> P	ROPOSED SLOPE			
A	LIGN			
1	DETAIL NUMBER (OR LETTER)			OTHER FEATURES:
-271				31 PRESERVE EX SEE CIVIL PL
233				32 EXISTING ON
	DIRECTION SECTION FACES			
$\checkmark$	DETAIL NUMBER (OR LETTER)			33 EXISTING SID
1 L-234	SHEET NUMBER			34 EXISTING CR
				34 EXISTING CR
1	NUMBERED NOTE. REFER TO NOTE LEGENDS MAY BE GIVEN ON INDIVI			35 RELOCATED I
	FOR EASE OF REFERENCE.			
				36 RELOCATE EX
10 PH0	PLANT QUANTITY PLANT SYMBOL, REFER TO PLANT	LIST		37 EXISTING CU
10 PH0		LIST		
$\longrightarrow$		LIST		37 EXISTING CUF 38 INGROUND LIG SEE LIGHTING
РНО	PLANT SYMBOL, REFER TO PLANT	LIST		38 INGROUND LIGHTING
PHO MISCELLAN	PLANT SYMBOL, REFER TO PLANT	LIST		38 INGROUND LI

NUMBER

METER

mm

MILLIMETER

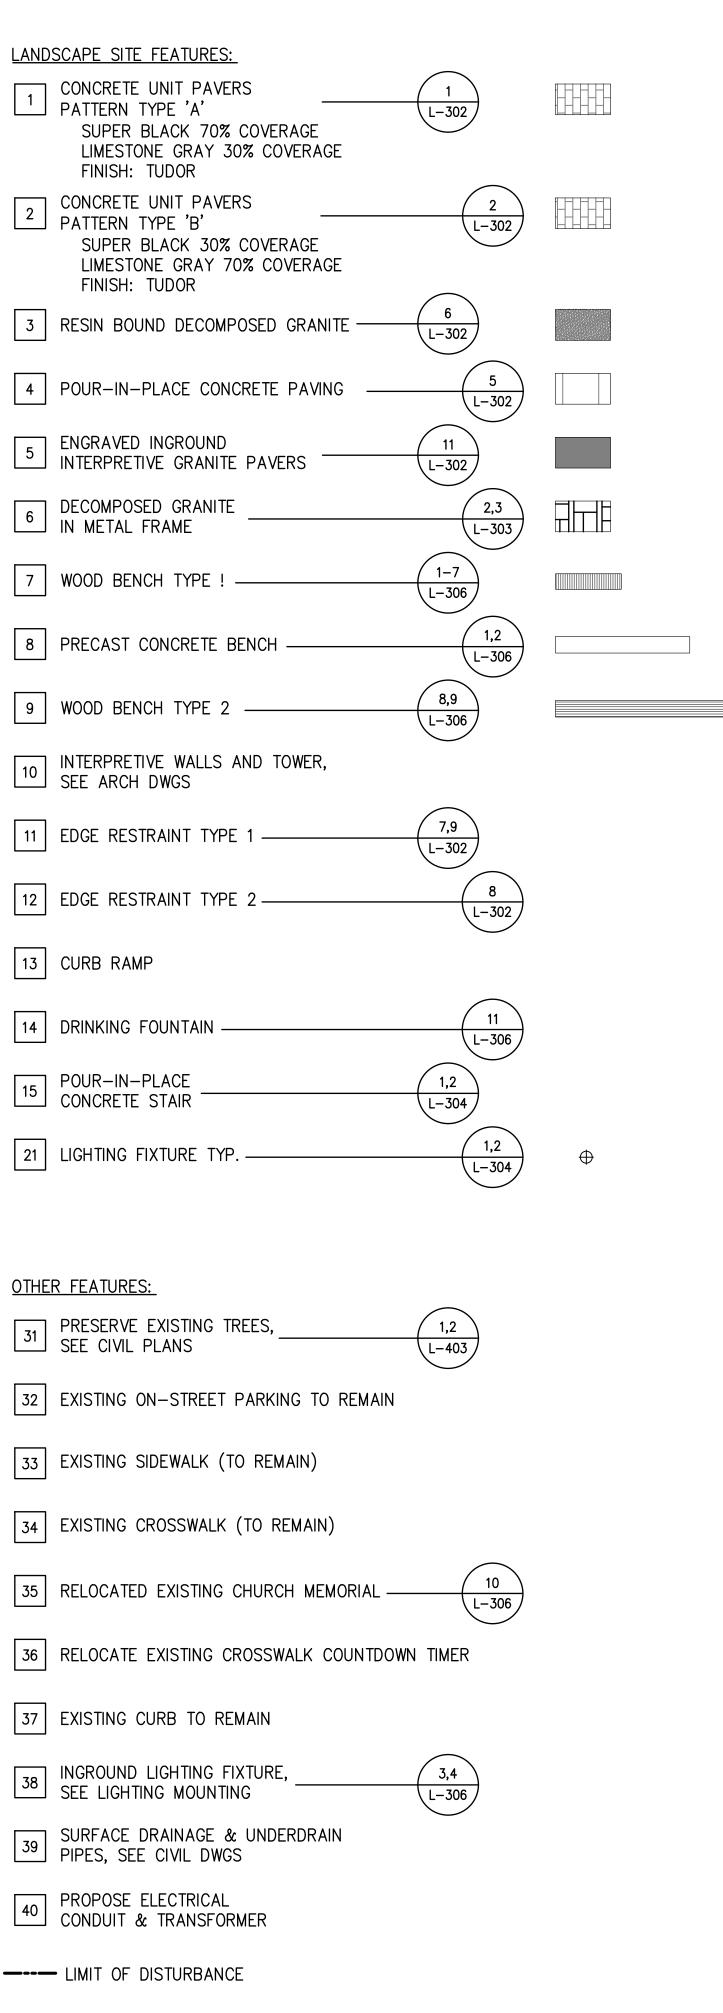

#### **GENERAL NOTES:**

- 1. THE DRAWINGS AND SPECIFICATIONS, TAKEN TOGETHER, DESCRIBE THE DESIGN FOR THIS PROJECT. THE DRAWINGS AND SPECIFICATIONS ARE MEANT TO BE COMPLIMENTARY TO EACH OTHER.
- 2. THAT WHICH IS SHOWN ON THE DRAWINGS BUT NOT IN THE SPECIFICATIONS, OR SHOWN IN THE SPECIFICATIONS BUT NOT ON THE DRAWINGS, SHALL BE PROVIDED AS IF SHOWN IN BOTH PLACES AND TO THE SAME STANDARD OF QUALITY FOR SIMILAR ITEMS.
- 3. DRAWINGS SHOW EXTENT, LOCATION, DIMENSIONS, RELATIONSHIPS AMONG VARIOUS PART, AND QUANTITY OF ITEMS. IN CASE OF CONFLICT WITH THE SPECIFICATIONS IN THESE MATTERS, THE DRAWINGS SHALL GOVERN.
- 4. SPECIFICATIONS SHOW QUALITY, TRADE NAME, GENERIC NAMES, AND WORKMANSHIP. IN CASE OF CONFLICT WITH THE DRAWINGS IN THESE MATTERS, THE SPECIFICATIONS SHALL GOVERN.
- 5. THE LARGER THE SCALE OF THE DRAWINGS, THE MORE PRECEDENCE: i.e. A 1 INCH PER FOOT SCALE DRAWING GOVERNS OVER A 10 FEET PER INCH DRAWING.
- 6. CONTRACTOR SHALL PROTECT FROM ALL DAMAGE EXISTING TREES TO REMAIN AND THEIR ROOT STRUCTURES
- 7. CONTRACT INCLUDES ALL DEMOLITION REQUIRED TO COMPLETE JOB AND TO REMOVE AND TO DISPOSE OF ITEMS FROM SITE COMPLETELY IN ACCORDANCE WITH LOCAL LAWS. DO NOT BURN OR BURY ANY DEMOLITION ITEMS ON SITE. CONTRACTOR IS RESPONSIBLE FOR MAKING SITE VISIT TO DETERMINE AND VERIFY ALL DEMOLITION REQUIREMENTS PRIOR TO BIDDING.
- 8. PERMITS AND FEES REQUIRED FOR ANY DEMOLITION DISPOSAL WORK MUST BE OBTAINED BY THE CONTRACTOR AT CONTRACTOR'S EXPENSE.
- 9. THE CONTRACTOR SHALL TAKE PROPER PRECAUTIONS NOT TO DAMAGE EXISTING ADJACENT FACILITIES AND STRUCTURES THAT ARE TO REMAIN. THE CONTRACTOR SHALL RESTORE DISTURBED AREAS TO THEIR ORIGINAL CONDITION (UNLESS OTHERWISE INDICATED) TO THE SATISFACTION OF THE CONTRACTING REPRESENTATIVE AND OWNER. ADJACENT STREETS AND SIDEWALKS SHALL BE MAINTAINED IN A CLEAN CONDITION, MUD AND DUST FREE. ADEQUATE MEANS AND FACILITIES SHALL BE PROVIDED BY THE CONTRACTOR TO CLEAN TRUCKS AND OTHER EQUIPMENT LEAVING THE SITE.
- 10. THE EXISTING SURROUNDING FACILITIES ARE TO REMAIN IN OPERATION WHILE CONSTRUCTION WORK IS BEING DONE. ALL UTILITY WORK SHALL BE COORDINATED WITH THE OWNER AND LOCAL UTILITY COMPANIES AND SHALL BE PERFORMED IN AN EXPEDITIOUS MANNER.
- 11. UTILITIES SHOWN ON DRAWINGS ARE BASED ON PUBLISHED DATA AND ARE FOR CONTRACTOR'S CONVENIENCE ONLY. THE CONTRACTOR MUST LOCATE AND VERIFY ALL SUCH INFORMATION, INCLUDING INFORMATION NOT SHOWN ON PLANS, BY CONTACTING THE INDIVIDUAL UTILITY COMPANY AND INVESTIGATING THE SITE TO DETERMINE THE EXACT LOCATION OF RESPECTIVE UTILITY LINES AND STRUCTURES. THE CONTRACTOR SHALL BE RESPONSIBLE FOR REPAIRING, AT HIS OWN EXPENSE, AND TO THE SATISFACTION OF THE PROJECT OWNER & THE UTILITY OWNER, DAMAGE TO ANY UTILITY CAUSED BY HIS WORK. HE SHALL IMMEDIATELY NOTIFY THE OWNER AND THE UTILITY OWNER OF ANY DAMAGE TO ANY UTILITY BY REASON OF HIS OPERATION.
- 12. DO NOT SCALE DRAWINGS. CONTRACTOR SHALL VERIFY ALL CONDITIONS AND DIMENSIONS AT THE JOB SITE PRIOR TO VERTICAL AND HORIZONTAL START OF CONSTRUCTION. DISCREPANCIES ARE FOUND, NOTIFY THE PROJECT REPRESENTATIVE IMMEDIATELY FOR CLARIFICATION.
- 13. FOR ALL PAVEMENT REMOVAL AREAS, NEATLY SAWCUT ALL EDGES. TIES TO EXISTING PAVEMENT AREAS SHALL BE SMOOTH CONSISTENT TRANSITIONS. NO ABRUPT CHANGE IN LINE AND/OR GRADE WILL BE PERMITTED.
- 14. IN AREAS OF FORMER PAVED SURFACES (ROADBEDS, WALKWAYS, ETC.), REMOVE ALL EXISTING PAVING MATERIAL, INCLUDING BASE MATERIALS. EXCAVATE EXISTING SUBGRADE TO A TOTAL DEPTH OF 18" BELOW FINISHED GRADE. SCARIFY BOTTOM OF EXCAVATION TO A DEPTH OF 4". IF FINISHED GRADE IS GREATER THAN 14" ABOVE EXISTING SUBGRADE SCARIFY EXISTING SUBGRADE TO MINIMUM DEPTH OF 4". FILL AREA WITH APPROVED EARTH FILL TO A TOTAL DEPTH OF 4" BELOW FINISHED GRADE. PLACE SOIL IN MAXIMUM 8" LIFTS, AND COMPACT EACH LIFT TO MINIMUM 50%, MAXIMUM 75% DENSITY. SPREAD TOPSOIL OVER ENTIRE DISTURBED AREA TO DEPTH OF 4". LIGHTLY COMPACT TOPSOIL. BLEND EDGES OF TOPSOIL TO MATCH GRADES OF ADJACENT [EXISTING OR PROPOSED] CONDITIONS.
- 15. POSITIVE DRAINAGE SHALL BE MAINTAINED DURING ALL PHASES OF CONSTRUCTION. PONDING OR STANDING WATER WILL NOT BE PERMITTED.
- 16. CONTRACTOR SHALL NOTIFY THE PROJECT REPRESENTATIVE OF ANY DEVIATION FROM THIS PLAN PRIOR TO ANY CHANGE BEING MADE. ANY DEVIATION FROM THIS PLAN WITHOUT WRITTEN AUTHORIZATION FROM THE PROJECT REPRESENTATIVE WILL BE THE SOLE RESPONSIBILITY OF THE CONTRACTOR, AND CORRECTIONS SHALL BE MADE BY THE CONTRACTOR AT NO COST TO THE OWNER.
- 17. PROVIDE SAMPLES AND/OR SAMPLE PANELS / MOCK-UPS AS SPECIFIED FOR ALL CAST STONE, STONE, PRECAST CONCRETE, MASONRY, STONE, WOOD AND/OR METAL FABRICATIONS WORK AS SHOWN ON THESE DRAWINGS. OBTAIN APPROVAL OF SAMPLES PRIOR TO ORDERING MATERIALS. OBTAIN APPROVAL OF SAMPLE PANELS / MOCK-UPS PRIOR TO INSTALLATION.
- 18. PROVIDE SUBMITTALS AND SHOP DRAWINGS AS SPECIFIED FOR ALL PRECAST CONCRETE, STONE, WOOD, AND/OR METAL FABRICATIONS WORK AS SHOWN ON THESE DRAWINGS. OBTAIN APPROVAL OF SUBMITTALS AND SHOP DRAWINGS PRIOR TO START OF FABRICATION.
- 19. FIELD VERIFY AS-BUILT DIMENSIONS PRIOR TO FABRICATION OF PRECAST CONCRETE, STONE, WOOD AND/OR METAL FABRICATIONS WORK AS SHOW ON THESE DRAWINGS.
- 20. FOR ALL METAL FABRICATIONS, WELD ALL CONNECTIONS, UNLESS SPECIFICALLY NOTED OTHERWISE. GRIND ALL WELDS TO SMOOTH BARE METAL WITHOUT MARRING ADJOINING MEMBERS. GRIND SMOOTH AND TRUE ALL SHARP CORNERS.

## GREENVILLE TOWN COMMON SYCAMORE HILL **GATEWAY PLAZA**

90% DESIGN SUBMISSION


### ADDRESS:

201 W 1ST ST, GREENVILLE, NC 27858 Tel. 252.329.4567

OWNER:



DESIGN TEAM:

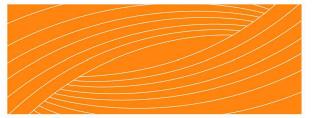

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THE EAST GROUP GALLAGHER & ASSOCIATES BREE & ASSOCIATES LIGHT DEFINES FORMS INC ENGINEERING SOURCE

#### NOT FOR CONSTRUCTION **OR BIDDING**

**REVISION:** 

SCALE:

SHEET NAME:


SYMBOLS, KEY NOTES & GENERAL NOTES

N.T.S.

SHEET NUMBER:




DATE:

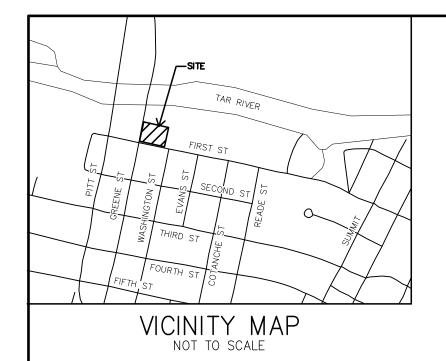

OWNER / DEVELOPER

CITY OF GREENVILLE PO BOX 7207 GREENVILLE, NC 27835 CONTACT: LAMARCO MORRISON, PARKS PLANNER (252) 329-4242

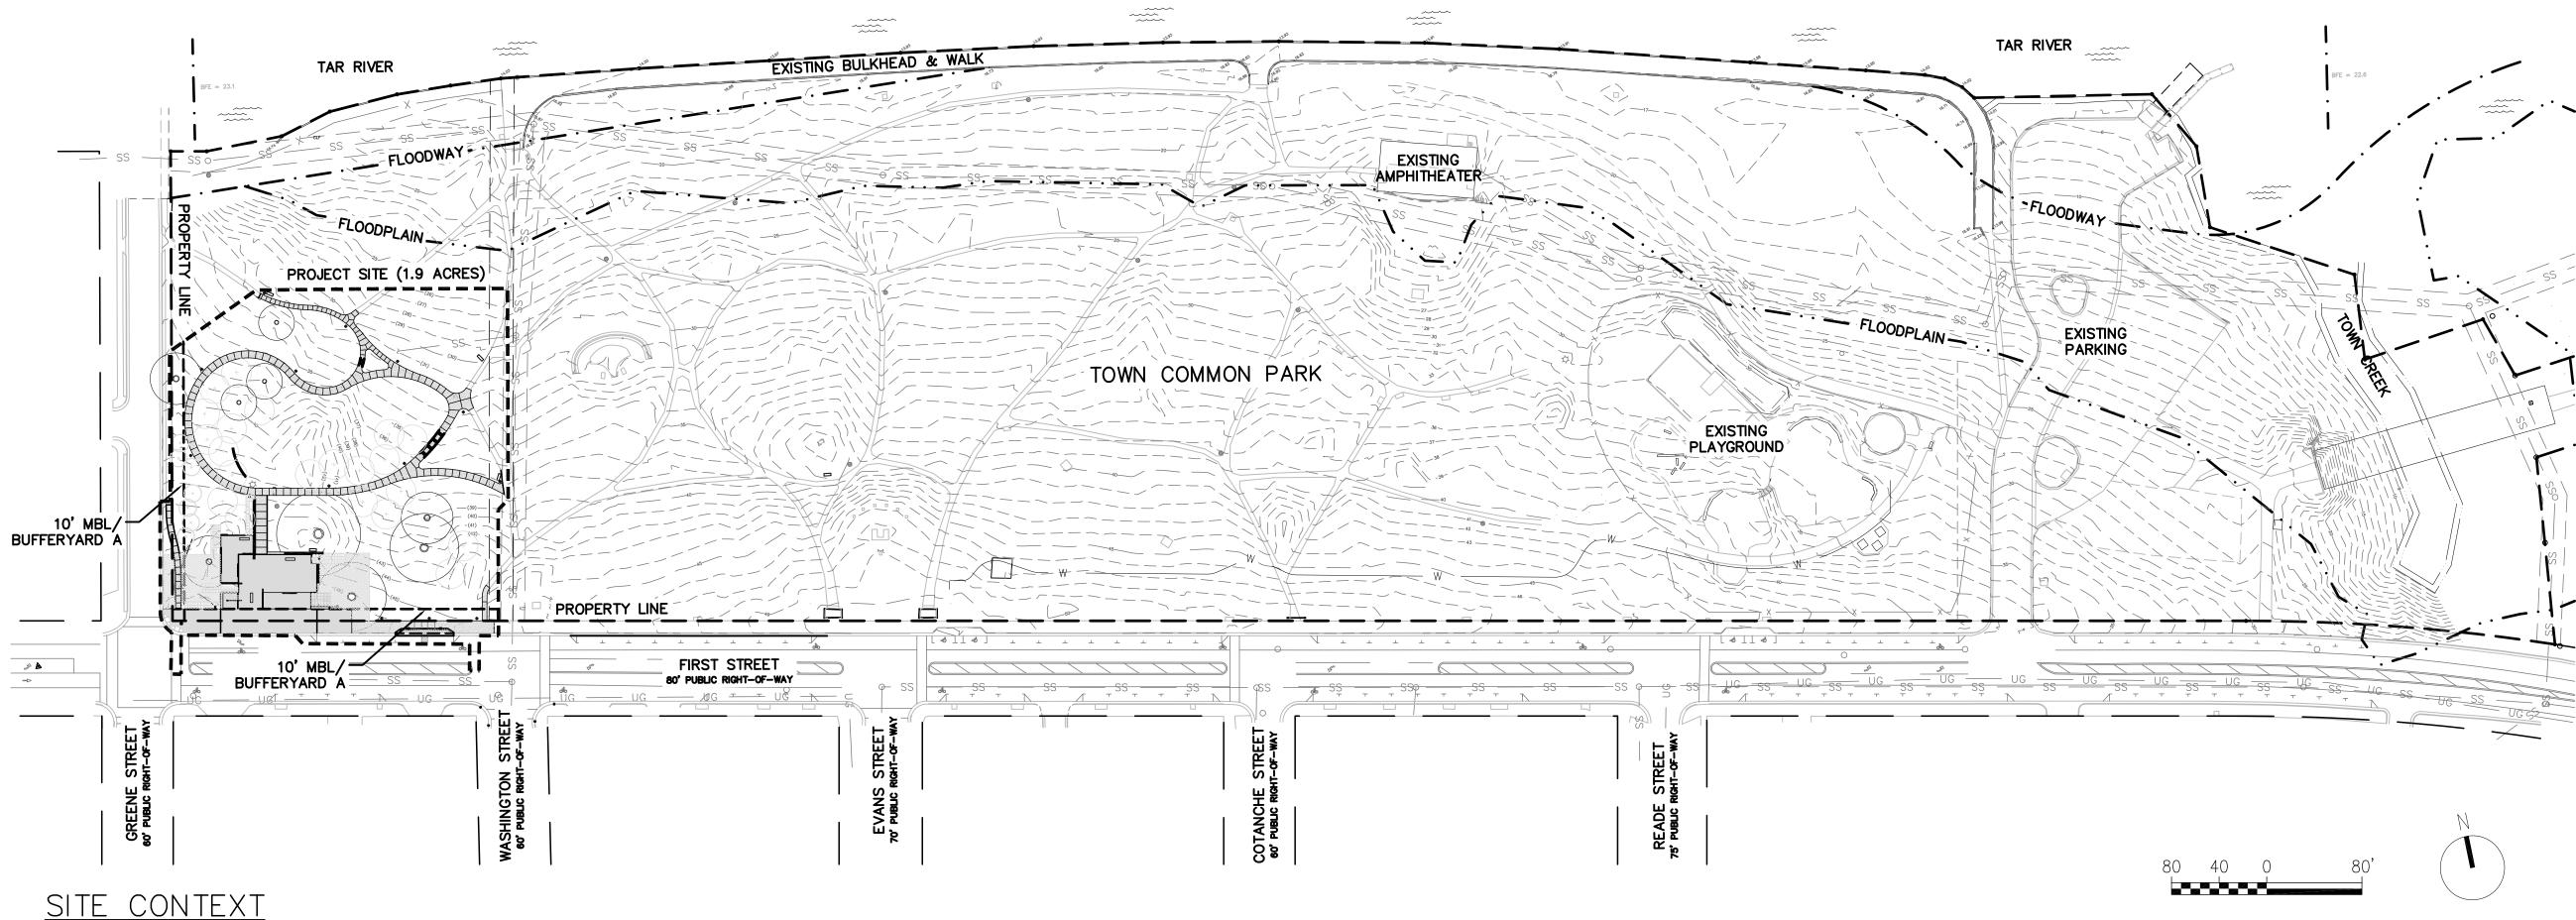

GENERAL NOTES:

- 1. SITE SHALL MEET ALL RELATED ACCESSIBILITY REQUIREMENTS.
- 2. ACCESSIBLE ROUTE IS PROPOSED FROM TWO (2) PROPOSED ACCESSIBLE PARKING SPACES ON THE NORTH SIDE OF 1ST STREET TO THE PROJECT SITE.
- 3. NO WATERBODIES SUBJECT TO TAR PAMLICO BUFFER RULES EXIST WITHIN THE DISTURBED LIMITS OF THE PROJECT AREA.
- 4. THIS PROJECT IS NOT LOCATED WITHIN THE FLOODWAY.
- 5. THIS PROJECT DOES NOT DISTURB WETLANDS.
- 6. THIS PROJECT DISTURBS MORE THAN 1-ACRE AND REQUIRES A SOIL EROSION AND SEDIMENTATION CONTROL PERMIT.
- 7. THIS PROJECT DISTURBS MORE THAN 1/2-ACRE AND REQUIRES A
- STORMWATER MANAGEMENT PLAN.
- 8. CITY OR NCDOT DRIVEWAY PERMIT IS NOT REQUIRED FOR THIS PROJECT. ANY ENCROACHMENT AGREEMENTS SHALL BE APPROVED BEFORE INSTALLATION.
- 9. AN UNUSED DRIVEWAY MUST BE CLOSED IN ACCORDANCE WITH THE CITY OF GREENVILLE'S DRIVEWAY ORDINANCE.
- 10. CONTRACTOR MUST NOTIFY ONE CALL CENTER, INC. (NC ONE-CALL) (811) AT LEAST 48 HOURS PRIOR TO THE START OF EXCAVATION OR TRENCHING TO HAVE ALL UNDERGROUND UTILITIES LOCATED.



	DATE
Approved Approved as Noted	
Zoning	Engineering
Surveyor/Floodplain	Inspections
Fire/Rescue	GUC Electric
GUC Water/Sewer	GUC Gas
NCDOT	Vegetation
Traffic Services	Notes

	CIVIL ENGIN
C-001	COMPOSITE
C-002	DEMOLITION
C-003	TREE PRES
C-101	SITE PLAN
C-102	SITE PLAN:
C-201	GRADING, [
C-301	UTILITY PL
C-401	SITE DETAI
C-402	SITE DETAI
	SURVEYING
SU1	LOCATION
SU2	LOCATION
SU3	TOPOGRAPH
SU4	TOPOGRAPI
L	1

- 11. ALL REQUIRED IMPROVEMENTS SHALL CONFORM TO THE CITY OF GREENVILLE MANUAL OF STANDARD DESIGNS AND DETAILS (MSDD).
- 12. CONTRACTOR SHALL NOTIFY PUBLIC WORKS, STREET MAINTENANCE DIVISION 48 HOURS PRIOR TO MAKING CONNECTIONS TO EXISTING STORM DRAINS LOCATED WITHIN PUBIC STORM DRAINAGE EASEMENTS OR RIGHT-OF-WAY.
- 13. THIS PROPERTY IS LOCATED IN ZONE "X" AND "AE" AND IS PARTIALLY LOCATED IN A SPECIAL FLOOD HAZARD AREA AS TAKEN FROM N.F.I.P. RATE MAP DATED JULY 7, 2014 COMMUNITY PANEL 3720468800K; BASE FLOOD ELEVATION (BFE) NOTED HEREON.
- 14. LANE CLOSURES ON THOROUGHFARE ROADS ARE ONLY PERMITTED BETWEEN THE HOURS OF 9:00AM AND 4:00PM, MONDAY THROUGH FRIDAY, UNLESS OTHERWISE PERMITTED BY THE TRAFFIC ENGINEER. IN ADDITION, THERE WILL BE NO LANE CLOSURES ON HOLIDAYS INCLUDING THE DAY BEFORE OR AFTER SAID HOLIDAY. A TRAFFIC CONTROL PLAN PREPARED IN ACCORDANCE WITH THE NCDOT MANUAL OF UNIFORM TRAFFIC CONTROL DEVICES IS REQUIRED FOR ALL LANE CLOSURES AND MUST BE APPROVED BY THE TRAFFIC ENGINEER.
- 15. CONTRACTOR SHALL PROVIDE A CONSTRUCTION PHASING AND LOGISTICS PLAN FOR REVIEW AND APPROVAL BY OWNER PRIOR TO CONSTRUCTION.
- 16. REFUSE COLLECTION METHOD: PUBLIC SERVICE.

SITE	DATA				
(a)	TOTAL AREA IN SITE				
(b)	TOTAL AREA DISTURBED				
(c)	CURRENT ZONING				
	LAND USE CLASSIFICATION				
(d) SUBDIVISION NAME, BLOCK & LOT					
	TAX MAP AND PARCEL NUMBER				
	STREET ADDRESS				
(e)	ACREAGE IN COMMON AREA				
(f)	ACREAGE IN RECREATION AREA				
(g)	TOTAL NUMBER OF UNITS/BEDROOMS				
(h)	GROSS FLOOR AREA				
(i)	BUILDING LOT COVERAGE (EXISTING)				
	BUILDING LOT COVERAGE (PROPOSED)				
(j)	BUILDING HEIGHT (FEET & STORIES)				
(k)	TOTAL NUMBER OF PARKING SPACES (EXISTING)*				
	TOTAL NUMBER OF PARKING SPACES (REQUIRED)				
	TOTAL NUMBER OF PARKING SPACES (PROVIDED)				
(I)	TOTAL NUMBER OF ACCESSIBLE PARKING SPACES				
	TOTAL NUMBER OF ACCESSIBLE PARKING SPACES				
	TOTAL NUMBER OF ACCESSIBLE PARKING SPACES				
(m)	TOTAL SQUARE FEET OF IMPERVIOUS AREA (EXIST				
	TOTAL SQUARE FEET OF IMPERVIOUS AREA (PROF				
	* ADJACENT TO PARK PROPERTY LINE ON NORTH				
	** WITHIN LIMITS OF DISTURBANCE				

### NEERING SHEET INDEX

#### PLAN PLAN

SERVATION PLAN, DETAILS & NOTES

#### VEGETATION

DRAINAGE, EROSION & SEDIMENTATION CONTROL PLAN, NOTES & DETAILS AN: WATER SERVICE

- AILS: UTILITY & VEHICULAR
- ILS: EROSION & SEDIMENT CONTROL AND STORMWATER

### <u>G SHEET INDEX</u>

SURVEY

### SURVEY

- PHIC SURVEY
- PHIC SURVEY

## GREENVILLE TOWN COMMON **SYCAMORE HILL GATEWAY PLAZA**

90% DESIGN SUBMISSION


### ADDRESS:

201 W 1ST ST, GREENVILLE, NC 27858 Tel. 252.329.4567

#### OWNER:



DESIGN TEAM:

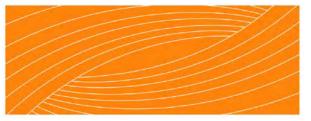

### **RHODESIDE & HARWELL**

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### PERKINS+WILL


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THE EAST GROUP GALLAGHER & ASSOCIATES BREE & ASSOCIATES LIGHT DEFINES FORMS INC ENGINEERING SOURCE

### NOT FOR CONSTRUCTION AND BIDDING

REVISION:	
<u>A 09-06-18 STORMW</u>	ATER PLAN,
	ED CONT PLAN,
& COG SI	TE PLAN
SCALE:	I" = 80' - 0"
SHEET NAME:	
	COMPOSITE PLAN
SHEET NUMBER:	
	$C_{-001}$

DATE:

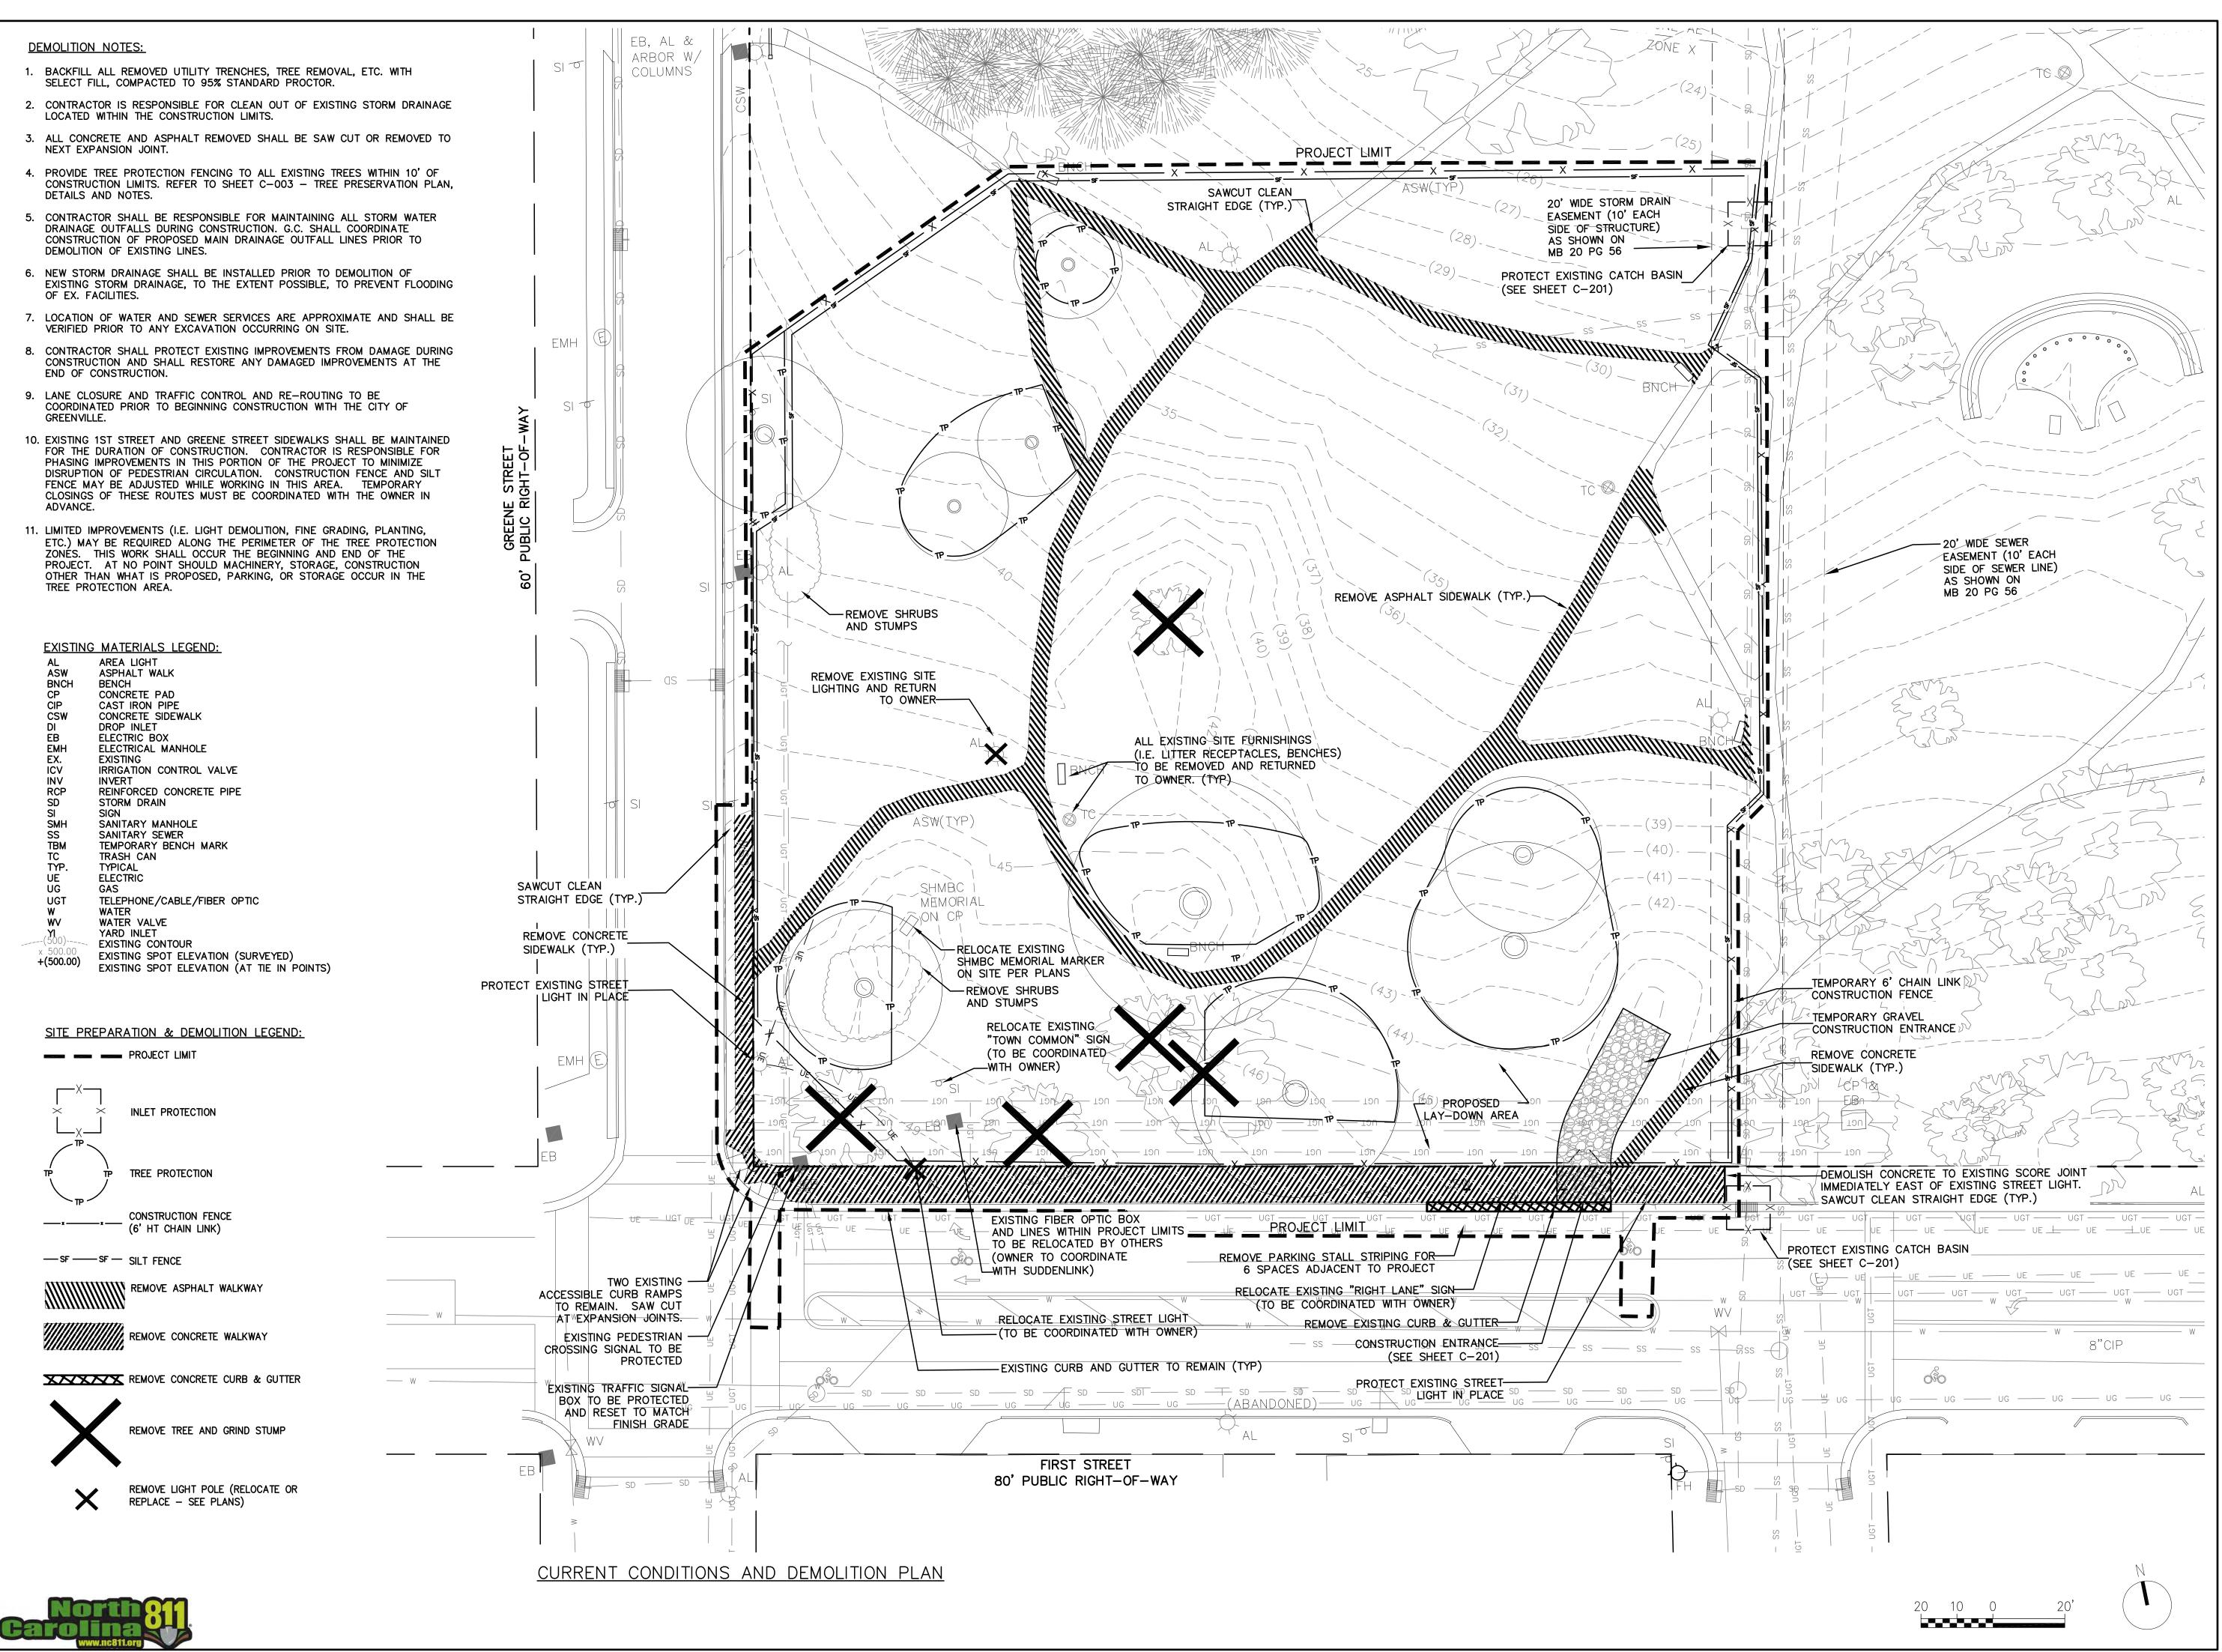

90% DESIGN SUBMISSION


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REVISION:	
<u>A 09-06-18 STOR</u>	MWATER PLAN,
EROS	& SED CONT PLAN,
& CO	G SITE PLAN
SCALE:	
	I" = 20' - 0"
SHEET NAME:	
(	EURRENT CONDITIONS
	& DEMOLITION FLAN
SHEET NUMBER:	
	C-002
DATE:	SEPTEMBER 26 2018

EXISTING TREE ASSESSMENT AND RECOMMENDATION REPORT:

The following shall be provided per Specification Section 015639: Temporary Tree and Plant Protection:


ARBORIST REPORT: Prior to the start of construction, submit, for approval by the Owner's Representative, the report of a consulting arborist who is a registered Consulting Arborist® (RCA) with American Society of Consulting Arborists or an ISA Board Certified Master Arborist, which details the following information for all trees to remain within the area designated on the drawings as the Tree and Plant Protection Area. The report shall include the following:

- A description of each tree to remain indicating its genus and species, condition including any visible damage to the root system or soil within the root zone, tree diameter at breast height (dbh) and approximate height, size and any visible disease, insect infestations and or branch and trunk structural deficiencies.
   The report shall note all trees or parts of trees, which are considered a hazard or significant or extreme risk level. Include the International Society of Arboriculture hazard evaluation sheet for each tree, which may reasonably be identified as a potential hazard tree.
   Recommendations as to treatment of all insect, disease and structural problems encountered.
   Recommendations for fertilizer treatments, if any.

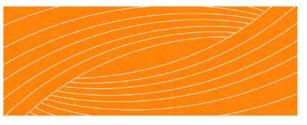
- Recommendations for root and/or canopy preservation measures.
   A plan of the site showing the location of all trees included in the report.

PRODUCT DATA: Submit manufacturer product data and literature describing all products required by this section to the Owner's Representative for approval. Provide submittal four weeks before the start of any work at the site.

QUALIFICATIONS SUBMITTAL: For each applicable person expected to work on the project, provide copies of the qualifications and experience of the Consulting arborist, proof of either the registered Consulting Arborist® (RCA) with American Society of Consulting Arborists or an ISA Board Certified Master Arborist and any required Herbicide/Pesticide license to the Owner's Representative, for review prior to the start of work.

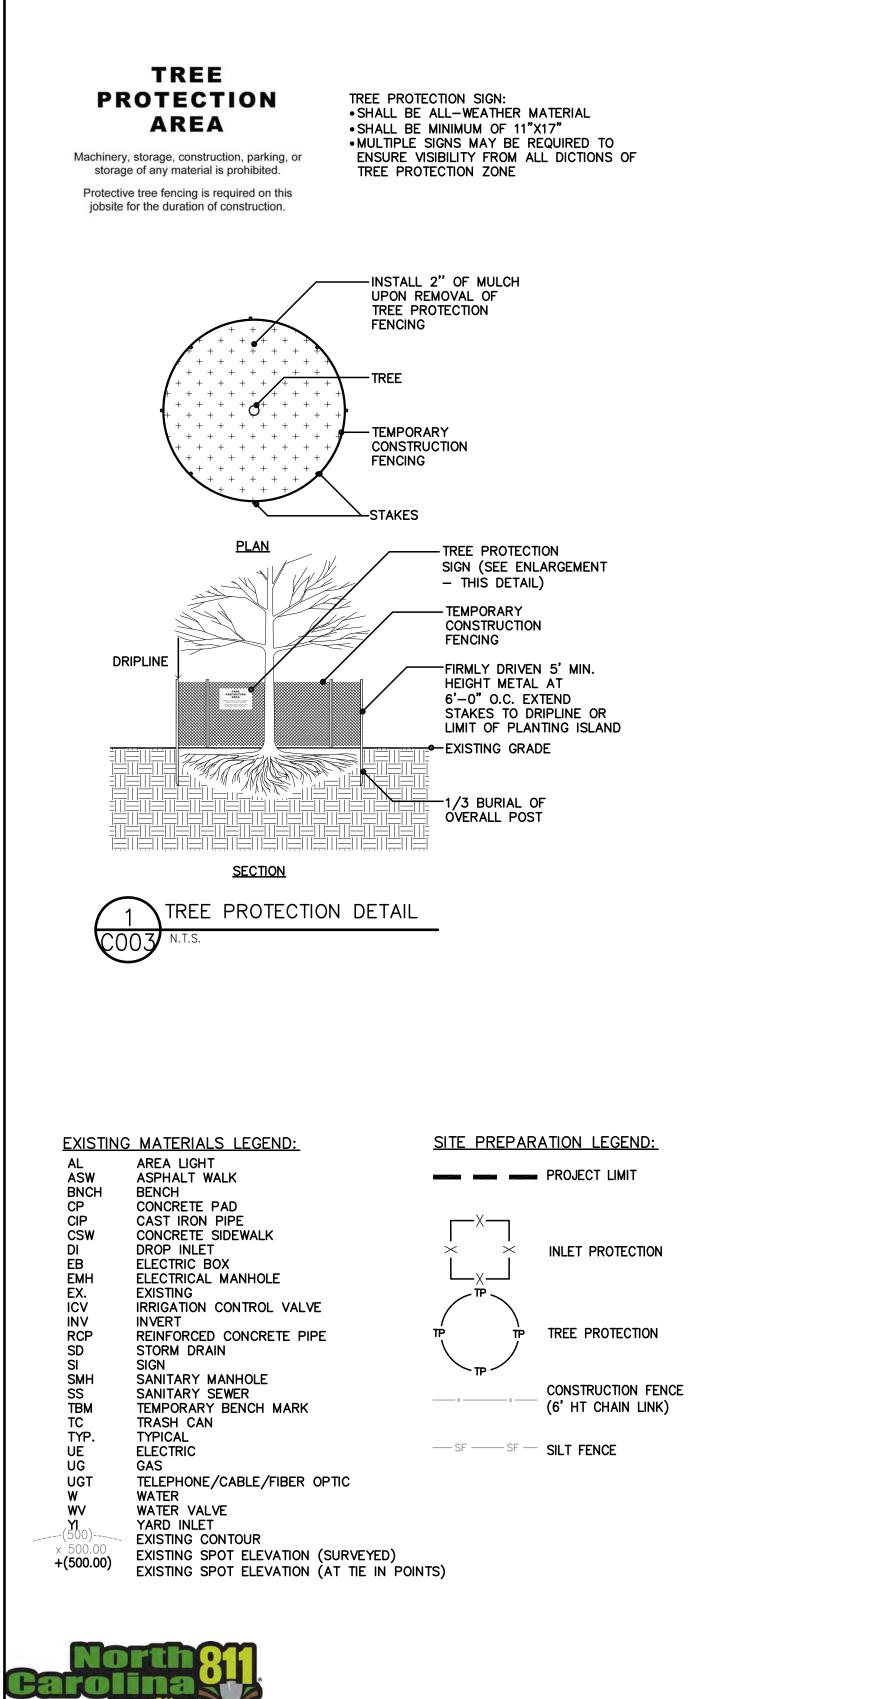

— W |-

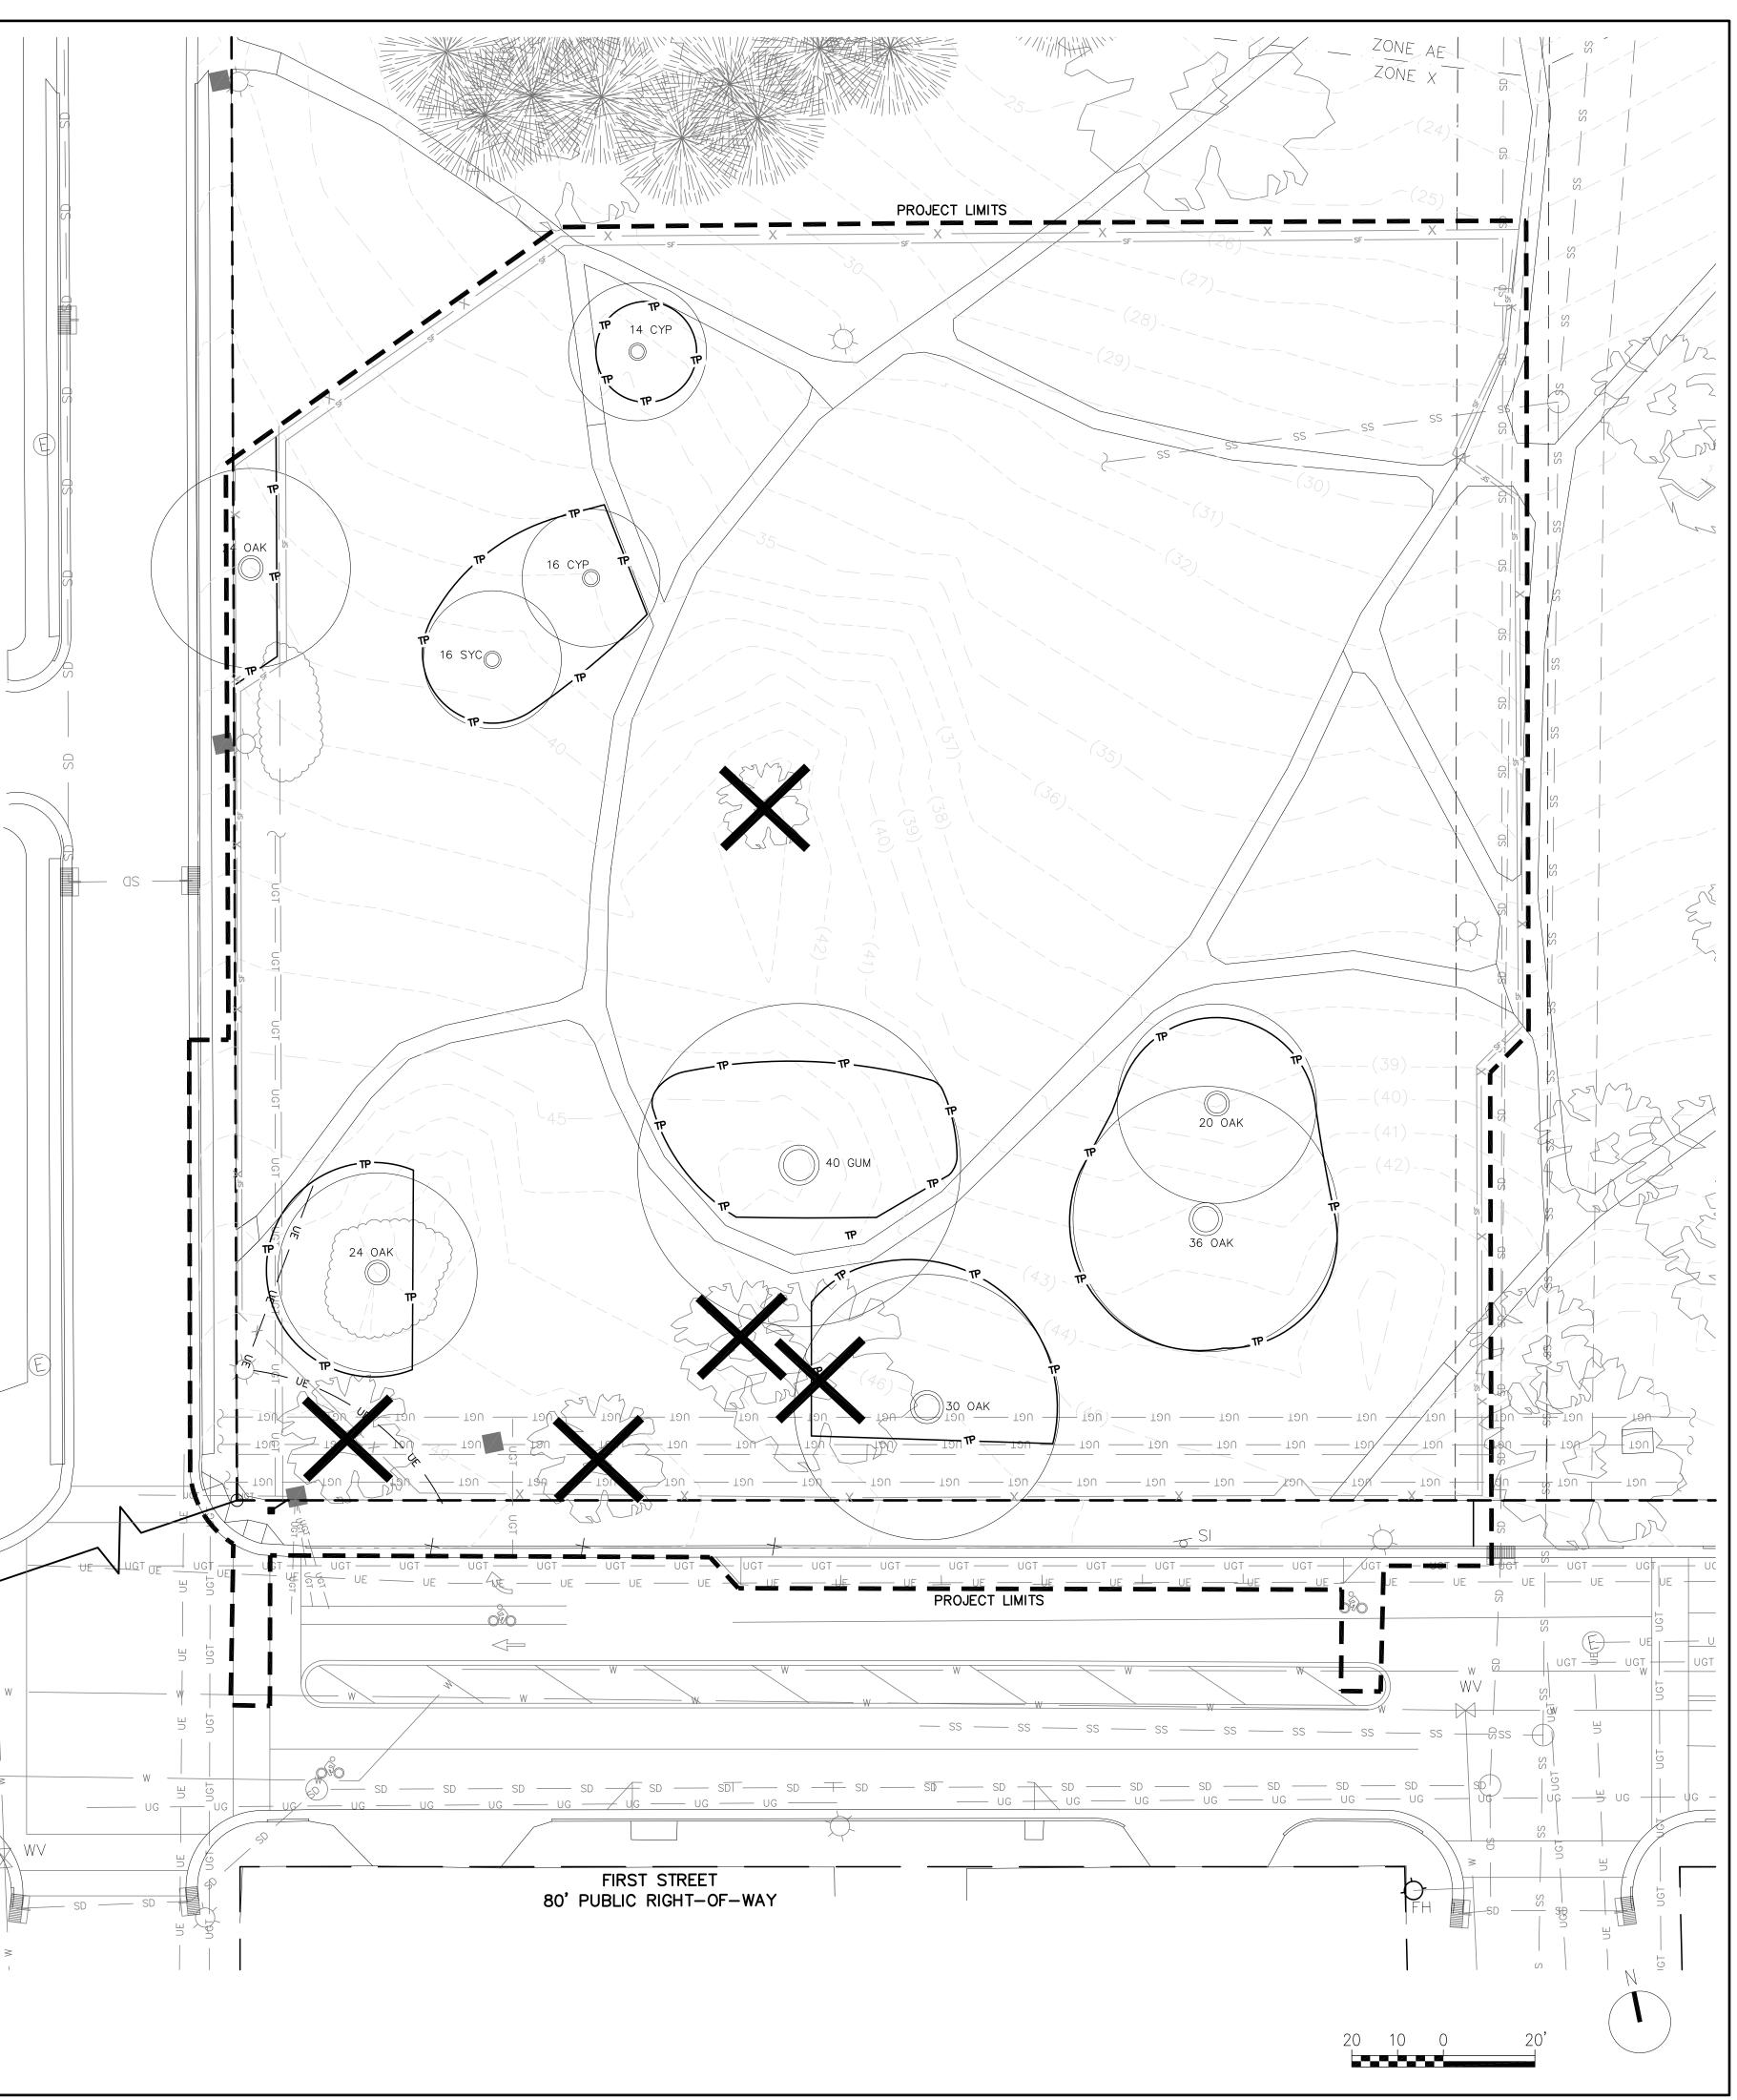

## GREENVILLE TOWN COMMON SYCAMORE HILL **GATEWAY PLAZA**

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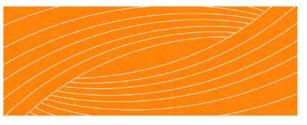
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#### OWNER:



DESIGN TEAM:



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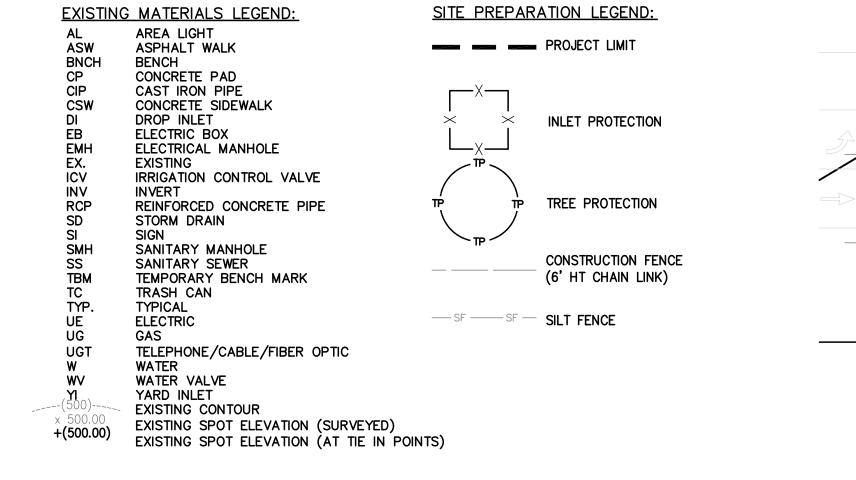
THE EAST GROUP GALLAGHER & ASSOCIATES BREE & ASSOCIATES LIGHT DEFINES FORMS INC ENGINEERING SOURCE

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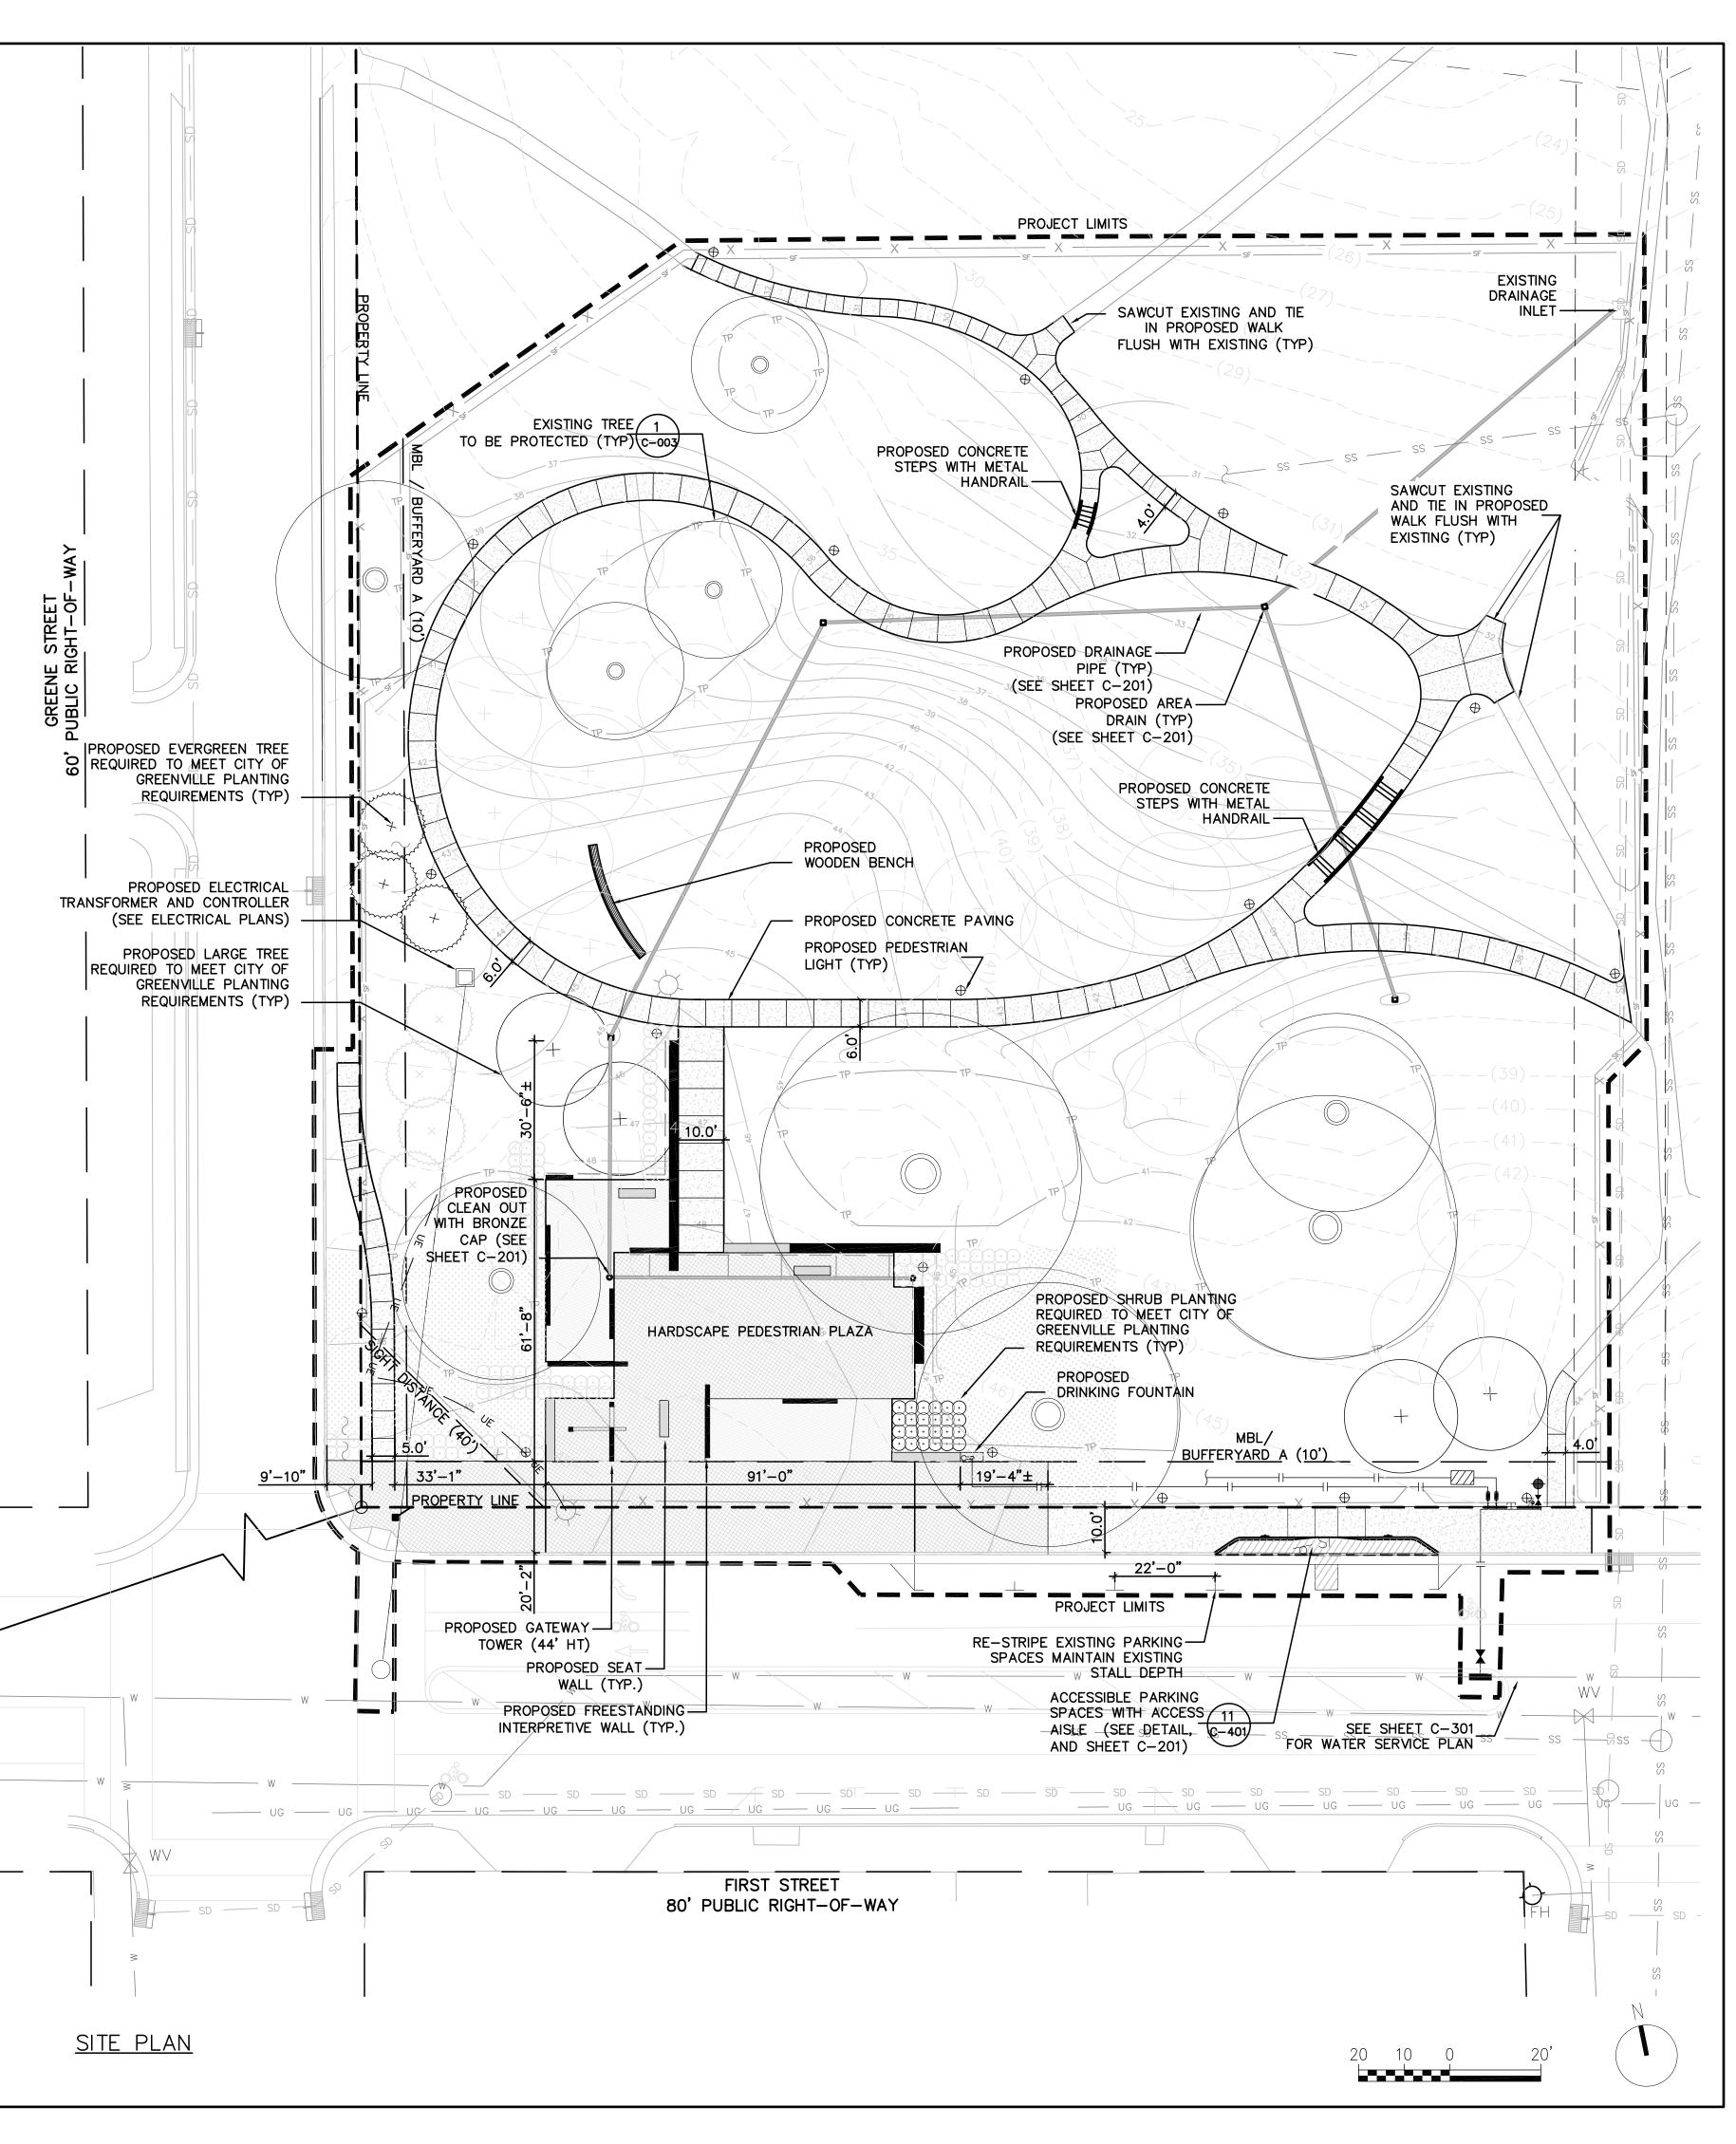
REVISION:	
A 09-06-18 STORM	WATER PLAN,
EROS 8	SED CONT PLAN,
& COG	SITE PLAN
SCALE:	1'' = 20' - 0''
SHEET NAME:	REE PRESERVATION
	PLAN, DETAILS &
	NOTES
SHEET NUMBER:	
SHEET NUMBER.	
	C-003
DATE:	SEPTEMBER 26 2018

#### <u>NOTE</u>

THIS PLAN INCLUDES MATERIAL AND LAYOUT INFORMATION FOR PURPOSES OF THE CITY OF GREENVILLE SITE PLAN, STORMWATER AND EROSION & SEDIMENT CONTROL PLAN REQUIREMENTS. COMPLETE LAYOUT, MATERIALS, DETAILS AND NOTES WILL BE PROVIDED IN THE LANDSCAPE ARCHITECTURE, ARCHITECTURE, STRUCTURAL ENGINEERING, AND ELECTRICAL ENGINEERING CONSTRUCTION DOCUMENTS.







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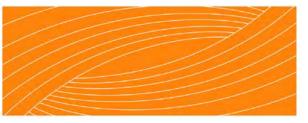
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A 09-06-18 STORMWATER	PLAN,
EROS & SED CO	
& COG SITE PL	AN
SCALE:	I" = 20' - 0"
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<ul> <li>Big 24 AM For A AME, THESE</li> <li>Big 24 AM For A AME, THESE</li> <li>Big 25 AM FOR A SMALL LEPES</li> <li>Big 26 AM FOR A SMALL LEPE</li></ul>		9-4-265(D)(1)	(I) 20" OAK
<ul> <li>THE ACT ONLY THE ACCOUNT OF ANY THE SECOND THE ACTION OF A ACT OF A DEVICE ANY ACCOUNT AN</li></ul>	ONE 24 OAK FOR 3 LARGE TREES		
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<ul> <li>Den 40 QU THE SAME THES</li> <li>THE ALL THES TORE ALL THES</li> <li>She H CORRESS TORE BLACKS</li> <li>She H CORRESS TORE BLACKS</li> <li>THE ALL THESE TORE BLACKS</li> <li>THE ALL THE ALL</li></ul>	ONE 24" OAK FOR 5 SMALL TREES		REQUIREMENTS PER THE CITY OF GREENVILLE
Provide 14 (Process per 2 damage)     Provide 14 (Process per 2 d	ONE 40" GUM FOR 5 SMALL TREES		ZONING REGULATIONS. COMPLETE PLANTING PLAN, DETAILS, NOTES AND SCHEDULE WILL BE PROVIDED
Def III "Proceeds FER & Setures     of a seture (char control     of a seture (char control     of a seture o	*** ONE 14" CYPRESS FOR 8 SHRUBS		
<ul> <li>E. REGLINED STREET THEE YEART THE RECORDER (S. G.A.MED + 2 PROVIDED) GREENE STREET - 229 LF 2 RECORDER (S. G.A.MED + 2 PROVIDED) (S. REGLINED YEART AND LEAR STREET AND LEAR STREET (S. G.A.MED + 2 PROVIDED) (S. REGLINED YEART AND LEAR STREET AND AND TOOL COMMON.</li> <li>I. SCHORT YEART AND LEAR STREET AND AND TOOL COMMON.</li> <li>I. SCHORT YEART AND LEAR STREET AND LEAR STREET AND AND LEAR STREET (S. REGLINED YEART AND LEAR STREET AND AND LEAR STREET (S. REGLINED YEART STREET STREET AND AND LEAR STREET (S. REGLINED AND AND LEAR STREET AND AND LEAR STREET (S. REGLINED AND AND LEAR STREET AND AND LEAR STREET (S. REGLINED AND AND AND LEAR STREET AND LEAR STREET (S. REGLINED AND AND LEAR STREET AND AND LEAR STREET (S. REGLINED AND AND AND AND LEAR STREET AND AND LEAR STREET (S. REGLINED AND AND AND AND LEAR STREET AND AND AND LEAR STREET AND AND LEAR STREET AND AND LEAR STREET AND AND LEAR STREET AND AND LEAR STREET AND AND AND LEAR STREET AND AND AND LEAR STREET AND AND LEAR STREET AND AND AND AND AND AND AND LEAR STREET AND AND AND AND AND AND AND AND AND AND</li></ul>	ONE 16" SYCAMORE FOR 8 SHRUBS		
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NOTE NOTE: A MIRAN PLANT SIZES SHALL BE IN ACCORDANCE WITH THE ZONING RECULATIONS AS TOLLOWS: E-ANTING MATERIAL TYPE MINUTES IN 10 (MECH-7) AND 21 CALPER I. LANCE TREE - SINGLE STEM 10 (MECH-7) AND 21 CALPER MINUTES IN THE STEM 10 (MECH-7) AND 21 CALPER MINUTES IN A STATE - STEM 10 (MECH-7) AND 21 CALPER MINUTES IN A STATE - STEM 10 (MECH-7) AND 21 CALPER MINUTES IN A STATE - STATE - STEM 10 (MECH-7) AND 21 CALPER MINUTES IN A STATE - STATE	NOT APPLICABLE - PROJECT IS ENTIRELY	WITHIN TOWN COMMON	
A MERULU PLANT SIZES SHALL BE IN ACCORDANCE WITH THE ZONING RECULATIONS AS FOLLOWS: PLANTAGE VALUES INTERNATIONS OF THE SAME AND	NONE	ITILITY OR DRAINAGE EASEMENTS:	
EACHING MATERIAL TYPE     MINULU PLANTING SZE       1. LARGE IREE - SINGLE STEM     10' (HEGHT) AND 2' CALPER       1. SUBJEL TREE     SUBJEL TREE       1. SWALL TREE     SUBJEL TREE       2. SWALL TREE     SUBJEL TREE       3. SHODD OF ANY PARKING AREA INCLUDING ANY DRIVEWAY, PARKING SPACE, DAVE ALLE ON THE NO. HE AND TREMANDED UNDER       3. SHODD OF ANY PARKING AREA INCLUDING ANY DRIVEWAY, PARKING SPACE, DAVE ALLE OF THENNIGH AREA, SHALL BE CONSTRUCT AN DRIVENT-TWE (75) FEET FOX AN DRIVENT OF THE CONSTRUCT AND AND THE TREE OF THE AND THE CONSTRUCT AND AND THE CONSTRUCT AND THE CONSTRUCT AND AND THE CONSTRUCT AND AND THE AND THE CONSTRUCT AND AND THE A		NCE WITH THE ZONING REGULATIONS AS	
I. LAKEE TREE - SINCLE STEM J. SHALL TREE SWALL TREE SWALL TREE SWALL TREE SWALL TREE SUCTON 94-287(a) WO PORTION OF AMERICANSE MATCHING THE AND	FOLLOWS:		
ULTI-STEM     10° (HEDRT)       2. SMAIL TREF     10° (HEDRT)       3. GHRLB     10° (HEDRT)       SCIDION 9-4-287(3)     10° (HEDRT)       3. NO PORTION OF ANY PARING ATEL, NOLLIPICE ANY DRIVED VARIED THAN ELECT IN AND LET COME AND ANY DRIVED VALLE TREE OR MOVED UNDER       2. SUBJECT AREA     10° (HEDRT)       2. NO PORTION OF ANY PARING ATEL, AND ANY DRIVED VARIES OR LIANS DRIVET FOR AND AND HER SECTOR, HALL RECOMMENT AND HER FORM THE FARTHELES IDDE OF THE CLOSES OF THE CLOSES OUTPER SECTOR AND DESCRIPTION AND HER SECTOR THE CONSTITUTE NON THE FARTHELES IDDE OF THE CLOSES OUTPER SECTOR AND DESCRIPTION AND HER SECTOR AND DESCRIPTION AND HER SECTOR THE CONSTITUTE NON THE FARTHELES (25) PERCENT OF THE CONSTITUTE NON THE FARTHELES IDDE OF THE CLOSES OUTPER SECTOR OF THE CLOSES OUTPER SECTOR OF THE CLOSES OUTPER DESCRIPTION AND HER DESCRIPTION OF AND HER DESCRIPTION AND HER DESCRIPTION OF AND HER DESCRIPTION OF AND HER DESCRIPTION AND HER AND AND HER DESCRIPTION AND HER AND AND HER SECTION 9-4-285 (b) OF THE CITY CODE.       4. NO LARGE TREES TO BE FLATTED WATERAL BANALES PROTOCIDED FROM STEL DESCRIPTION ADDRES AND			
S SHRUE     SHRUE     SECTION 9-4-267(3)      NO FORTION OF ANY PARKING AREA, INCLUDING ANY DEVEMANY, PARKING GRACE, DRIVE MISLE OF TURNING AREA, SHALL BE     LOCATED MORE THAN THERY (100) FET FORM AN ON-SITE SAMIL TERE OR MORE THAN SHRUTN-THYE (73) FET FORM AN     ON-SITE LARGE THEE, FOR LURGOSES OF THIS SECTIONS, THE MEASUREMENT SHALL BE FORM THE FARTHEST EDGE OF THE     SUBJECT AREA TO THE CENER OF THE CASE OF THE CLOSED CULLETING THEE.      SITE LANGE THES FLAT. (SEE NOTE ON TERM 10.)      D. THE FOLLOWIG VEGTATION WATERIALS, AS LISTED BY COMMON NAME, SHALL CONSTITUTE NOT MORE THAN TWENTY-FINE (25)     PERCINI OF THE TOTE AS LISTED BY COMMON NAME, SHALL CONSTITUTE NOT MORE THAN TWENTY-FINE (25)     PERCINI OF THE TOTAL REQUIREMENT FOR THE SECTION COMMON NAME, SHALL CONSTITUTE NOT MORE THAN TWENTY-FINE (25)     PERCINI OF THE TOTAL REQUIREMENT FOR THE SECTION COMMON NAME, SHALL CONSTITUTE NOT MORE THAN TWENTY-FINE (25)     PERCINI OF THE TOTAL REQUIREMENT FOR THE SECTION COMMON NAME, SHALL CONSTITUTE NOT MORE THAN TWENTY-FINE (25)     PERCINI OF THE TOTAL REQUIREMENT FOR THE SECTION COMMON NAME, SHALL CONSTITUTE NOT MORE THAN TWENTY-FINE (25)     PERCINI OF THE TOTAL REQUIREMENT FOR THE SECTION COMMON NAME, SHALL CONSTITUTE NOT MORE THAN TWENTY-FINE (25)     PERCINI OF THE COMMON NATERIALS HAVE BEEN NOTED     NATERIAL SHALE BE TORE TOTO MATERIALS HAVE BEEN NOTED     NATERIAL SHALE BE DESTINATE VEGETATON WATERIALS HAVE BEEN NOTED     NO LARCE TREES TO BE MAIL BE SOREFIND ON IS DESTINATED COMMON THE SECTION COMPONENT ACTIVITIES IN ACCORDANCE WITH     NO LARCE TREES TO BE PLANTED WITH SHALL SHALE BE PROTECTED FROM SITE DEVELOPMENT ACTIVITIES IN ACCORDANCE WITH     NO LARCE TREES TO BE PLANTED WITH SHALE ARCUMENT TO AND EXTENDING THE FUEL SITEET SEE WORTH OF ALL PARRING AREAS     SORETION COMPONENT ACTIVITY SUBCE TO BE ANDITACH TO AND EXTENDING THE FUEL SITEET SEE WORTH OF ALL PARRING AREAS     SORETION OF ANY AREAS ADDARCH TO AND EXTENDING THE FUEL SITEET FOR WORTH OF ALL PARRING AREAS     SORETION OF TAXE	MULTI-STEM	10' (HEIGHT)	
LOCADE VOR THAT THETY (30) FEET FROM AN ON-SITE SMALL THE OR MORE THAN SEVENTH-THAT (30) FEET FROM AN OR- ON-SITE LARGE THEE, TO REPORTORE OF THE LOCADEST OULD THAT SELLED FROM THE FARTHEST EDDE OF THE SUBJECT AREA TO THE CENTER OF THE LOCADEST OULD THAT SECTION. THAT SECTION SECTION THAT SECTION SECTION THAT SECTION SECTION THAT SECTION SECTION THAT SECTION SE			NDER
SUBJECT AREA TO THE CITIER OF THE BASE OF THE CLOSEST OUNLPYING THEE. C. STE PLAN, APPROVAL FROM THE CREATE ASSMENT HOLDER SHALL E. CONSTRUED AS APPROVAL OF ALL ENCROACHMENTS, AS SHOWN, ON THIS PLAN. (SEE NOTE ON THEM LID.) D. THE FOLLOWING VEGETATION MATERIALS, AS LISTED BY COMMON NAME, SHALL CONSTRUET NOT WORE THAN TWENTY-RIVE (28) PERCENT OF THE TOTAL REQUERATION MATERIALS ASS LISTED BY COMMON NAME, SHALL CONSTRUET NOT WORE THAN TWENTY-RIVE (28) LARCE TREE CATEGORY: ANY STOCKAN FEAR SHALL THE CALEGORY: ANY STOCKAN FEAR CAPTOLI FEAR CLEVELOR CATEGORY: EXCLOSED FEAR CLEVELOR FEAR CL	LOCATED MORE THAN THIRTY (30) FEET FROM	AN ON-SITE SMALL TREE OR MORE THA	AN SEVENTY-FIVE (75) FEET FROM AN
AS SHOWN. OR THIS PLAN. (SEE NOTE ON ITEM 1.D.) D. THE FOLLOWING VECETATION HATERIALS, AS USTED BY COMMON NAME. SHALL CONSTITUTE NOT MORE THAN TWENTY-TIVE (25) PERCENT OF THE TOTAL REQUIREMENT FOR THE SPECIFIC CATEGORY: LARGE THEF CATEGORY: REVER BRCH ANSTOCRAT PEAR BRAGHORD FLAR CAPTOL FPAR EVEROREEN SHRUE CATEGORY: REVER BRCH ANSTOCRAT PEAR CLEVELAND SQLEET PEAR EVEROREEN SHRUE CATEGORY: REVER BRCH ANSTOCRAT PEAR CLEVELAND SQLEET PEAR EVEROREEN SHRUE CATEGORY: REVER BRCH ANSTOCRAT PEAR CLEVELAND SQLEET PEAR EVEROREEN SHRUE CATEGORY: REVER BRCH ANSTOCRAT PEAR CLEVELAND SQLEET PEAR EVEROREEN SHRUE CATEGORY: REVER BRCH ANSTOCRAT PEAR EVEROREEN SHRUE CATEGORY: NOTA CATEGORY: REVER BRCH ANSTOCRAT PEAR EVEROREEN SHRUE CATEGORY: REVER BRCH ANSTOCRATICAL STOCK REVER BRCH ANSTOCRATICAL SHRUE SHRUE CATEGORY: REVER BRCH ANSTOCRATICAL SHRUE SHRUE AND AND AND ALL FIRE HYDRANTS IN ACCORDANCE WITH STATE BUILDING CODE. K VEGETATION WITHIN 10' OF BUILDING SHALL NOT COUNT TO AND SHR REQUIREMENTS. REVERTE PEAR BRCH BRCHAR BRCH BRCHAR BRCH BRCH BRCHAR BRCH BRCH BRCH BRCH BRCH BRCHAR BRCH BRCHAR BRCH BRCHAR BRCH	SUBJECT AREA TO THE CENTER OF THE BASE	OF THE CLOSEST QUALIFYING TREE.	
PERCENT OF THE TOTAL REQUIREMENT FOR THE SPECIFIC CATEGORY: LARCE THEE CATEGORY: NASTOCRAT PEAR BASTOCRAT PEAR EVERGREEN SHUE CATEGORY: RED TIP PHOTONIA E. DUMPSTER/COMPACTOR SHALL BE SCREENED ON 3 SDES IN ACCORDANCE WITH SECTION 9=4=268(L)) OF THE GTY CODE. H. NO LARCE TREES TO BE DEALTED WITHIN SANTARY SEWER OR WATERINE EASEMENTS. I. PARKING LOT AREA TO BE SCREENED IN ACCORDANCE WITH SECTION 9=4=258(L)) OF THE GTY CODE. PARKING AREA SCREENING. SALL DE INSTALLED WITHIN A TO FOOT AREA ADJACENT TO AND EXTENDING THE FULL STREET SDE WOTH OF ALL PARKING AREAS WHCH FRONT A VUBLIC OF PHAVAE STREET. J. MINIMUM OF 3 FEET CLEARANCE MUST BE MAINTAINED AROUND ALL FIRE HYDRAITS IN ACCORDANCE WITH STATE BUILDING CODE. K. VEGETATION WITHIN 10' OF BUILDING SHALL NOT COUNT TOWARD SITE REQUIREMENTS. EXISTING MATERIALS LEGEND: ALL ASPEN BENCH MARK BOR CONTROL FOR DOW BULCIFIE FOR SO STORM DEAL NOT COUNT TOWARD SITE REQUIREMENTS. EXISTING MATERIALS LEGEND: ALL ASPEN BENCH MARK TO THE REPROTECTION SO STORM DEAL PROCE CONCRETE PAD CONSTRUCTION FENCE SO STORM DEAL NOT BULCIFIE FOR DA SO STORM DEAL PROCE CONCRETE PAD CONSTRUCTION FENCE SO STORM DEAL PROCE CONCRETE PAD CONSTRUCTION FOR THE SO STORE PARKIN			IRUED AS APPROVAL OF ALL ENCROACHMENTS,
SMALL TREE CATEGORY:       ADSTOCRAT PEAR CAPTOL PEAR COMPACTION SUBSTITUE VEGETATION MATERIALS HAVE BEEN NOTED IN LOCORDANCE WITH SECTION 9-4-286(1)D OF THE CITY CODE, PARKING AREA SCREENING.         I. NO LARGE TREES TO BE PLANTED WITHIN SANITARY SEVER OR WATERLINE EASEMENTS.       Image: Captol PEAR CAPTOL PEAR CODE TO COMPARE STREET.         I. NO LARGE TREES TO BE PLANTED WITHIN SANITARY SEVER WHICH FRONT & FUELCO OR PRIVATE STREET.       Image: Captol PEAR CAPTOL PEAR CAPTO	•	•	TUTE NOT MORE THAN TWENTY-FIVE (25)
CAPTOL PEAR CLEVELOND SELECT PEAR RED TIP PHOTINIA E. DUMPSTER/COMPACTOR SHALL BE SCREENED ON 3 SIDES IN ACCORDANCE WITH SECTION <u>9-4-268 (h)</u> OF THE CITY CODE. F. EXISTING SUBSTITUTE VEGETATION MATERIALS HAVE BEEN NOTED INCLUDING THEIR SPECIFIC LOCATION(S), TYPE(S), AND SIZE(S). C. EXISTING SUBSTITUTE VEGETATION MATERIALS HAVE BEEN NOTED INCLUDING THEIR SPECIFIC LOCATION(S), TYPE(S), AND SIZE(S). C. EXISTING SUBSTITUTE VEGETATION MATERIALS HAVE BEEN NOTED INCLUDING THEIR SPECIFIC LOCATION(S), TYPE(S), AND SIZE(S). C. EXISTING SUBSTITUTE VEGETATION MATERIALS SHALL BE PROTECTED FROM SITE DEVELOPMENT ACTIVITIES IN ACCORDANCE WITH SECTION <u>9-4-268 (f)</u> OF THE CITY CODE. H. NO LARCE TREES TO BE PLANTED WITHIN SANITARY SEVER OR WATERLINE EASEMENTS. I. PARKING LOT AREA TO BE SCREENED IN ACCORDANCE WITH SECTION <u>9-4-2680(1)9</u> OF THE CITY CODE. PARKING AREA SCREENING. SHALL BE INSTALLED WITHIN A 16 FOOT AREA SHALL BE INSTALLED WITHIN A 16 FOOT AREA SHALL BE INSTALLED WITHIN A 16 FOOT AREA MICH FRONT A PUBLIC OR PRIVATE STREET. J. MINMUM OF 3 FEET CLEARANCE MUST BE MAINTAINED AROUND ALL FIRE HYDRANTS IN ACCORDANCE WITH STATE BUILDING CODE. K. VEGETATION WITHIN 10' OF BUILDING SHALL NOT COUNT TOWARD SITE REQUIREMENTS. EXISTING MATERIALS LEGEND: A SIN AREA UPHT A SIN AR			
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90% DESIGN SUBMISSION


### ADDRESS:

201 W 1ST ST, GREENVILLE, NC 27858 Tel. 252.329.4567

#### OWNER:



DESIGN TEAM:

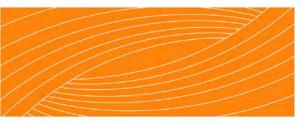

### **RHODESIDE & HARWELL**

510 King Street Suite 300 Alexandria, VA 22314 703-683-7447 ph 703-683-7449 fx www.rhodeside-harwell.com

### PERKINS+WILL

411 W. Chapel Hill St., Suite 200, Durham, NC 27701 919-433-5300 ph 919-433-5301 fx www.perkinswill.com

THE EAST GROUP GALLAGHER & ASSOCIATES BREE & ASSOCIATES LIGHT DEFINES FORMS INC ENGINEERING SOURCE

### NOT FOR CONSTRUCTION AND BIDDING

REVISION:	
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& COG SIT	E PLAN
SCALE:	I" = 20' - 0"
SHEET NAME:	
	SITE PLAN: VEGETATION
	VEGETATION
SHEET NUMBER:	
	C-102

DATE:

#### CONSTRUCTION SEQUENCE:

- 1. CONSTRUCT TEMPORARY CONSTRUCTION ENTRANCE/EXIT.
- 2. DISTURB LAND ONLY AS NECESSARY TO INSTALL TEMPORARY EROSION AND SEDIMENT CONTROL DEVICES. INSTALL ADDITONAL EROSION AND SEDIMENT CONTROL DEVICES AS NEEDED OR AS DIRECTED BY THE ENGINEER.
- 3. PERFORM SITE CLEARING AND DEMOLITION, IN ACCORDANCE WITH PLANS, INCLUDING REMOVAL OF EXISTING PAVEMENT, CURB & GUTTER, SIDEWALK, AGGREGATE BASE COURSE, TREES, SHRUBS, ETC. FROM THE SITE AND DISPOSE OF DEBRIS AT AN APPROVED SITE. PRIOR TO AND DURING DEMOLITION PHASE INSTALL APPROPRIATE EROSION AND SEDIMENTATION CONTROL MEASURES.
- 4. BEGIN GRADING THE SITE.
- 5. BEGIN EXCAVATION FOR UNDERGROUND CONSTRUCTION. CONSTRUCT UNDERGROUND IMPROVEMENTS.
- 6. INSTALL DRAINAGE INLETS AND STORM DRAINAGE PIPING WITH TEMPORARY INLET PROTECTION.
- 7. CONSTRUCT BUILDING AND SITE IMPROVEMENTS.
- 8. MAINTAIN EROSION AND SEDIMENTATION MEASURES DURING CONSTRUCTION. CHECK THE MEASURES FOR FAILURE AND AVAILABLE SEDIMENT STORAGE AFTER EACH SIGNIFICANT RAINFALL EVENT.
- MULCH AND SEED ALL DISTURBED AREAS. ANY SLOPES LEFT EXPOSED WILL WITHIN 14 CALENDAR DAYS OF COMPLETION OF ANY PHASE OF GRADING, BE PLANTED OR OTHERWISE PROVIDED WITH TEMPORARY OR PERMANENT GROUND COVER, DEVICES, OR STRUCTURES SUFFICIENT TO RESTRAIN EROSION.
   COMPLETE CONSTRUCTION OF ALL PROPOSED IMPROVEMENTS.
- 11. REMOVE ALL TEMPORARY EROSION CONTROL MEASURES ONCE PERMANENT VEGETATION IS ESTABLISHED.
- 12. TIME OF EXPOSURE IS APPROXIMATELY 10 MONTHS OR UNTIL COMPLETION AND STABILIZATION OF THE SITE. CONTRACTOR SHALL PREPARE FOR MAINTENANCE OF SITE EROSION & SEDIMENTATION MEASURES APPROPRIATE FOR EXPECTED DURATION

#### CITY OF GREENVILLE EROSION NOTES:

- SCHEDULING OF A PRECONSTRUCTION CONFERENCE WITH THE ENGINEERING DIVISION IS REQUIRED PRIOR TO INITIATING LAND DISTURBING ACTIVITIES. FOR SCHEDULING PLEASE CALL (252) 329-4467. A 24-HOUR NOTICE IS REQUIRED. NO PERSON MAY INITIATE A LAND DISTURBING ACTIVITY BEFORE NOTIFYING THE CITY OF THE DATE OF LAND DISTURBING ACTIVITY.
- 2. NO LAND DISTURBING ACTIVITY BEYOND THAT REQUIRED TO INSTALL APPROPRIATE EROSION CONTROL MEASURES MAY PROCEED UNTIL EROSION CONTROL MEASURES ARE INSPECTED AND APPROVED BY CITY OF GREENVILLE.
- 3. SEED AND MULCHING OR OTHERWISE PROVIDE GROUND COVER DEVICES OR STRUCTURES SUFFICIENT TO RESTRAIN EROSION FOR ALL EXPOSED SLOPES WITHIN 14 WORKING DAYS OF COMPLETING ANY PHASE OF GRADING.
- 4. CONTRACTOR SHALL INSPECT AND MAINTAIN AS NEEDED ALL EROSION CONTROL DEVICES ON A WEEKLY BASIS AND AFTER EACH 0.5" OVER 24-HOUR PERIOD RAINFALL EVENT. FAILURE TO KEEP EROSION CONTROL DEVICES IN GOOD WORKING ORDER MAY RESULT IN ISSUANCE OF A STOP WORK ORDER OR CIVIL PENALTIES UP TO \$5,000 PER DAY OF VIOLATION. STIES UTILIZING SEDIMENT TRAPS MUST ALSO SPECIFY A MAXIMUM DEPTH OF SEDIMENT PRIOR TO CLEAN OUT.
- 5. THE CITY ENGINEER RESERVES THE RIGHT TO REQUIRE ADDITIONAL EROSION CONTROL MEASURES SHOULD THE PLAN OR ITS IMPLEMENTATION PROVE TO BE INADEQUATE.
- 5. ACCEPTANCE AND APPROVAL OF THIS PLAN IS CONDITIONED UPON YOUR COMPLIANCE WITH FEDERAL AND STATE WATER QUALITY LAWS, REGULATIONS, AND RULES. IN ADDITION, LOCAL CITY AND COUNTY ORDINANCES OR RULES MAY ALSO APPLY TO THIS LAND-DISTURBING ACTIVITY. APPROVAL BY THE CITY DOES NOT SUPERCEDE ANY OTHER PERMIT OR APPROVAL. -PLEASE BE ADVISED OF THE RULES TO PROTECT AND MAINTAIN EXISTING BUFFERS ALONG WATERCOURSES IN THE NEUSE AND TAR RIVER BASINS. THESE RULES ARE ENFORCED BY THE DIVISION OF WATER QUALITY (DWQ). DIRECT ANY QUESTIONS ABOUT THE APPLICABILITY OF THESE RULES TO YOUR PROJECT TO THE REGIONAL WATER QUALITY SUPERVISOR, WASHINGTON REGIONAL OFFICE AT (252) 946-6481.
- 7. INSTALL INLET PROTECTION AROUND ALL CATCH BASINS, DROP INLETS OR INLET STRUCTURES WITHIN THE CONSTRUCTION/DISTURBED AREA.
- 8. CONTRACTOR SHALL PROVIDE MEASURES TO CLEAN ANY SOILS OR SEDIMENT THAT IS TRACKED, PLACED, OR FLOWS ONTO EXISTING PAVEMENT AND IMPROVED SURFACES THAT ARE TO REMAIN.
- 9. THIS PROJECT DISTURBS OVER 1-ACRE AND REQUIRES AN EROSION & SEDIMENT

### CONTROL PERMIT.

G	GROUND STABILIZATION			
SITE AREA DESCRIPTION	STABILIZATION TIME FRAME	STABILIZATION TIME FRAME EXCEPTIONS		
<ul> <li>PERIMETER DIKES, SWALES, DITCHES AND SLOPES</li> </ul>	7 DAYS	NONE		
<ul> <li>HIGH QUALITY</li> <li>WATER (HQW)</li> <li>ZONES</li> </ul>	7 DAYS	NONE		
* Slopes steeper Than 3:1	7 DAYS	IF SLOPES ARE 10' OR LESS IN LENGTH AND ARE NOT STEEPER THAN 2:1, 14 DAYS ARE ALLOWED.		
* SLOPES 3:1 OR FLATTER	14 DAYS	7 DAYS FOR SLOPES GREATER THAN 50 FEET IN LENGTH		
* ALL OTHER AREAS WITH SLOPES FLATTER THAN 4:1	14 DAYS	NONE (EXCEPT FOR PERIMETERS AND HQW ZONES)		

#### MAINTENANCE PLAN:

- 1. ALL EROSION AND SEDIMENT CONTROL PRACTICES WILL BE CHECKED FOR STABILITY AND SEPERATION FOLLOWING EVERY 0.5" OVER 24-HOUR PERIOD RAINFALL EVENT, BUT IN NO CASE LESS THAN ONCE EVERY WEEK. ANY NEEDED
- REPAIRS WILL BE MADE IMMEDIATELY TO MAINTAIN ALL PRACTICES AS DESIGNED. 2. SEDIMENT WILL BE REMOVED FROM BEHIND THE SEDIMENT FENCE WHEN IT BECOMES 0.5 FT DEEP AT THE FENCE. THE SEDIMENT FENCE WILL BE REPAIRED
- AS NECESSARY TO MAINTAIN A BARRIER. 3. TEMPORARY GRAVEL CONSTRUCTION ENTRANCE/ EXIT WILL BE INSPECTED
- PERIODICALLY. WHEN MUD BEGINS TO BUILD-UP, THE ENTRANCE WILL BE BLADED OFF REMOVING THE MUD. ADD NEW STONE TO ENTRANCE AS NEEDED.
- 4. ALL SEEDED AREAS WILL BE FERTILIZED, RE-SEEDED AS NECESSARY AND MULCHED ACCORDING TO SPECIFICATION IN THE VEGETATIVE PLAN TO MAINTAIN A VIGOROUS, DENSE VEGETATIVE COVER.
- 5. INSPECT INLET PROTECTION AT LEAST WEEKLY AND AFTER EACH SIGNIFICANT (1/2 INCH OR GREATER) RAINFALL EVENT AND REPAIR IMMEDIATELY. REMOVE SEDIMENT FROM THE SEDIMENT POOL AREA WHEN THE VOLUME IS DECREASED BY HALF.
- 6. REMOVE INLET SEDIMENT IF MORE THAN HALF FILLED WITH SEDIMENT AND DEBRIS, OR AS DIRECTED. REPLACE FABRIC IF TORN OR PUNCTURED TO >1/2" DIAMETER.



STORM DRAINAGE DESIGN NARRATIVE:

THE STORMWATER DRAINAGE DESIGN WILL PROVIDE SHEET FLOW WHERE POSSIBLE. STORM DRAINAGE INTERCEPTION IS REQUIRED AT CURB DISCHARGE POINTS, WALLS, AND AREAS PONDED BY WALKWAYS. THE RUNOFF INTERCEPTION POINTS WILL BE CONNECTED WITH SMALL DIAMETER PIPING AND CONVEYED TO AN EXISTING STORM SEWER AT THE NORTHEASTERN SITE MARGIN, AS SHOWN.

THE PROJECT IS ADJACENT TO THE FLOODWAY AND PEAK ATTENUATION CONTROL DOES NOT APPLY; THEREFORE, THIS PROJECT DOES NOT INCLUDE ENGINEERED STORMWATER CONTROLS. ALSO, PROJECTS IN THE UPTOWN DISTRICT ARE NOT REQUIRED TO PROVIDE ENGINEERED CONTROLS FOR NUTRIENT REDUCTION.

#### **GRADING NOTES:**


- 1. ALL VEGETATION AND TOPSOIL SHALL BE STRIPPED FROM FILL AREAS PRIOR TO PLACING FILL. ANY QUESTIONABLE OR UNSUITABLE SOIL CONDITIONS SHALL BE BROUGHT TO THE ATTENTION OF THE ENGINEER.
- 2. AFTER STRIPPING TOPSOIL AND PRIOR TO PLACING FILL, IT IS RECOMMENDED THAT ALL BUILDING, PARKING AND DRIVEWAY AREAS BE ROLLED WITH A VIBRATORY ROLLER TO CONSOLIDATE LOOSE SOILS IN THE UPPER SUBGRADE. COMPACTION TEST RESULTS OF AT LEAST 95 PERCENT OF THE STANDARD PROCTOR MAXIMUM DRY DENSITY WILL BE REQUIRED PRIOR TO ENGINEER'S APPROVAL FOR FILL PLACEMENT. CONTRACTOR SHALL CONTACT THE ENGINEER AND SCHEDULE A PROOF ROLL FOR SUBGRADE AND WHEN AGGREGATE BASE COURSE HAS BEEN INSTALLED.
- 3. ALL FILL SHALL BE COMPACTED TO AT LEAST 95% OF THE STANDARD PROCTOR MAXIMUM DRY DENSITY (ASTM D698).
- 4. ALL CULVERT CLEANOUT MUST BE DONE SUCH THAT THE SEDIMENT IS EITHER EXTRACTED OR BLOWN UPSTREAM FOR CLEANUP. UNDER NO CIRCUMSTANCES SHALL SEDIMENT BE BLOWN DOWNSTREAM.
- 5. GRADING CONTRACTOR SHALL TEMPORARY SEED AND MULCH ALL DISTURBED AREAS IN ACCORDANCE WITH THE SPECIFICATIONS WITHIN 14 DAYS OF COMPLETION OF GRADING WORK. UPON COMPLETION OF THE PROJECT, THE GENERAL CONTRACTOR SHALL INSTALL PERMANENT SEEDING AS OUTLINED IN THE SPECIFICATIONS. ALL DRAINAGE PIPES SHALL BE CLEANED BY THE GENERAL CONTRACTOR TO REMOVE ANY SEDIMENTS THAT HAVE ACCUMULATED.
- 6. ALL EXCESS TOPSOIL STRIP MATERIAL TO BE HAULED OFF-SITE AND DISPOSED OF AT AN APPROVED SITE.
- 7. ALL PLANTING AREAS SHALL BE BACKFILLED WITH TOPSOIL AND RAKED DOWN, REMOVING ALL CLODS AND ROOTS, AND LEFT READY FOR SEEDING AND PLANTING.
- 8. THIS SITE EXEMPT FROM STORMWATER ATTENUATION REQUIREMENTS DUE TO DISCHARGING DIRECTLY TO THE FLOODWAY.

EXISTING	MATERIALS	LEGEND:
AL	AREA LIGHT	

	AREA LIGHT
ASW	ASPHALT WALK
BNCH	BENCH
CP	CONCRETE PAD
CIP	CAST IRON PIPE
CSW	CONCRETE SIDEWALK
DI	DROP INLET
EB	ELECTRIC BOX
ĒMH	ELECTRICAL MANHOLE
EX.	EXISTING
ICV	IRRIGATION CONTROL VALVE
INV	INVERT
RCP	REINFORCED CONCRETE PIPE
SD	STORM DRAIN
SI	SIGN
SMH	SANITARY MANHOLE
SS	SANITARY SEWER
ТВМ	TEMPORARY BENCH MARK
TC	TRASH CAN
TYP.	
UE	ELECTRIC
ŬĠ	GAS
UGT	TELEPHONE/CABLE/FIBER OPTIC
Ŵ	WATER
ŴV	WATER VALVE
	YARD INLET
<b>YI</b> (500)	EXISTING CONTOUR
x 500.00	EXISTING SPOT ELEVATION (SURVEYED)
+(500.00)	EXISTING SPOT ELEVATION (SOLVETED)
	EXISTING SPUT ELEVATION (AT THE IN POINTS)

PROPOSED GRADING & DRAINAGE LEGEND:

	PROJECT LIMIT
	INLET PROTECTION
	TREE PROTECTION
xx	(6' HT CHAIN LINK)
- SF - SF - F - F - F - F - F - F - F -	- SILT FENCE SPOT ELEVATION TOP OF PAVEMENT TOP OF STEP BOTTOM OF STEP AREA DRAIN CLEAN OUT INVERT GRADE BRAKE CONTOUR SPOT ELEVATION

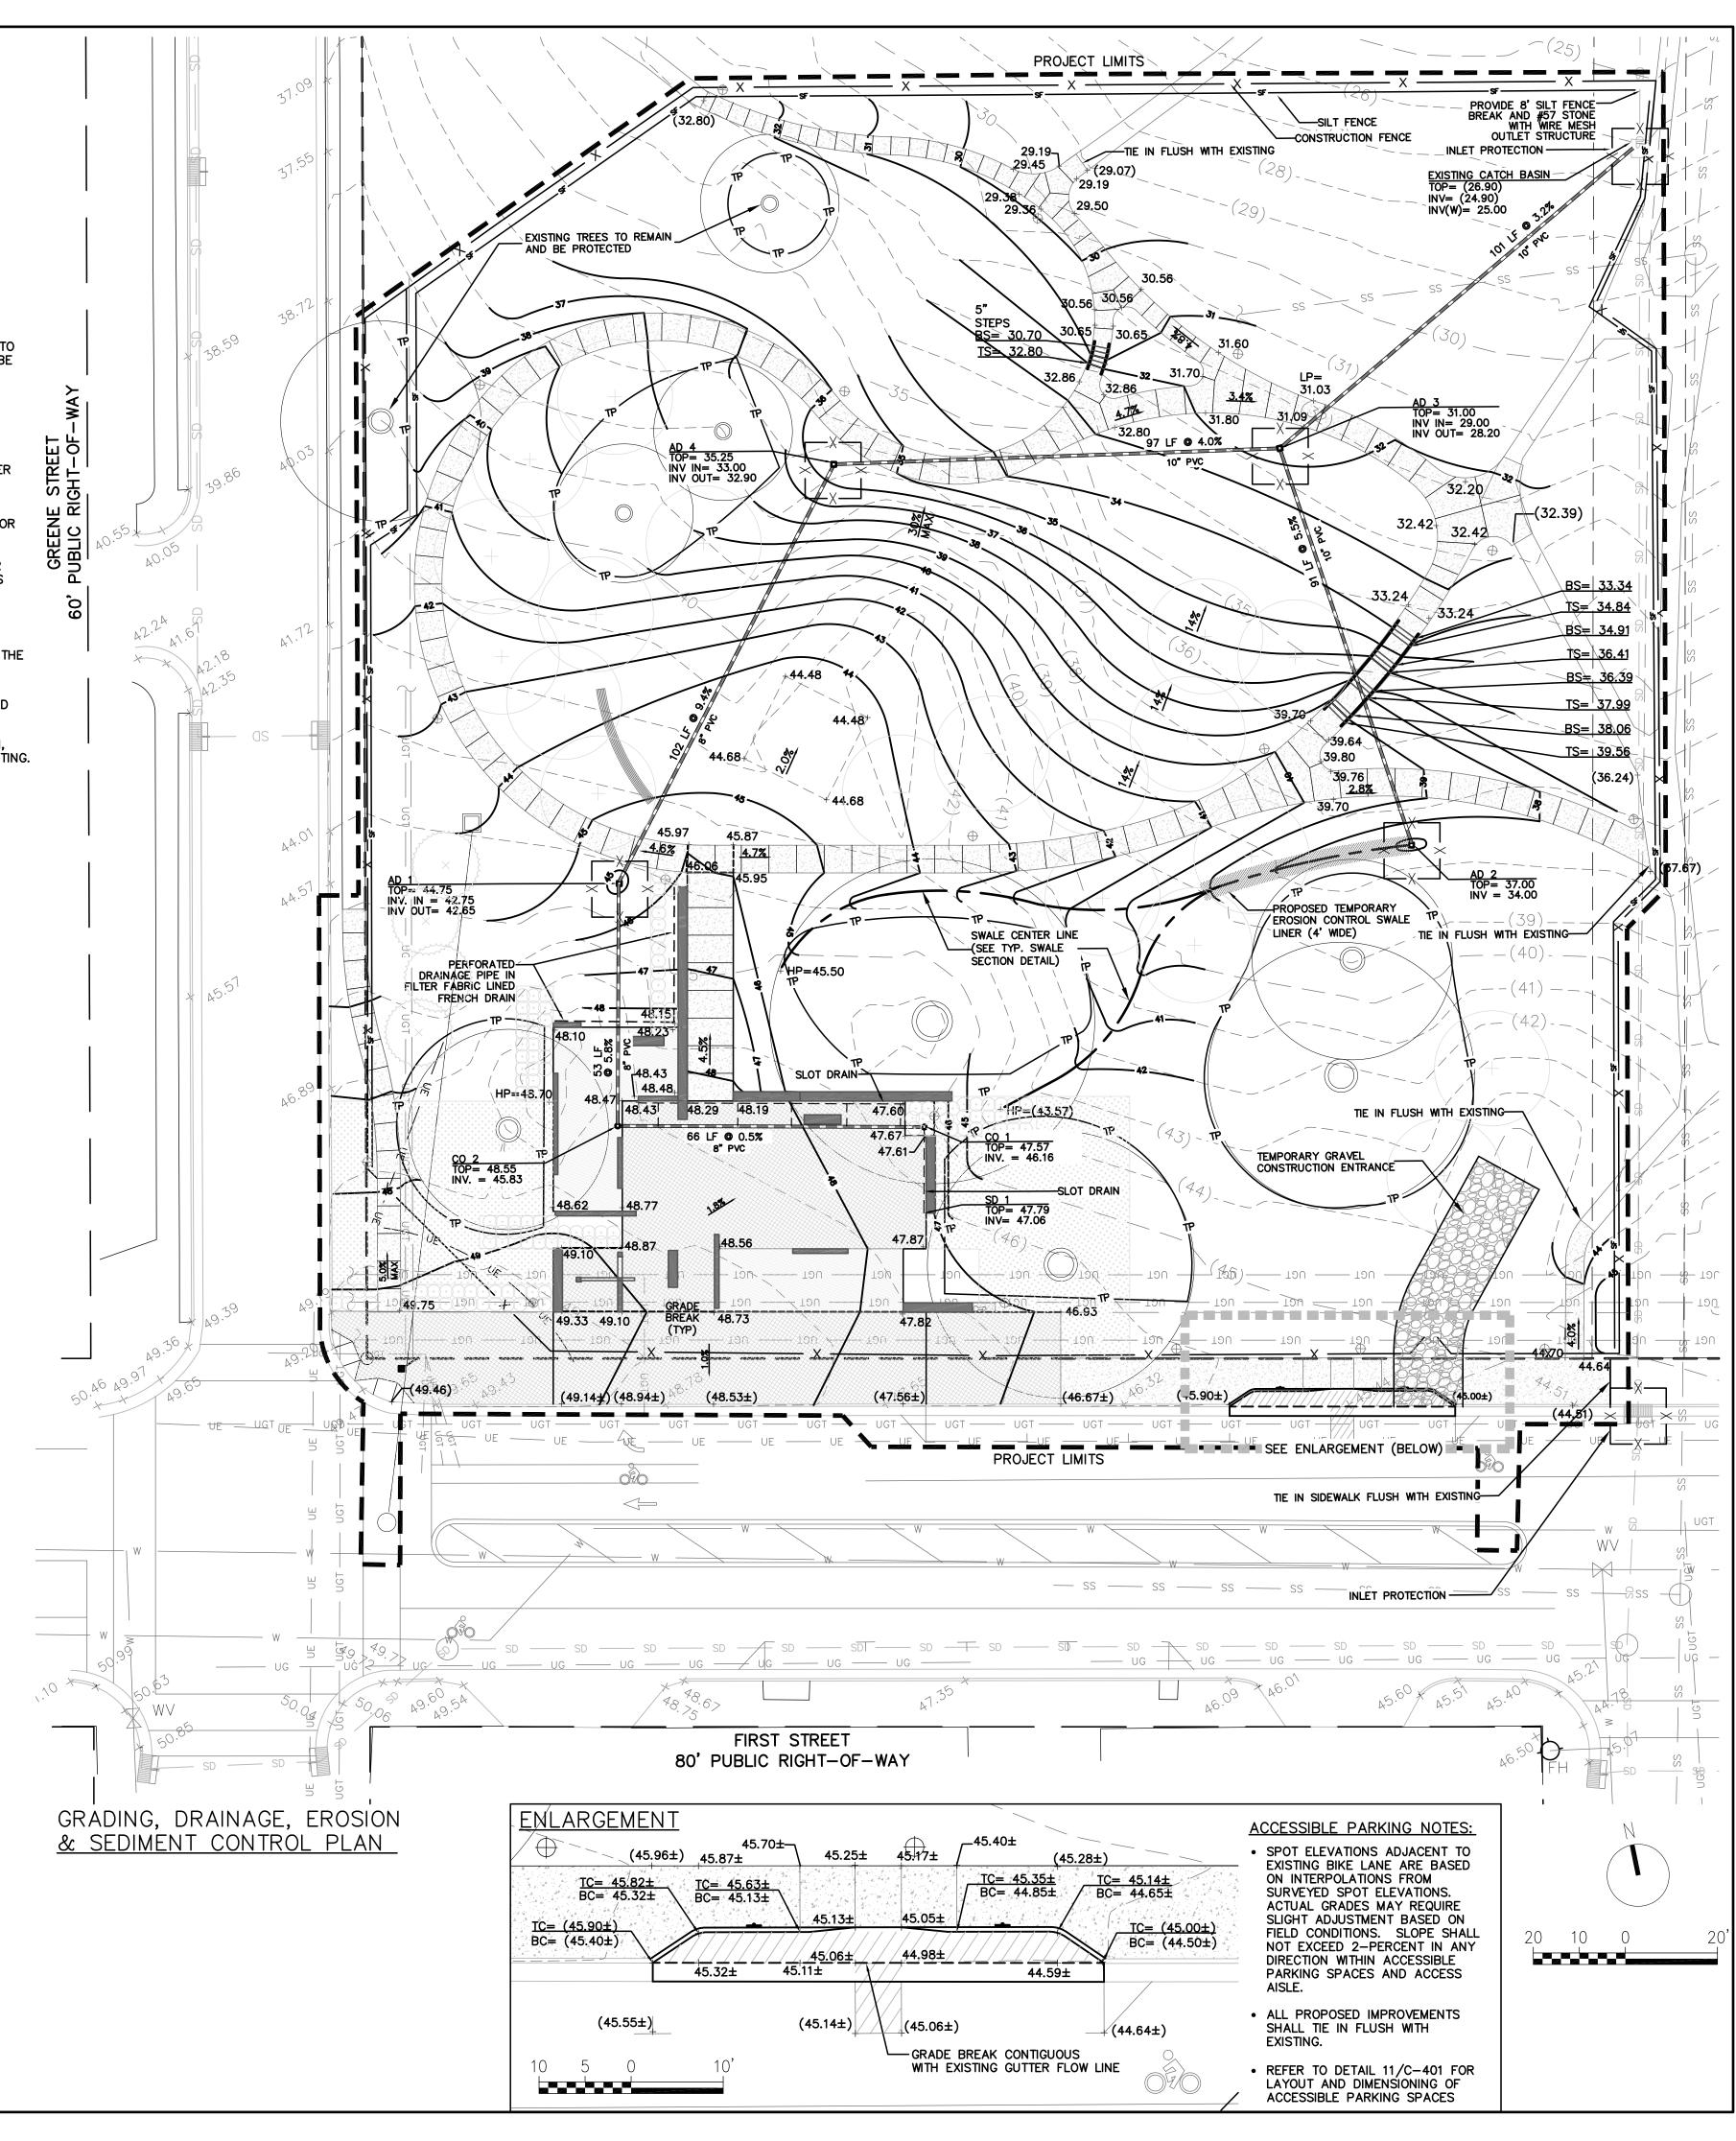

## GREENVILLE TOWN COMMON SYCAMORE HILL GATEWAY PLAZA

90% DESIGN SUBMISSION


### ADDRESS:

201 W 1ST ST, GREENVILLE, NC 27858 Tel. 252.329.4567

### OWNER:



DESIGN TEAM:

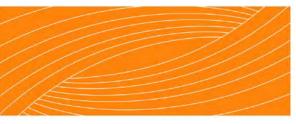

### **RHODESIDE & HARWELL**

510 King Street Suite 300 Alexandria, VA 22314 703-683-7447 ph 703-683-7449 fx www.rhodeside-harwell.com

### PERKINS+WILL

411 W. Chapel Hill St., Suite 200, Durham, NC 27701 919-433-5300 ph 919-433-5301 fx www.perkinswill.com

THE EAST GROUP GALLAGHER & ASSOCIATES BREE & ASSOCIATES LIGHT DEFINES FORMS INC ENGINEERING SOURCE

### NOT FOR CONSTRUCTION AND BIDDING

REVISION:	
<u>A 09-06-18 STORM</u>	1WATER PLAN,
EROS 8	& SED CONT PLAN,
& COG	SITE PLAN
SCALE:	I" = 20' - 0"
SHEET NAME:	
SHEET NAME:	ADING, DRAINAGE,
SHEET NAME:	ADING, DRAINAGE, OSION & SEDIMENT
SHEET NAME: GR	ADING, DRAINAGE,
SHEET NAME:	ADING, DRAINAGE, OSION & SEDIMENT
SHEET NAME: GR	ADING, DRAINAGE, OSION & SEDIMENT
SHEET NAME: GR	ADING, DRAINAGE, OSION & SEDIMENT CONTROL PLAN

UTILITY NOTES:


- 1. LOCATIONS OF EXISTING UTILITIES AS SHOWN ARE APPROXIMATE. CONTRACTOR SHALL FIELD VERIFY LOCATIONS AND COORDINATE CONNECTION WITH PROPER AUTHORITIES. CALL NC ONE-CALL CENTER, INC. AT 811 48 HOURS BEFORE ANY EXCAVATION IS BEGUN.
- 2. AS OF JAN. 1, 1986, ANYONE DIGGING WITH MECHANIZED EQUIPMENT IN HIGHWAY RIGHT-OF-WAY, PRIVATE UTILITY EASEMENTS, OR PUBLIC SPACES WILL BE REQUIRED BY NORTH CAROLINA LAW TO GIVE NOTICE OF THE PROPOSED EXCAVATION TO ALL EXISTING AREA UTILITIES AT LEAST 2 WORKING DAYS BEFORE STARTING TO DIG. THE UTILITY OWNER IS TO LOCATE ITS FACILITIES IN THE AREA OF THE PROPOSED EXCAVATION. UTILITY MEMBERS OF NC ONECALL CAN BE CONTACTED AT 811.
- 3. CONTRACTOR SHALL NOTIFY UTILITIES ENGINEER 48 HOURS PRIOR TO THE BEGINNING OF CONSTRUCTION. CONTRACTOR TO COORDINATE ALL EXISTING UTILITY TIE INS WITH THE UTILITY ENGINEER.
- 4. CONTRACTOR SHALL MAINTAIN COMPREHENSIVE (DEPTH AND HORIZONTAL LOCATIONS) FIELD "AS-BUILTS" FOR ALL INSTALLATIONS AND SUBMIT TO THE ENGINEER.
- ALL PERMITS AND FEES REQUIRED FOR CONSTRUCTION OF IMPROVEMENTS ARE THE RESPONSIBILITY OF THE GENERAL CONTRACTOR.
   SEE SHEET C-201 FOR INFORMATION ON GRADING.

CHLORINATION TAP & BACTERIOLOGICAL SAMPLE POINT (BSP) TEMPORARY SAMPLE POINT SHALL BE CONSTRUCTED OF THE SAME MATERIALS AS ONE INCH WATER SERVICES. SAMPLE POINTS SHALL BE INSTALLED SUCH THAT THE ANGLE BALL VALVE IS SECURELY LOCATED 36" MIN. ABOVE FINISH GRADE. UPON APPROVAL OF FINAL BACTERIOLOGICAL SAMPLES THE TUBING AND ANGLE BALL VAVLE SHALL BE REMOVED, THE CORPORATION STOP CLOSED AND A CAP PLACED ON THE CORPORATION STOP.

<u>EXISTING</u>	MATERIALS LEGEND:
AL	AREA LIGHT
ASW	ASPHALT WALK
BNCH	BENCH
CP	CONCRETE PAD
CIP	CAST IRON PIPE
CSW	CONCRETE SIDEWALK
DI	DROP INLET
EB	ELECTRIC BOX
EMH	ELECTRICAL MANHOLE
EX.	EXISTING
ICV	IRRIGATION CONTROL VALVE
INV	INVERT
RCP	REINFORCED CONCRETE PIPE
SD	STORM DRAIN
SI	SIGN
SMH	SANITARY MANHOLE
	SANITARY SEWER
ТВМ	TEMPORARY BENCH MARK
TC	TRASH CAN
TYP.	TYPICAL
UE	ELECTRIC
UG	GAS
UGT	TELEPHONE/CABLE/FIBER OPTIC
W	WATER
WV	WATER VALVE
<b>YI</b> (500)	YARD INLET
x 500.00	EXISTING CONTOUR
+(500.00)	EXISTING SPOT ELEVATION (SURVEYED)
+(000.00)	EXISTING SPOT ELEVATION (AT TIE IN POINTS)

SITE PREPARATION & DEMOLITION LEGEND:

PROJECT LIMIT

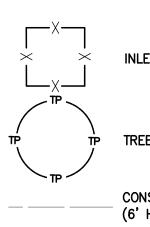


INLET PROTECTION

TREE PROTECTION

CONSTRUCTION FENCE (6' HT CHAIN LINK)



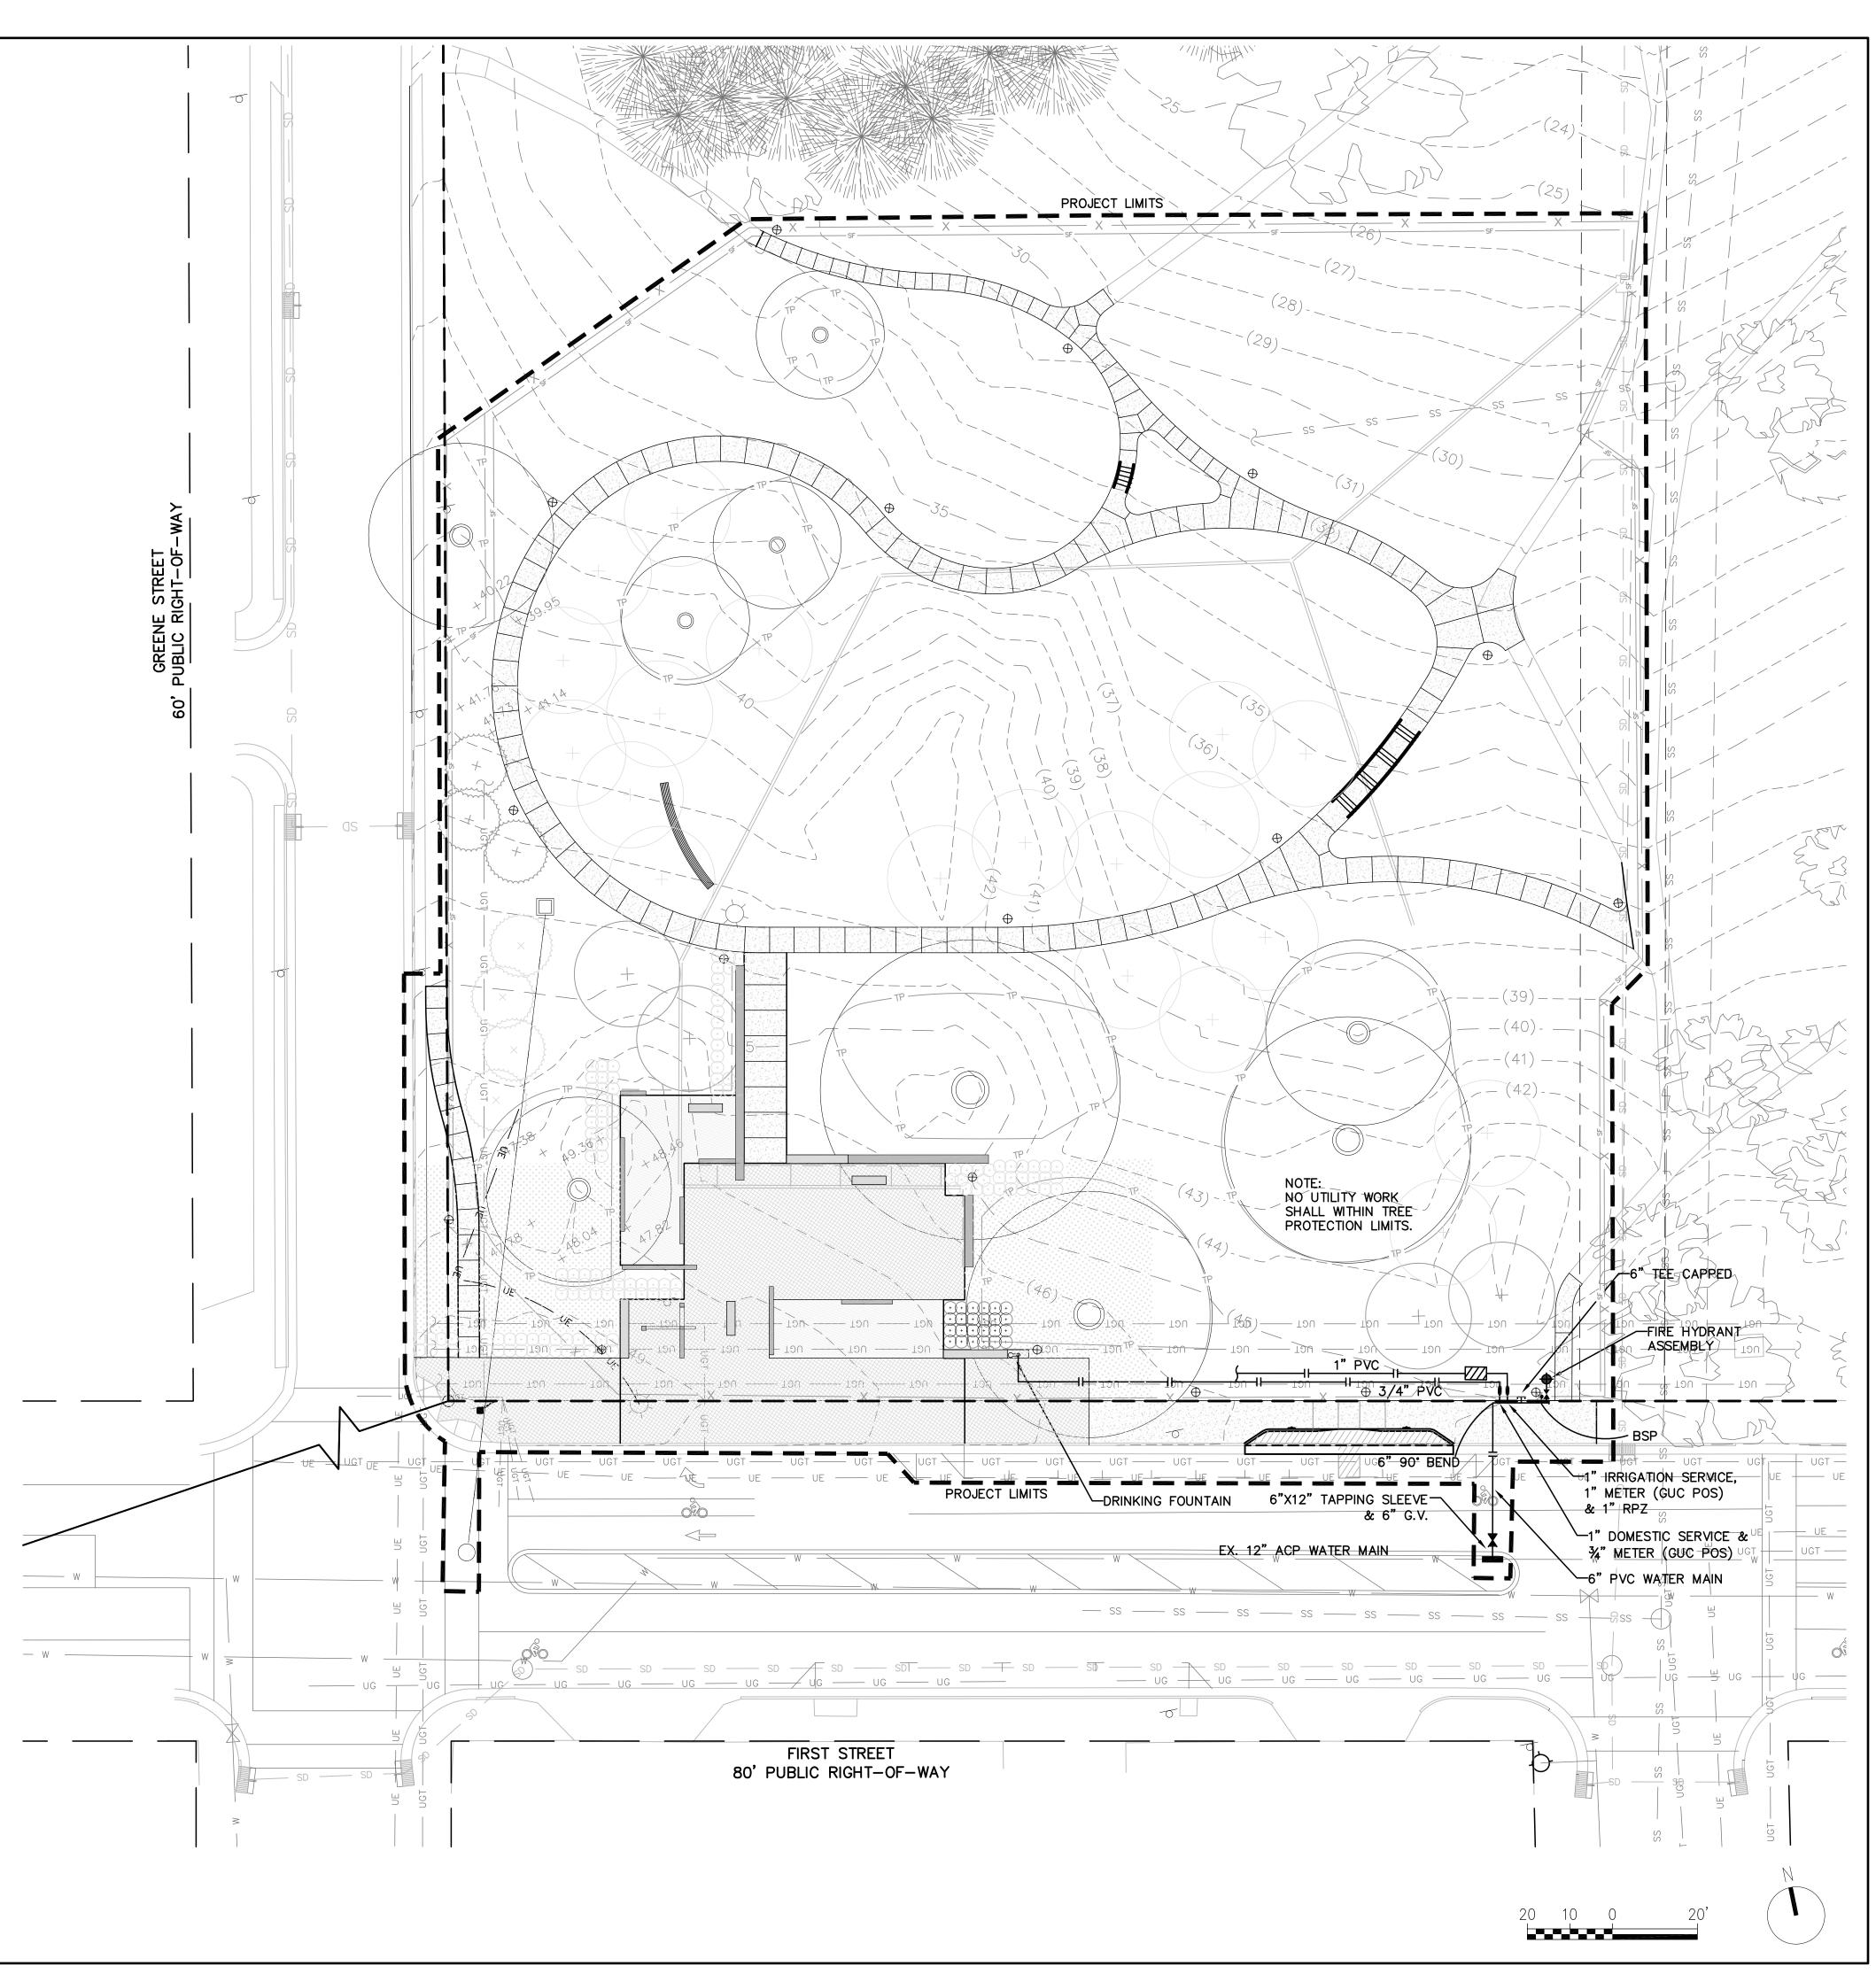

## GREENVILLE TOWN COMMON SYCAMORE HILL GATEWAY PLAZA

90% DESIGN SUBMISSION


### ADDRESS:

201 W 1ST ST, GREENVILLE, NC 27858 Tel. 252.329.4567

#### OWNER:



DESIGN TEAM:

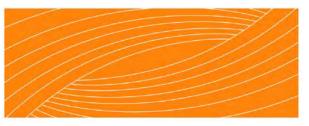

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### PERKINS+WILL


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THE EAST GROUP GALLAGHER & ASSOCIATES BREE & ASSOCIATES LIGHT DEFINES FORMS INC ENGINEERING SOURCE

### NOT FOR CONSTRUCTION AND BIDDING

REVISION:	
A 09-06-18 STORMW	ATER PLAN,
	ED CONT PLAN <u>,</u>
& COG SIT	E PLAN
SCALE:	I'' = 20' - 0''
SHEET NAME:	
	UTILITY PLAN: WATER SERVICE
SHEET NUMBER:	
	C-301


DATE:

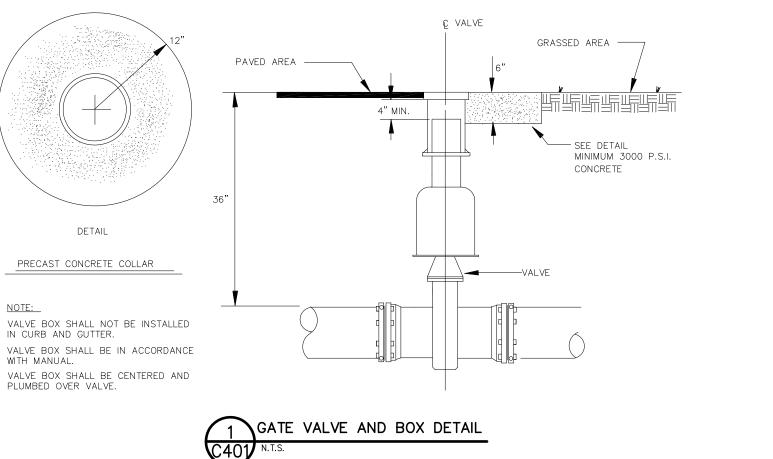


#### RESULTANT THRUST AT FITTING AT 150 PSI WATER PRESSURE

TOTAL POUNDS					
NOM. PIPE	DEAD END	90° BEND	45° BEND	22-1/2* BEND	11-1/4* BEND
DIA. 4"	2,700	3.800	2,100	1,100	530
6"	5,600	8,000	4,300	2,200	1,100
8"	9,700	13,600	7,400	3,800	1,900
10"	14,500	20,500	11,100	5,700	2,900
12"	20,500	29,000	15,700	8,000	4,000
14"	27,600	39,000	21,100	11,000	5,400
16"	35,700	50,400	27,300	14,000	7,000
18"	44,800	63,400	34,400	17,500	8,800
20"	55,000	77,000	42,100	21,500	10,800
24"	78,500	110,000	60,000	31,600	15,400
30"	120,600	170,600	92,300	47,100	23,600
36"	172,800	244,400	132,300	67,500	33,900
42"	233,300	330,000	178,600	91,000	45,700
48"	304,000	430,000	232,700	118,600	59,600
54"	384,100	543,200	294,000	149,000	75,300

TYPES OF THRUST BLOCKING

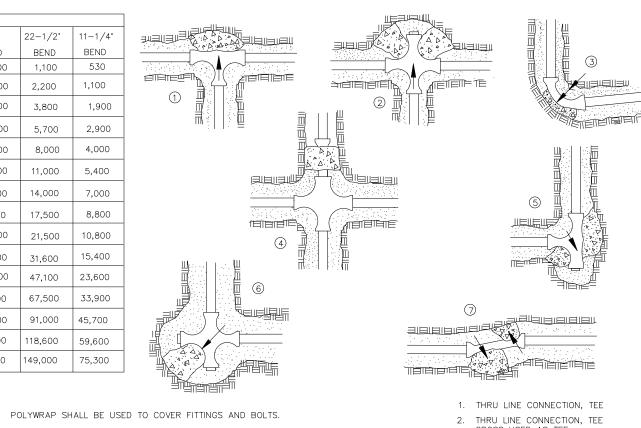


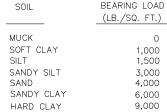


_B./SQ. FT.)	
0	
1,000	
1,500	
3,000	
4,000	
6.000	


TO DETERMINE THE SIZE OF A CONCRETE THRUST BLOCK, DIVIDE THE TOTAL FORCE BY THE BEARING VALUES OF THE SOIL. THE QUOTIENT WILL BE THE SIZE OF THE BEARING AREA OF THE THRUST BLOCK IN SQUARE FEET. APPROXIMATE VALUES FOR VARIOUS TYPES OF SOIL ARE LISTED IN TABLE. NO RESPONSIBILITY CAN BE ASSUMED FOR THE ACCURACY OF THE DATA IN THIS TABLE DUE TO THE WIDE VARIATION OF BEARING LOAD CAPABILITIES FOR EACH SOIL TYPE.

ieiie	
1.	THRU LINE CONNECTION, TEE
2.	THRU LINE CONNECTION, TEE CROSS USED AS TEE
3.	DIRECTION CHARGE, ELBOW
4.	CHANGE LINE SIZE, REDUCER
5.	DIRECTION CHANGE, TEE USED AS ELBOW
6.	DIRECTION CHANGE, CROSS USEE AS ELBOW
7.	DIRECTION CHANGE

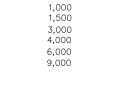



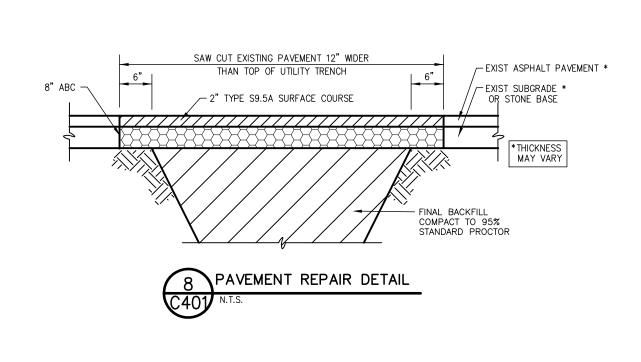

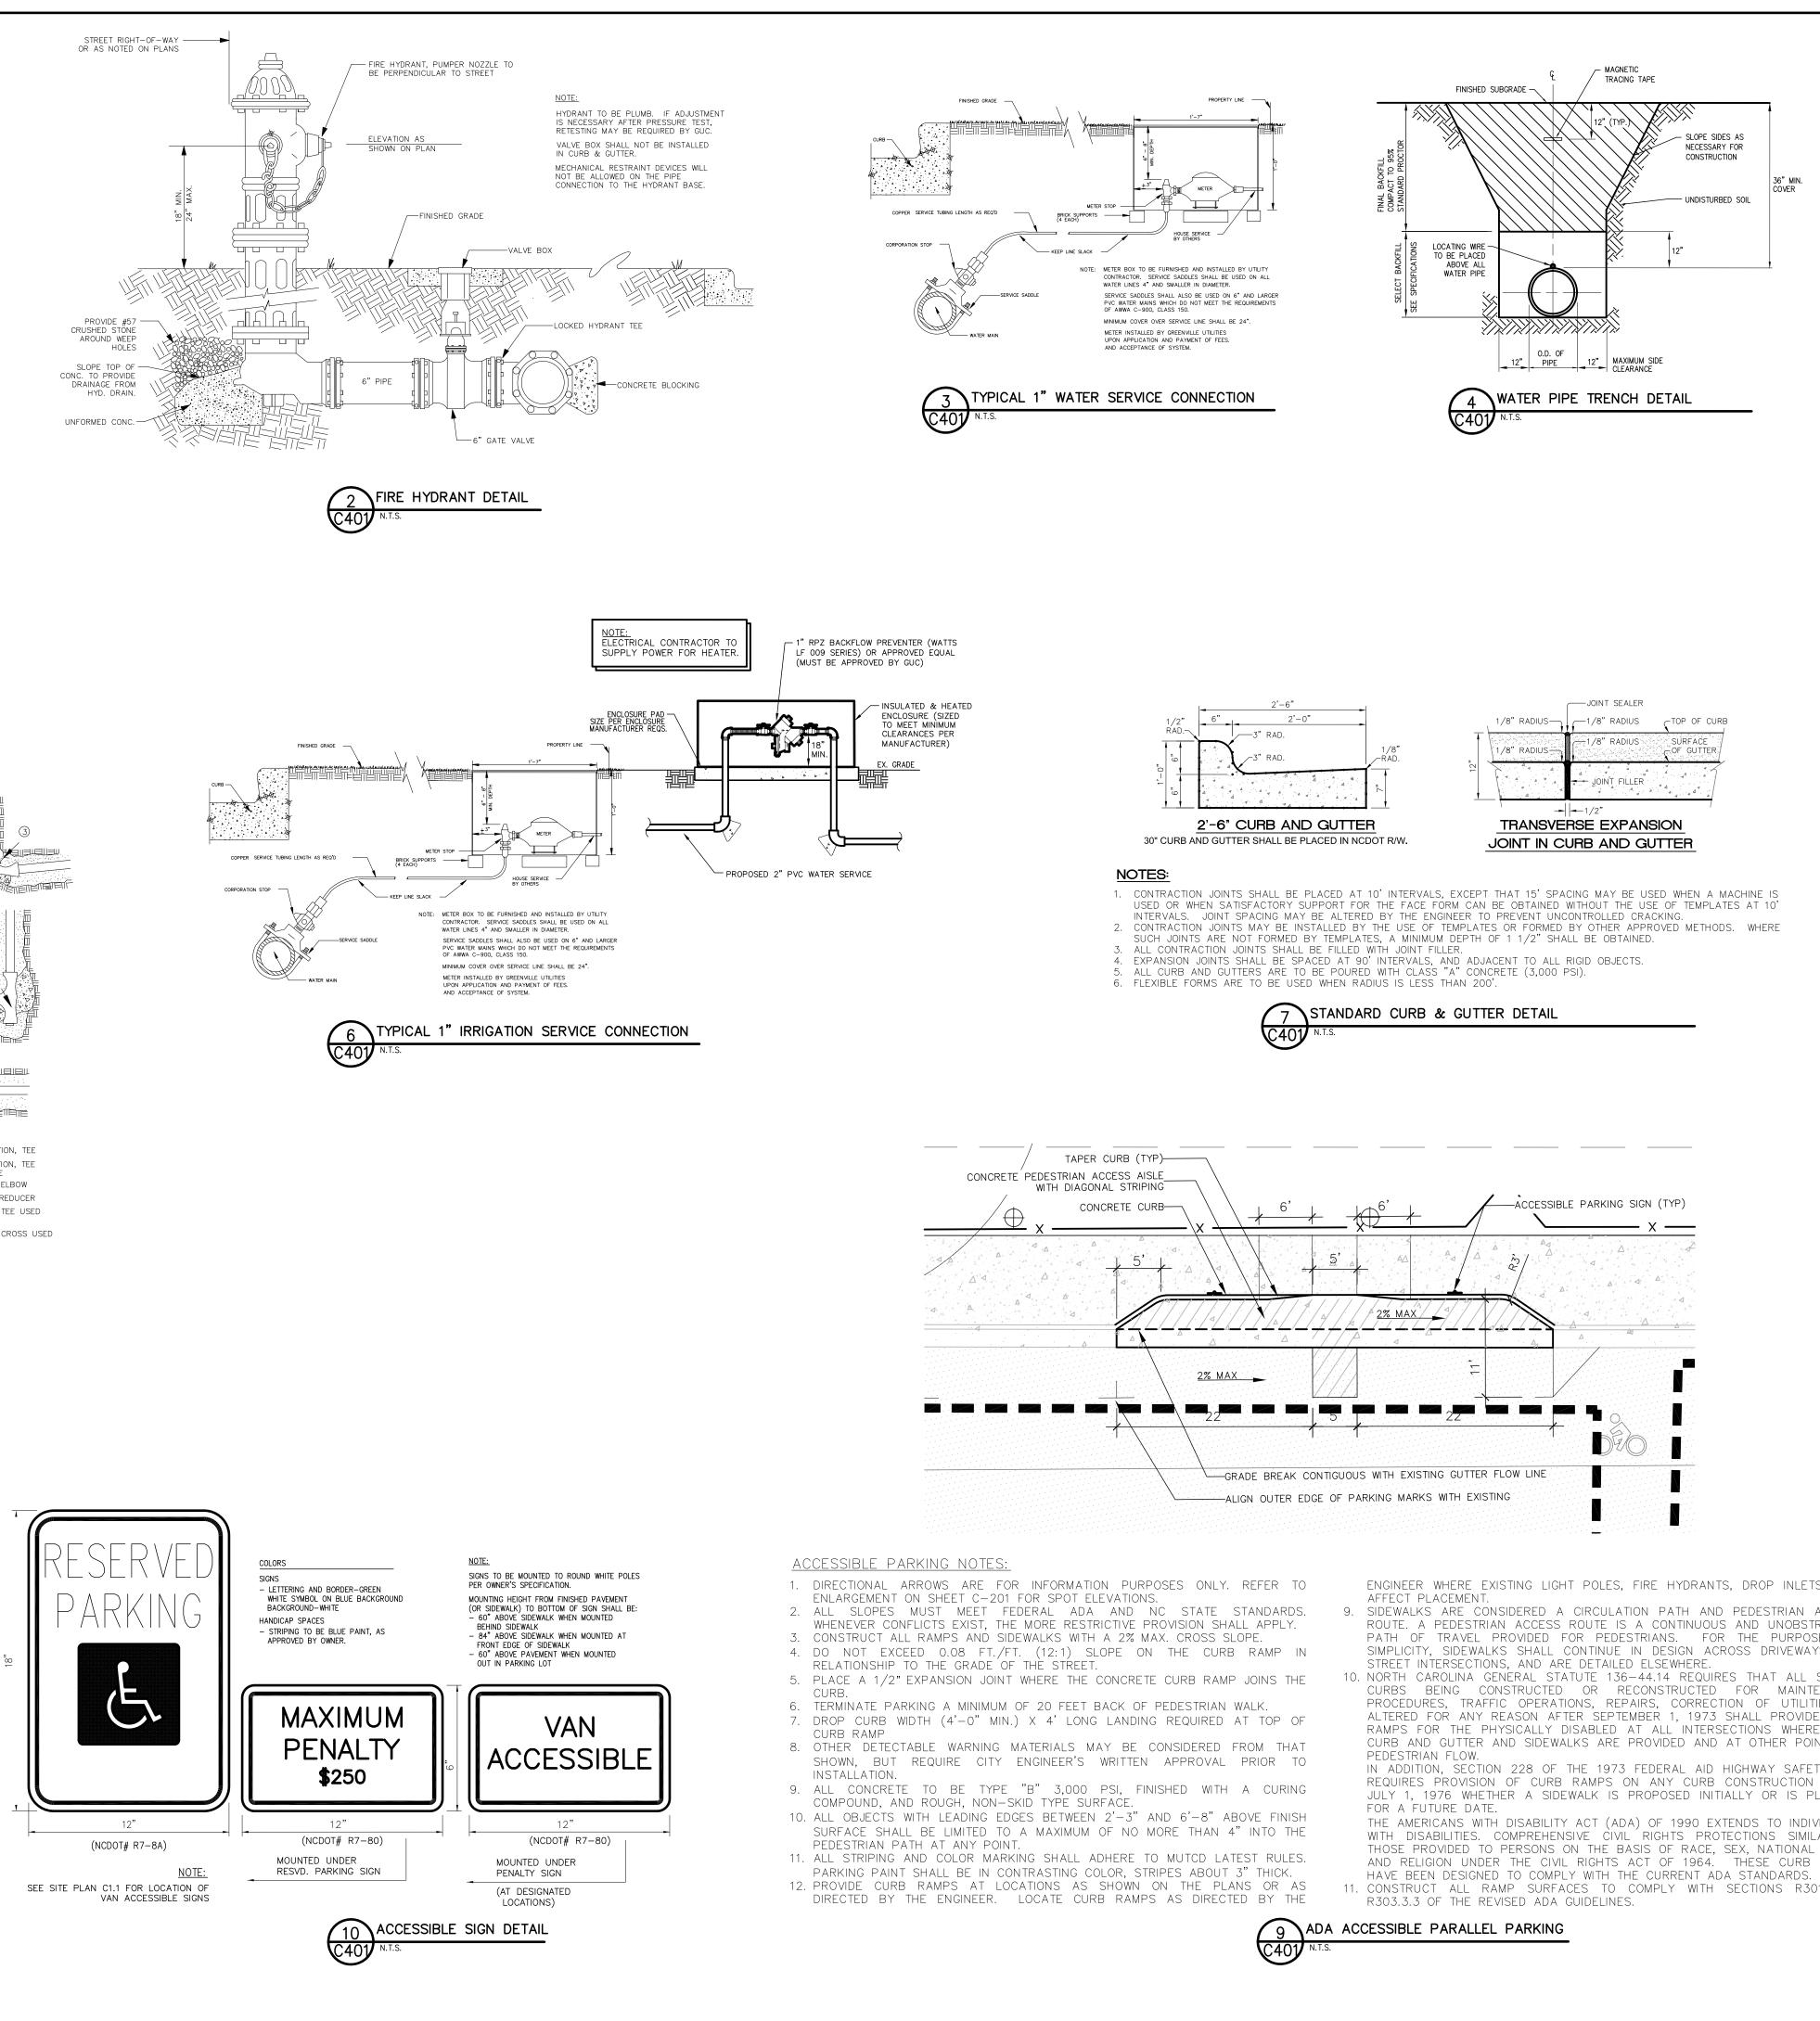

ENGINEER WHERE EXISTING LIGHT POLES, FIRE HYDRANTS, DROP INLETS, ETC.

9. SIDEWALKS ARE CONSIDERED A CIRCULATION PATH AND PEDESTRIAN ACCESS ROUTE. A PEDESTRIAN ACCESS ROUTE IS A CONTINUOUS AND UNOBSTRUCTED PATH OF TRAVEL PROVIDED FOR PEDESTRIANS. FOR THE PURPOSES OF SIMPLICITY, SIDEWALKS SHALL CONTINUE IN DESIGN ACROSS DRIVEWAYS AND

10. NORTH CAROLINA GENERAL STATUTE 136-44.14 REQUIRES THAT ALL STREET CURBS BEING CONSTRUCTED OR RECONSTRUCTED FOR MAINTENANCE PROCEDURES, TRAFFIC OPERATIONS, REPAIRS, CORRECTION OF UTILITIES OR ALTERED FOR ANY REASON AFTER SEPTEMBER 1, 1973 SHALL PROVIDE CURB RAMPS FOR THE PHYSICALLY DISABLED AT ALL INTERSECTIONS WHERE BOTH CURB AND GUTTER AND SIDEWALKS ARE PROVIDED AND AT OTHER POINTS OF

IN ADDITION, SECTION 228 OF THE 1973 FEDERAL AID HIGHWAY SAFETY ACT REQUIRES PROVISION OF CURB RAMPS ON ANY CURB CONSTRUCTION AFTER JULY 1, 1976 WHETHER A SIDEWALK IS PROPOSED INITIALLY OR IS PLANNED

THE AMERICANS WITH DISABILITY ACT (ADA) OF 1990 EXTENDS TO INDIVIDUALS

WITH DISABILITIES. COMPREHENSIVE CIVIL RIGHTS PROTECTIONS SIMILAR TO THOSE PROVIDED TO PERSONS ON THE BASIS OF RACE, SEX, NATIONAL ORIGIN AND RELIGION UNDER THE CIVIL RIGHTS ACT OF 1964. THESE CURB RAMPS

11. CONSTRUCT ALL RAMP SURFACES TO COMPLY WITH SECTIONS R301 AND

## GREENVILLE TOWN COMMON **SYCAMORE HILL GATEWAY PLAZA**

90% DESIGN SUBMISSION


### ADDRESS:

201 W 1ST ST, GREENVILLE, NC 27858 Tel. 252.329.4567

OWNER:



DESIGN TEAM:

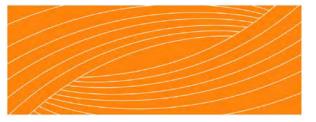

### **RHODESIDE & HARWELL**

510 King Street Suite 300 Alexandria, VA 22314 703-683-7447 ph 703-683-7449 fx www.rhodeside-harwell.com

### PERKINS+WILL


411 W. Chapel Hill St., Suite 200, Durham, NC 27701 919-433-5300 ph 919-433-5301 fx www.perkinswill.com


THE EAST GROUP **GALLAGHER & ASSOCIATES** BREE & ASSOCIATES LIGHT DEFINES FORMS INC ENGINEERING SOURCE


### NOT FOR CONSTRUCTION **AND BIDDING**


REVISION:	
A 09-06-18 STORMWATER PLAN,	
EROS & SED CONT PLAN,	
& COG SITE PLAN	
SCALE: AS SHOV	VN
SHEET NAME: SITE DETAIL	
UTILITY AND VEHICUL	
	~11
SHEET NUMBER:	

 $\mathbf{C-40}$ SEPTEMBER 26 2018

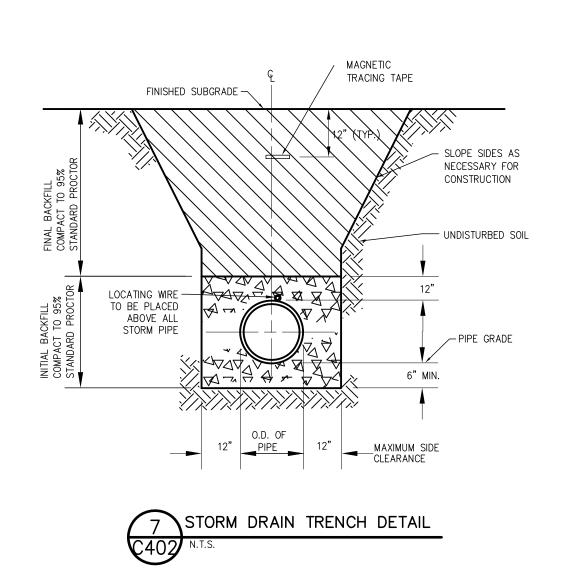

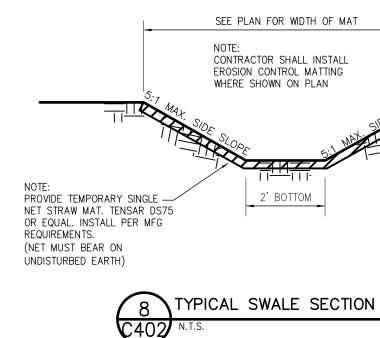

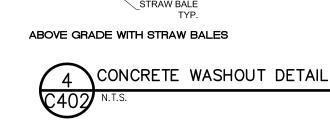

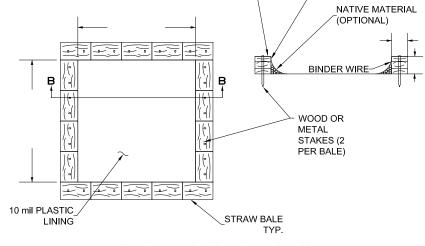



STRAW BALE

PLYWOOD

48" X 24"〜 PAINTED WHITE



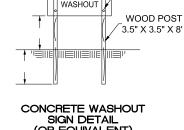

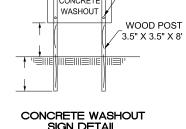

\_BLACK LETTERS

/-LAG SCREWS


10 mil PLASTIC

NOTES:

MAINTENANCE :

REACHING 75% CAPACITY.

6" HEIGHT

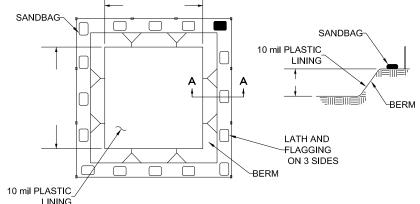

1. ACTUAL LAYOUT TO BE DETERMINED IN THE FIELD BUT NOT WITHIN 50FT

OF A PROPOSED/ EXISTING CATCH BASIN AND/ OR INLETS, TOP OF

BANK OF PERENNIAL STREAM, SURFACE WATER BODY, OR WETLAND.

2. A CONCRETE WASHOUT SIGN SHALL BE INSTALLED IN CLOSE PROXIMITY OF THE AREA AND SHALL BE CLEARLY VISIBLE.

OF IHE AREA AND SHALL BE CLEARLY VISIBLE.
3. GEOMEMBRANE BASIN LINER SHALL CONSIST OF A POLYPROPLENE OR POLYETHYLENE 10 MIL THICK GEOMEMBRANE.
4. HOLES, DEPRESSIONS OR OTHER GROUND DISTURBANCE CAUSED BY THE REMOVAL OF THE TEMPORARY CONCRETE WASHOUT FACILITIES SHALL BE

1. MAINTAIN WASHOUT STRUCTURE TO PROVIDE ADEQUATE CAPACITY PLUS A MINIMUM OF 12 INCHES. REMOVE AND DISPOSE HARDENED CONCRETE AND RETURN THE STRUCTURE TO A FUNCTIONAL CONDITION AFTER


BACKFILLED, REPAIRED, AND STABILIZED TO PREVENT EROSION.


INSPECT WASHOUT STRUCTURE FOR DAMAGE AND MAINTAIN FOR EFFECTIVENESS WEEKELY.


5. PROVIDE 2" SAND LAYER TO CONCRETE WASHOUT PIT.

3. REMOVE CONCRETE STRUCTURE AND SIGN ON PROJECT COMPLETION,

DISPOSE CONCRETE IN APPROVED LANDFILL SITE OR RECYCLE. 4. GRADE THE EARTH MATERIAL TO MATCH EXISTING CONTOURS AND SEED ACCORDINGLY TO PLANT SCHEDULE. MULCH AREA ACCORDINGLY.

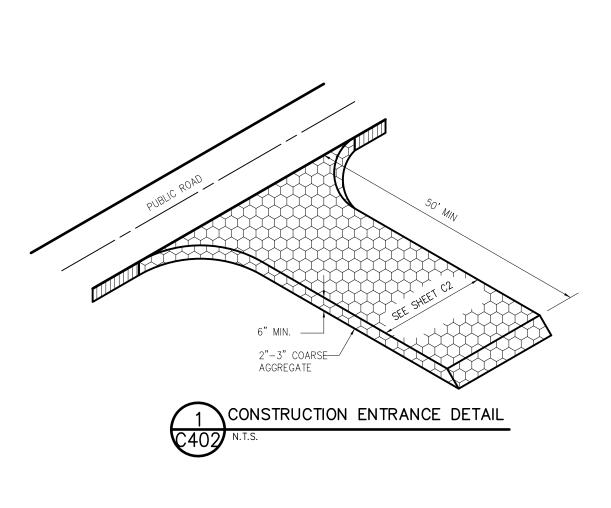

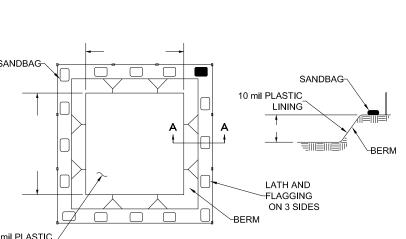

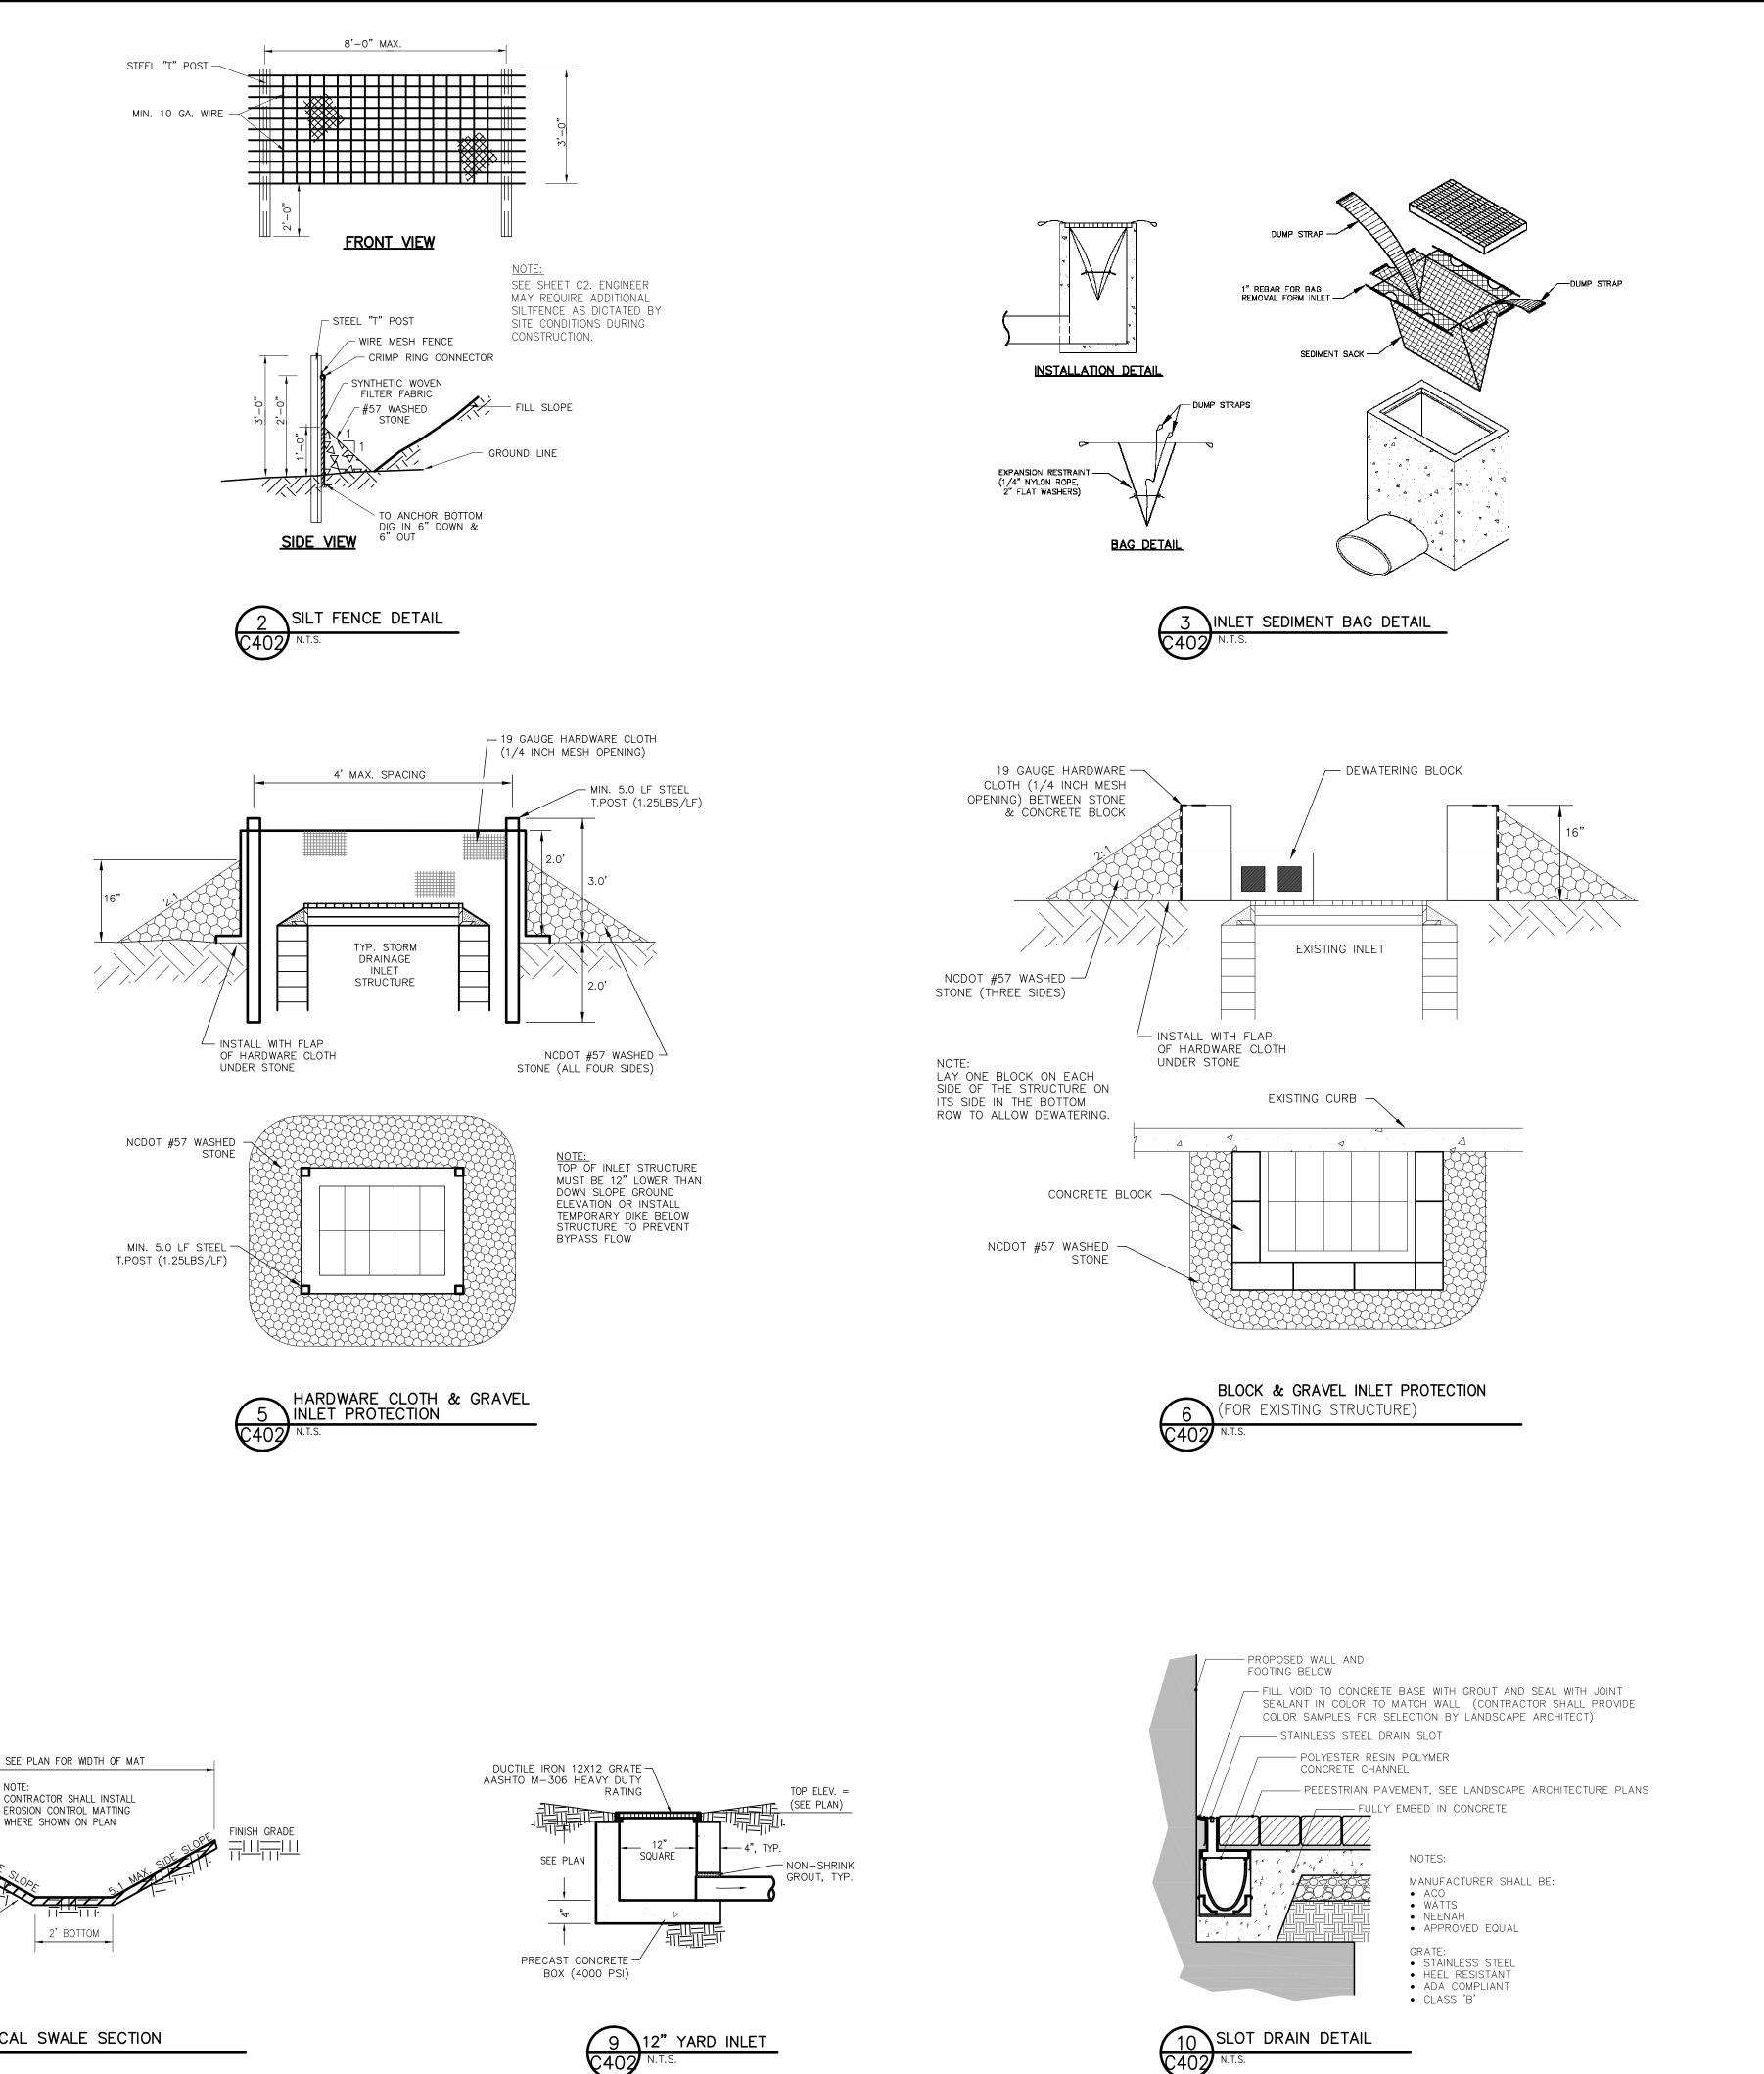

## GREENVILLE TOWN COMMON **SYCAMORE HILL GATEWAY PLAZA**

90% DESIGN SUBMISSION


### ADDRESS:

201 W 1ST ST, GREENVILLE, NC 27858 Tel. 252.329.4567

OWNER:



DESIGN TEAM:

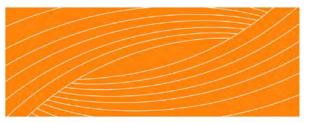

#### **RHODESIDE & HARWELL** 510 King Street

Suite 300 Alexandria, VA 22314 703-683-7447 ph 703-683-7449 fx www.rhodeside-harwell.com

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411 W. Chapel Hill St., Suite 200, Durham, NC 27701 919-433-5300 ph 919-433-5301 fx www.perkinswill.com


THE EAST GROUP GALLAGHER & ASSOCIATES BREE & ASSOCIATES LIGHT DEFINES FORMS INC ENGINEERING SOURCE

### NOT FOR CONSTRUCTION AND BIDDING

REVISION:	-
A 09-06-18 STORMWATER PLAN,	
EROS & SED CONT PLAN,	
& COG SITE PLAN	
SCALE: AS SHOWN	-
SHEET NAME: SITE DETAILS:	-
EROSION & SEDIEMENT	
CONTROL AND STORMWATER	
SHEET NUMBER:	-

DATE:

C-402 SEPTEMBER 26 2018

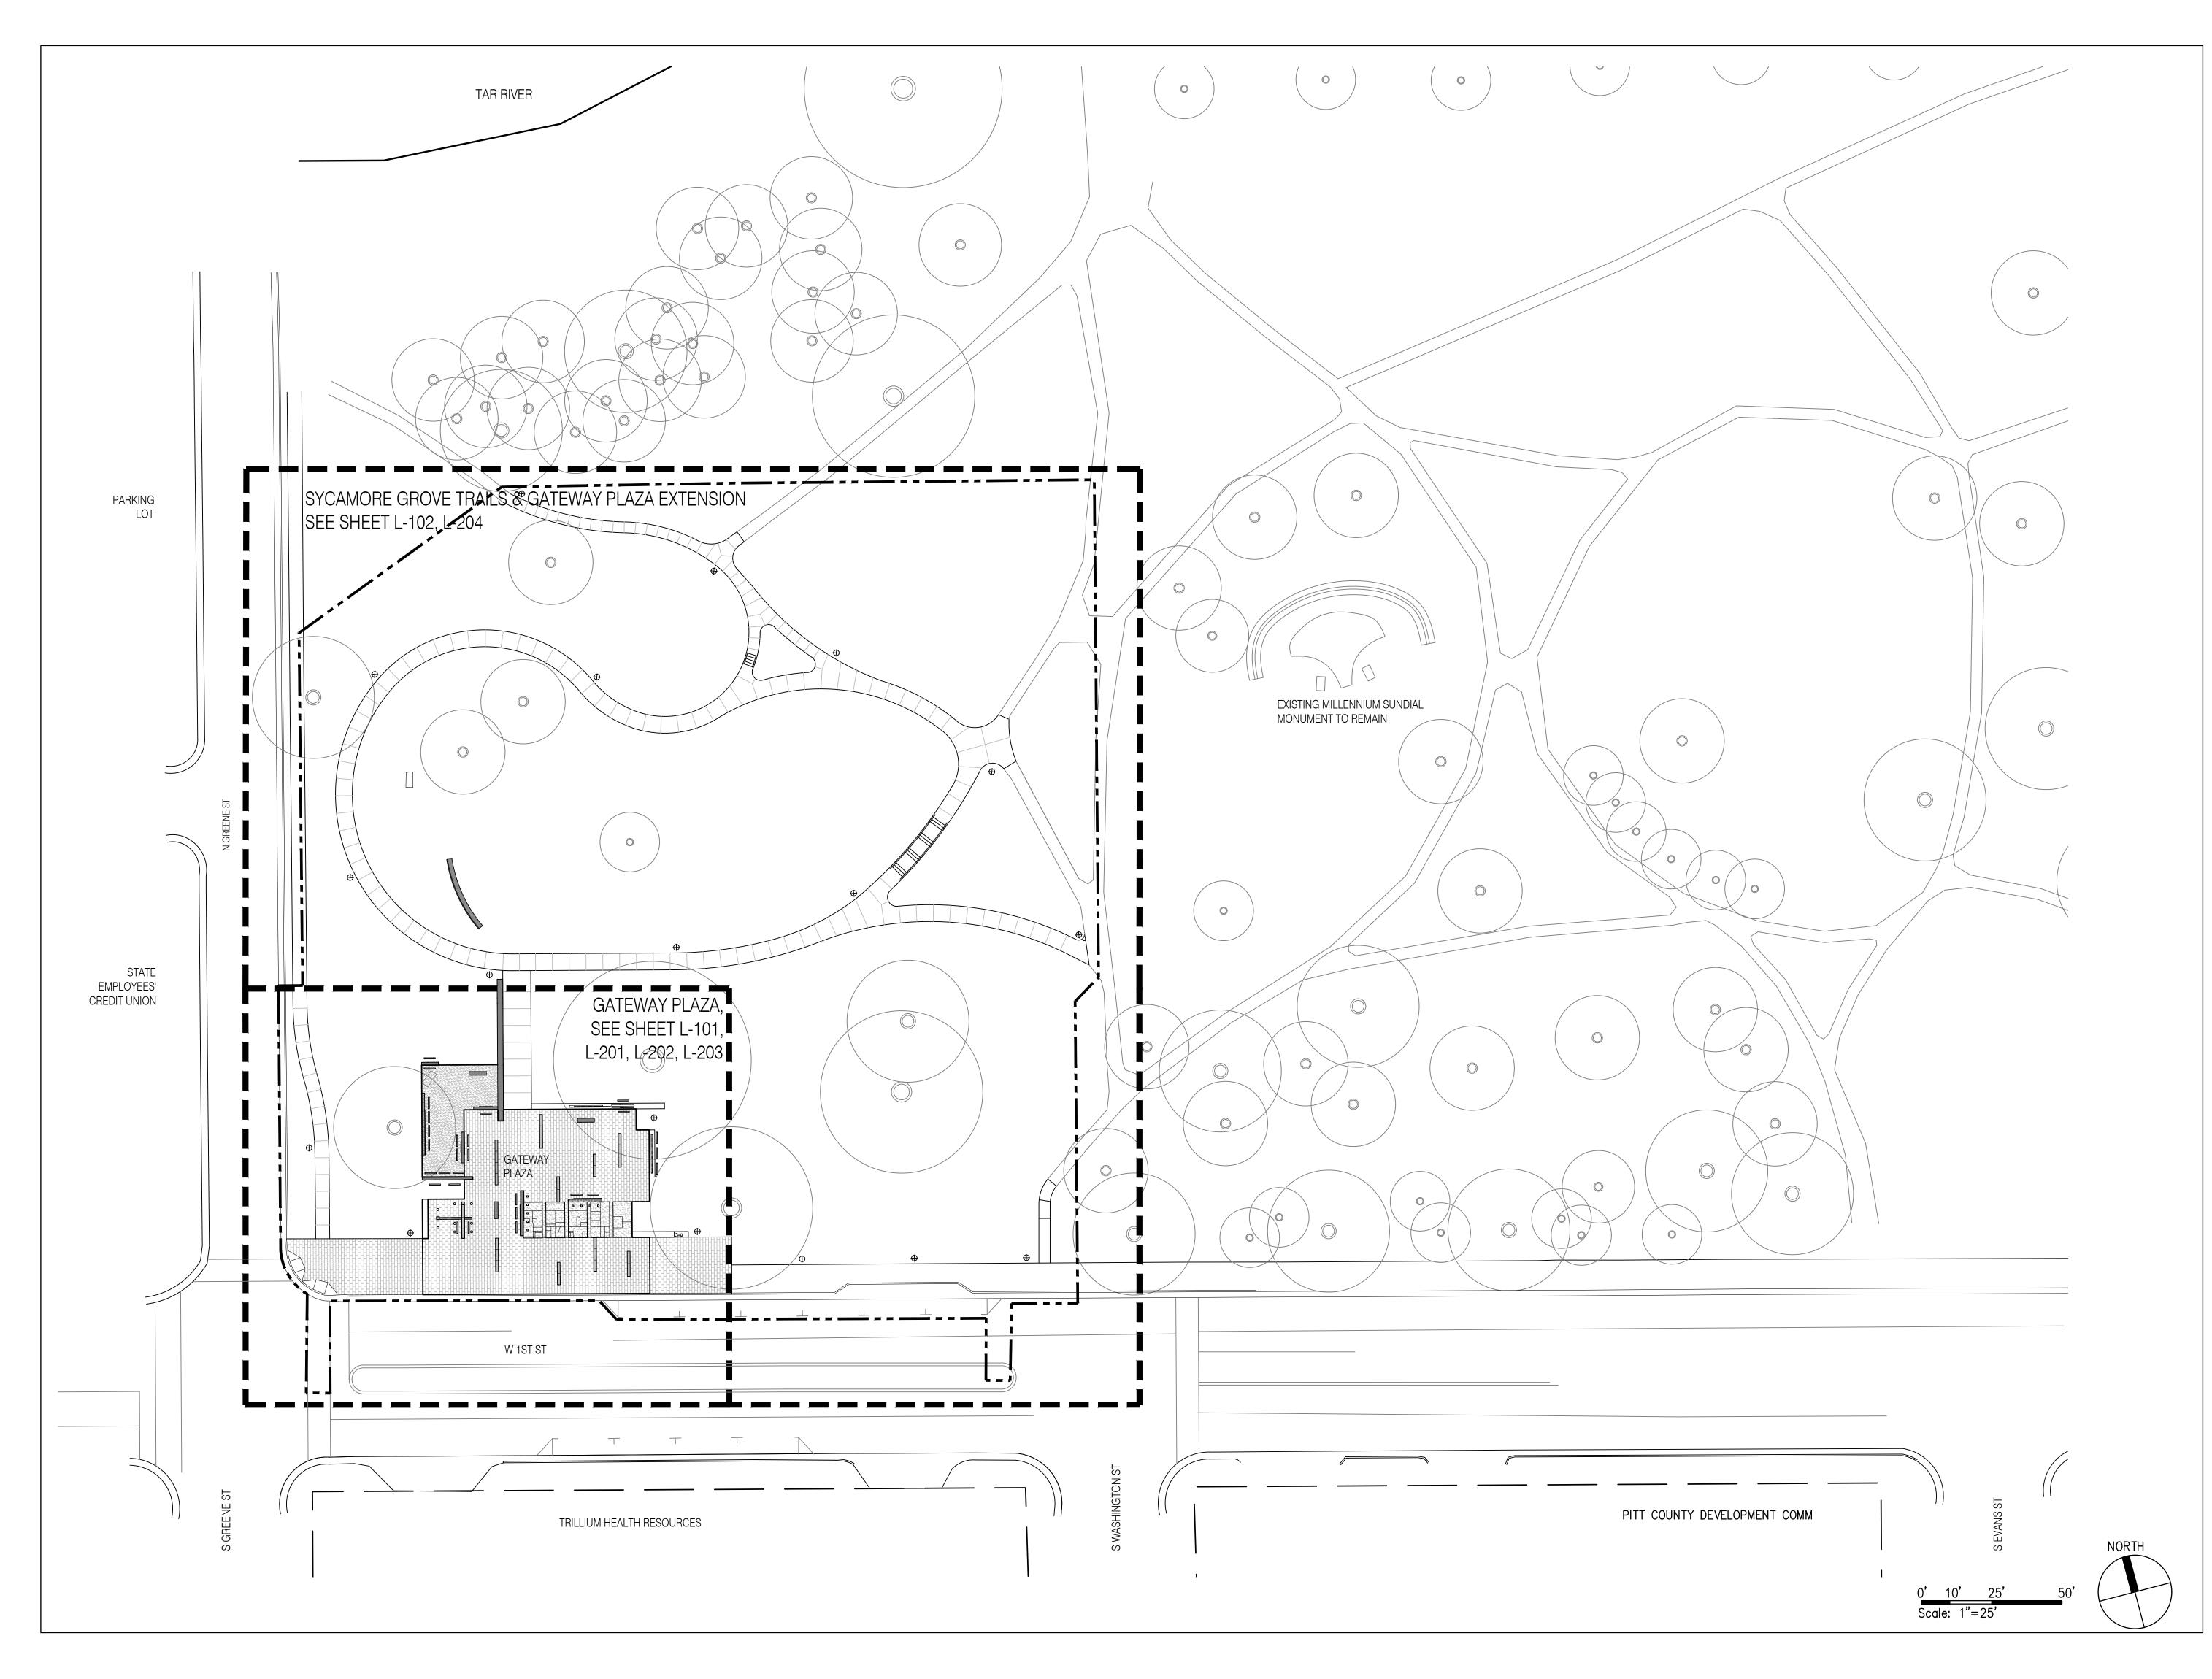

90% DESIGN SUBMISSION


### ADDRESS:

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OWNER:



DESIGN TEAM:

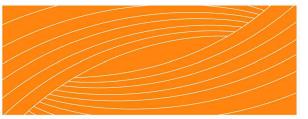

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## PERKINS+WILL


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THE EAST GROUP GALLAGHER & ASSOCIATES BREE & ASSOCIATES LIGHT DEFINES FORMS INC ENGINEERING SOURCE

### NOT FOR CONSTRUCTION OR BIDDING

SHEET NUMBER:



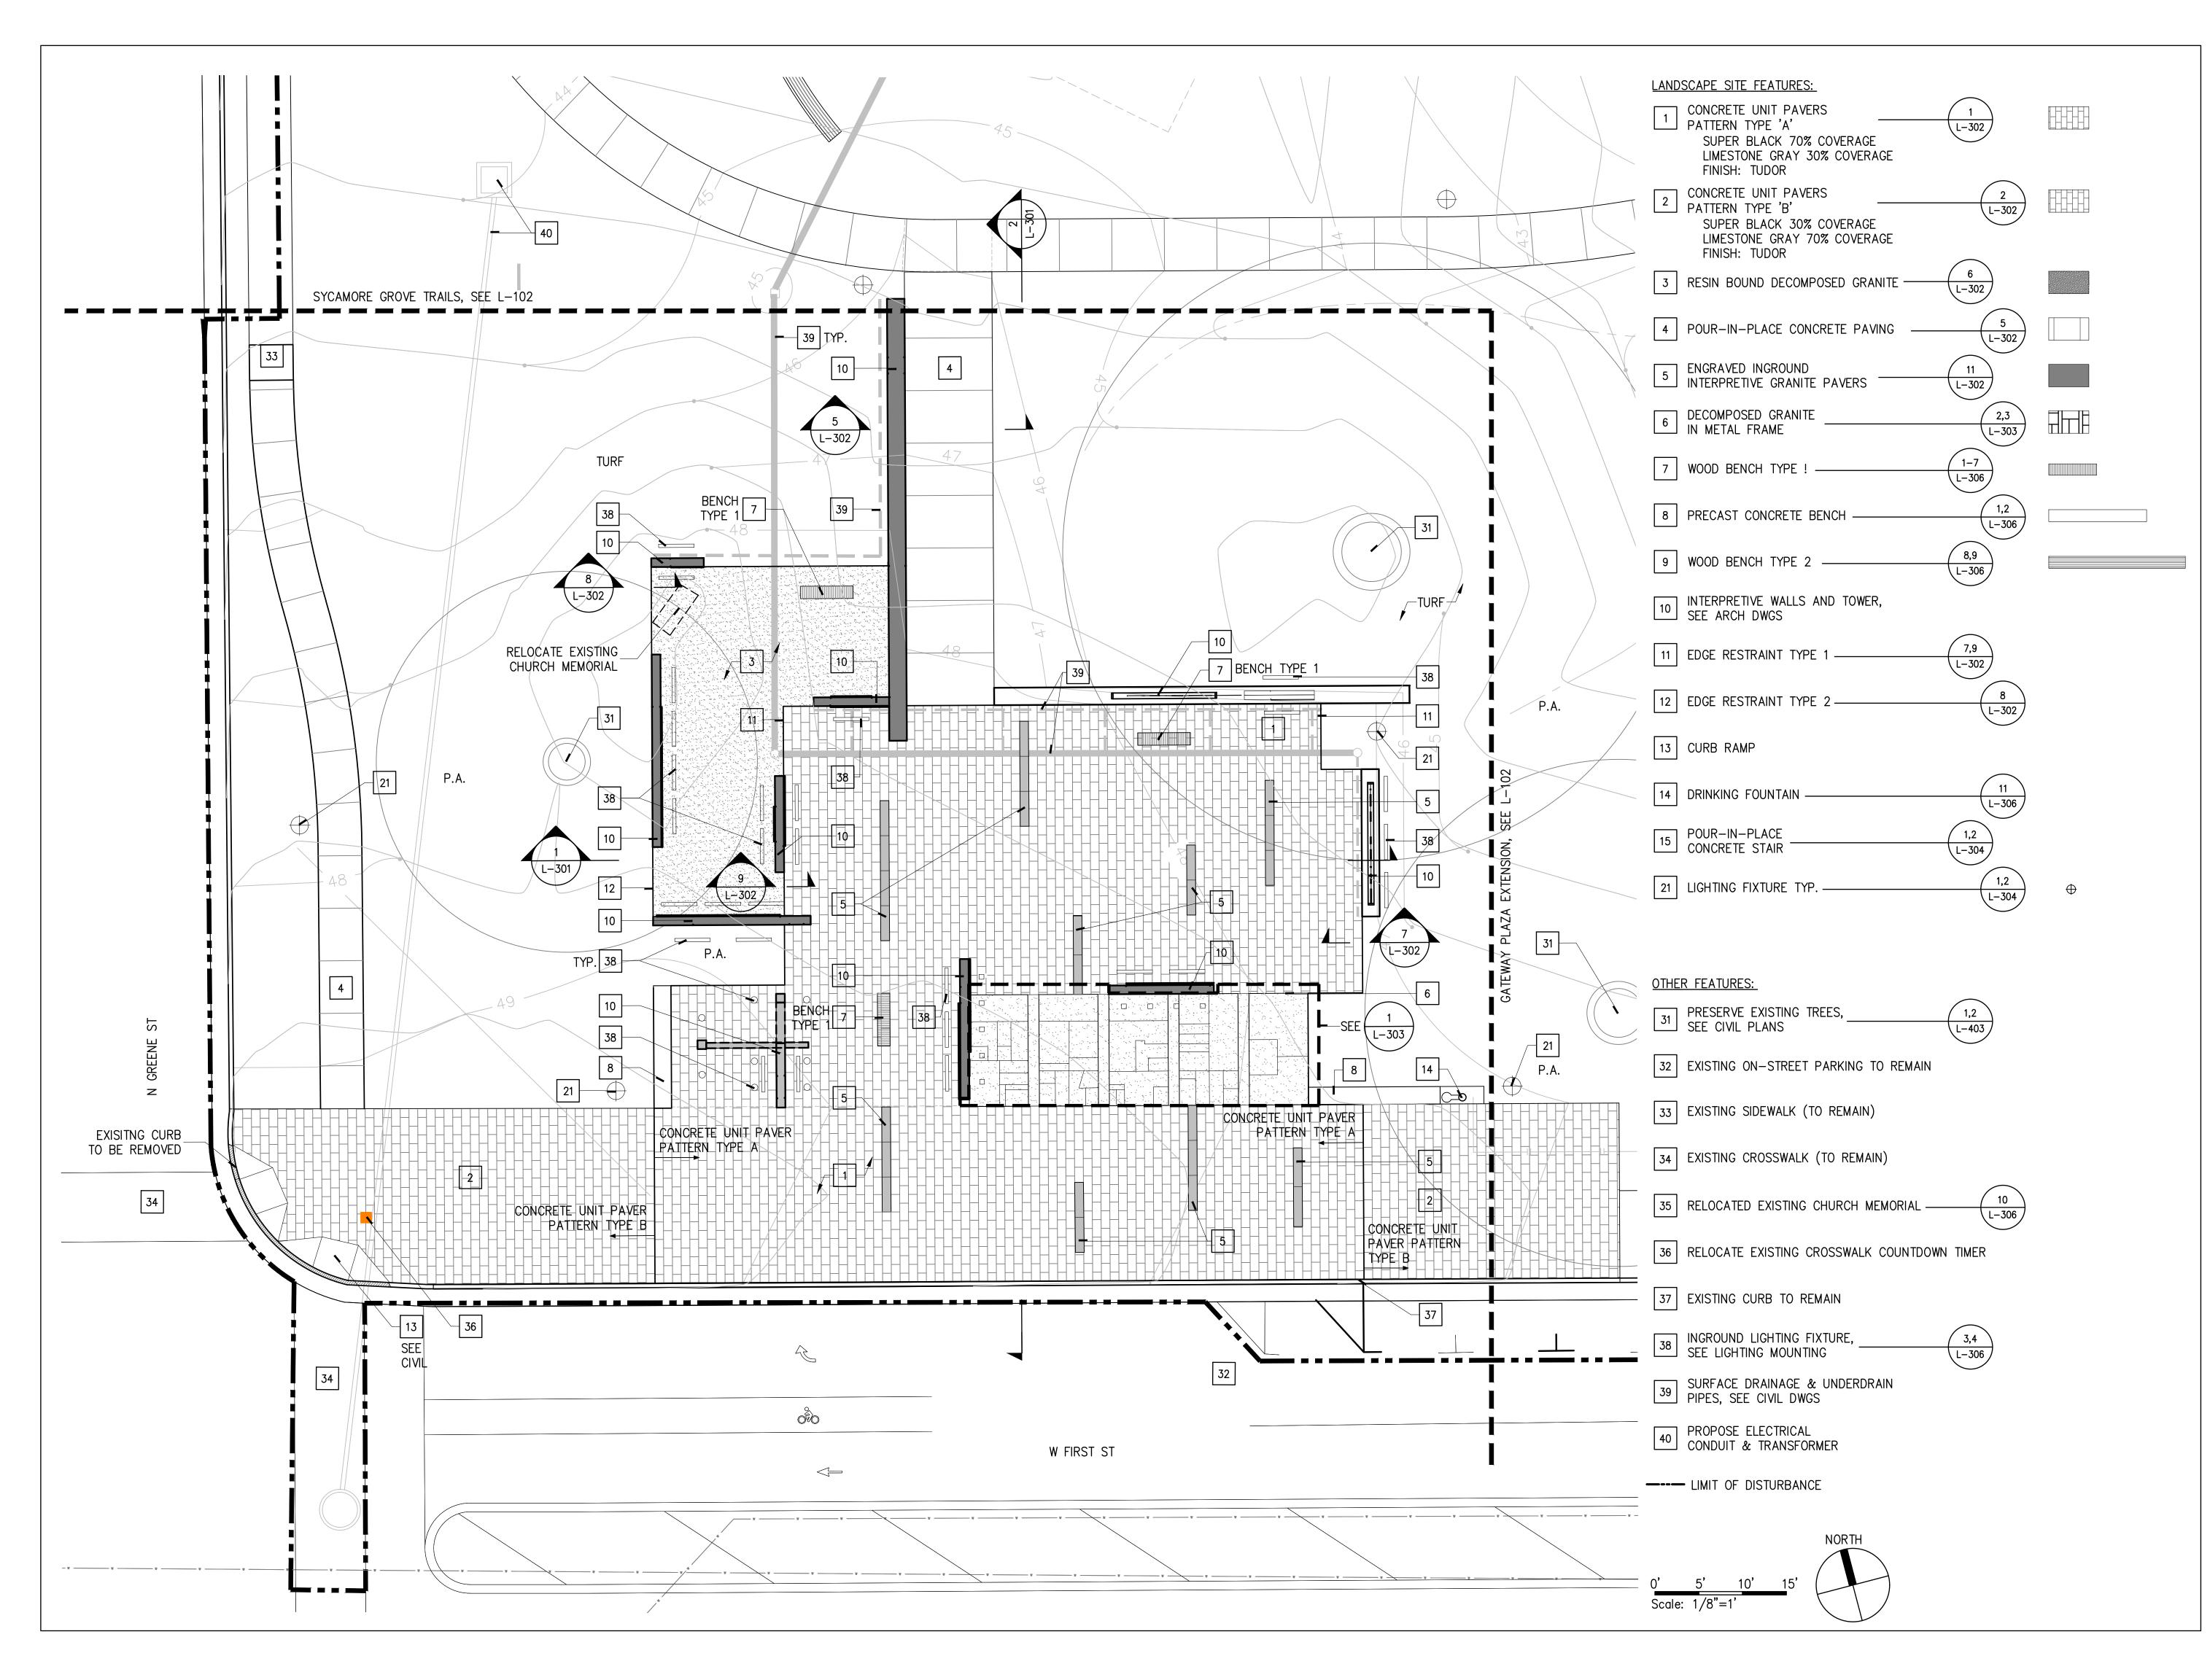

90% DESIGN SUBMISSION

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OWNER:



DESIGN TEAM:



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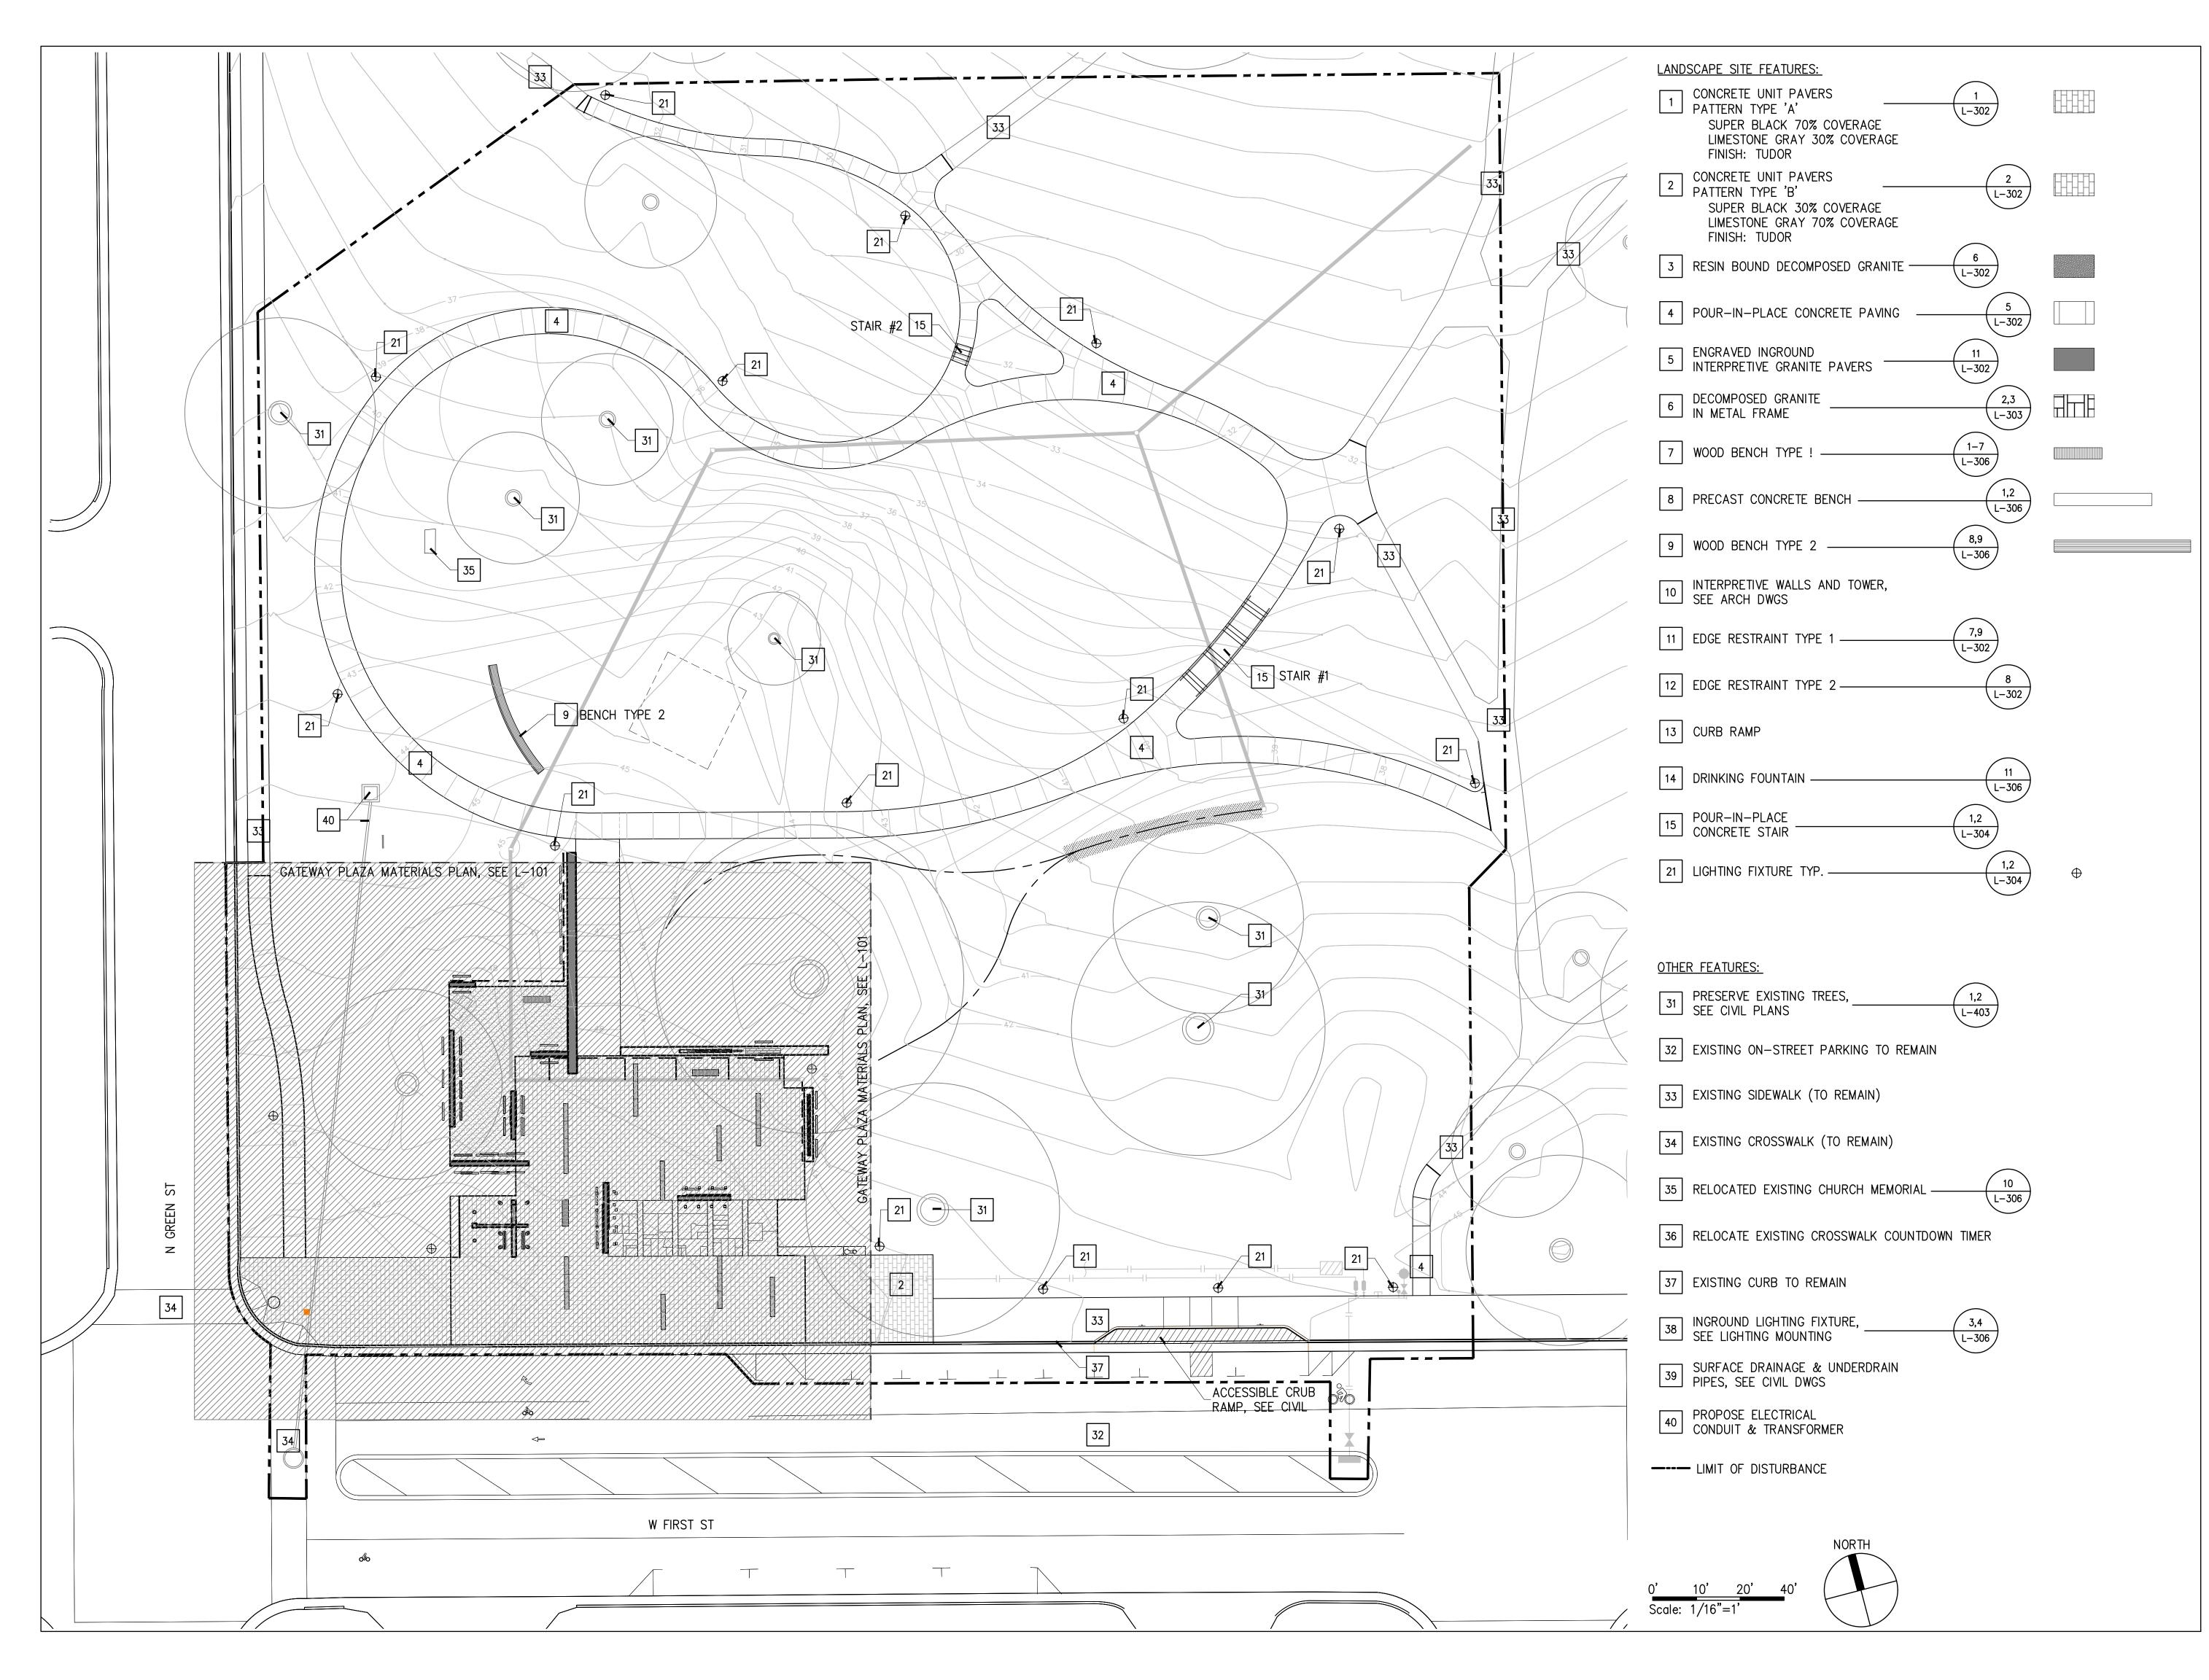
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THE EAST GROUP GALLAGHER & ASSOCIATES BREE & ASSOCIATES LIGHT DEFINES FORMS INC ENGINEERING SOURCE

### NOT FOR CONSTRUCTION OR BIDDING

**L-101** SEPTEMBER 26 2018




90% DESIGN SUBMISSION

ADDRESS: 201 W 1ST ST, GREENVILLE, NC 27858 Tel. 252.329.4567

OWNER:



DESIGN TEAM:

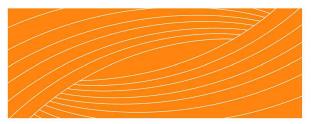

**RHODESIDE & HARWELL** 

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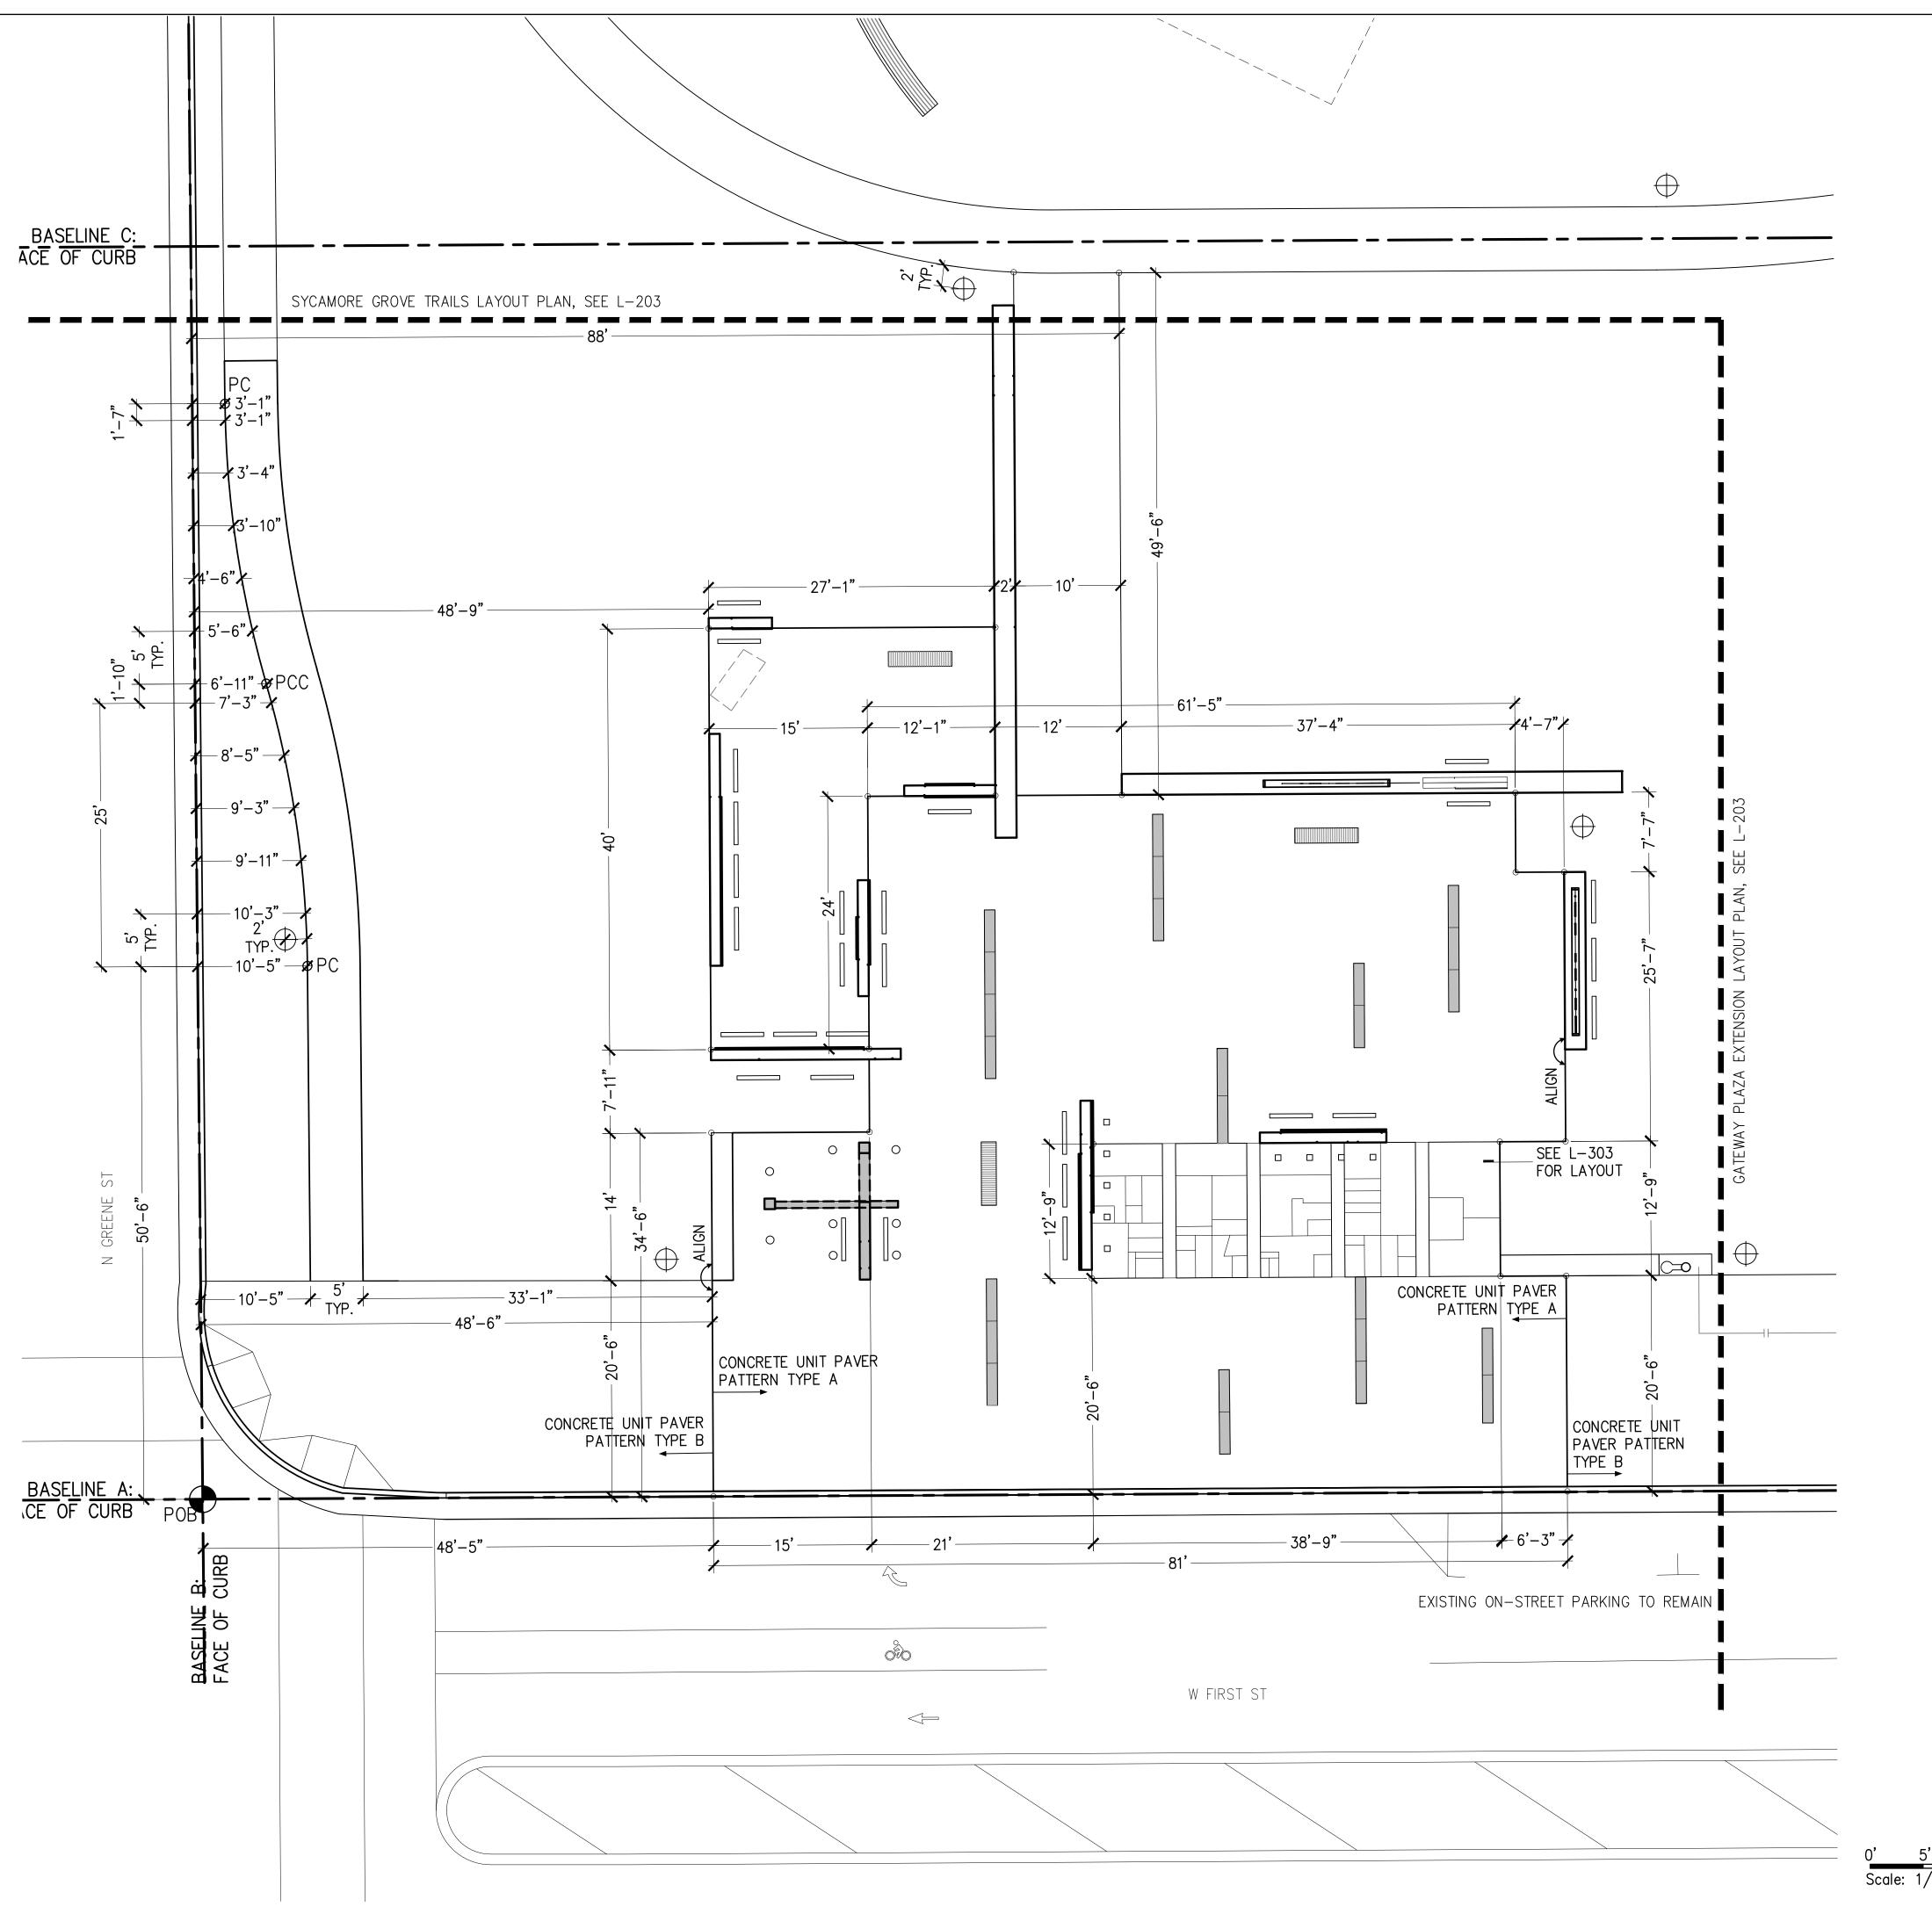
### NOT FOR CONSTRUCTION OR BIDDING

**REVISION:** 

SCALE: 1/16" = 1' - 0" SHEET NAME: SYCAMORE GROVE GATEWAY PLAZA EXTENSION MATERIALS PLAN

SHEET NUMBER:

**L-102** SEPTEMBER 26 2018



0' 5' 10' 15' Scale: 1/8"=1'

## GREENVILLE TOWN COMMON SYCAMORE HILL GATEWAY PLAZA


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OWNER:



DESIGN TEAM:



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510 King Street Suite 300 Alexandria, VA 22314 703-683-7447 ph 703-683-7449 fx www.rhodeside-harwell.com
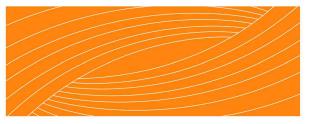
### PERKINS+WILL

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THE EAST GROUP GALLAGHER & ASSOCIATES BREE & ASSOCIATES LIGHT DEFINES FORMS INC ENGINEERING SOURCE

### NOT FOR CONSTRUCTION OR BIDDING

**REVISION:** 

1/8'' = 1' - O''

SHEET NAME:


SCALE:

GATEWAY PLAZA PAVING LAYOUT

SHEET NUMBER:

**L-201** SEPTEMBER 26 2018



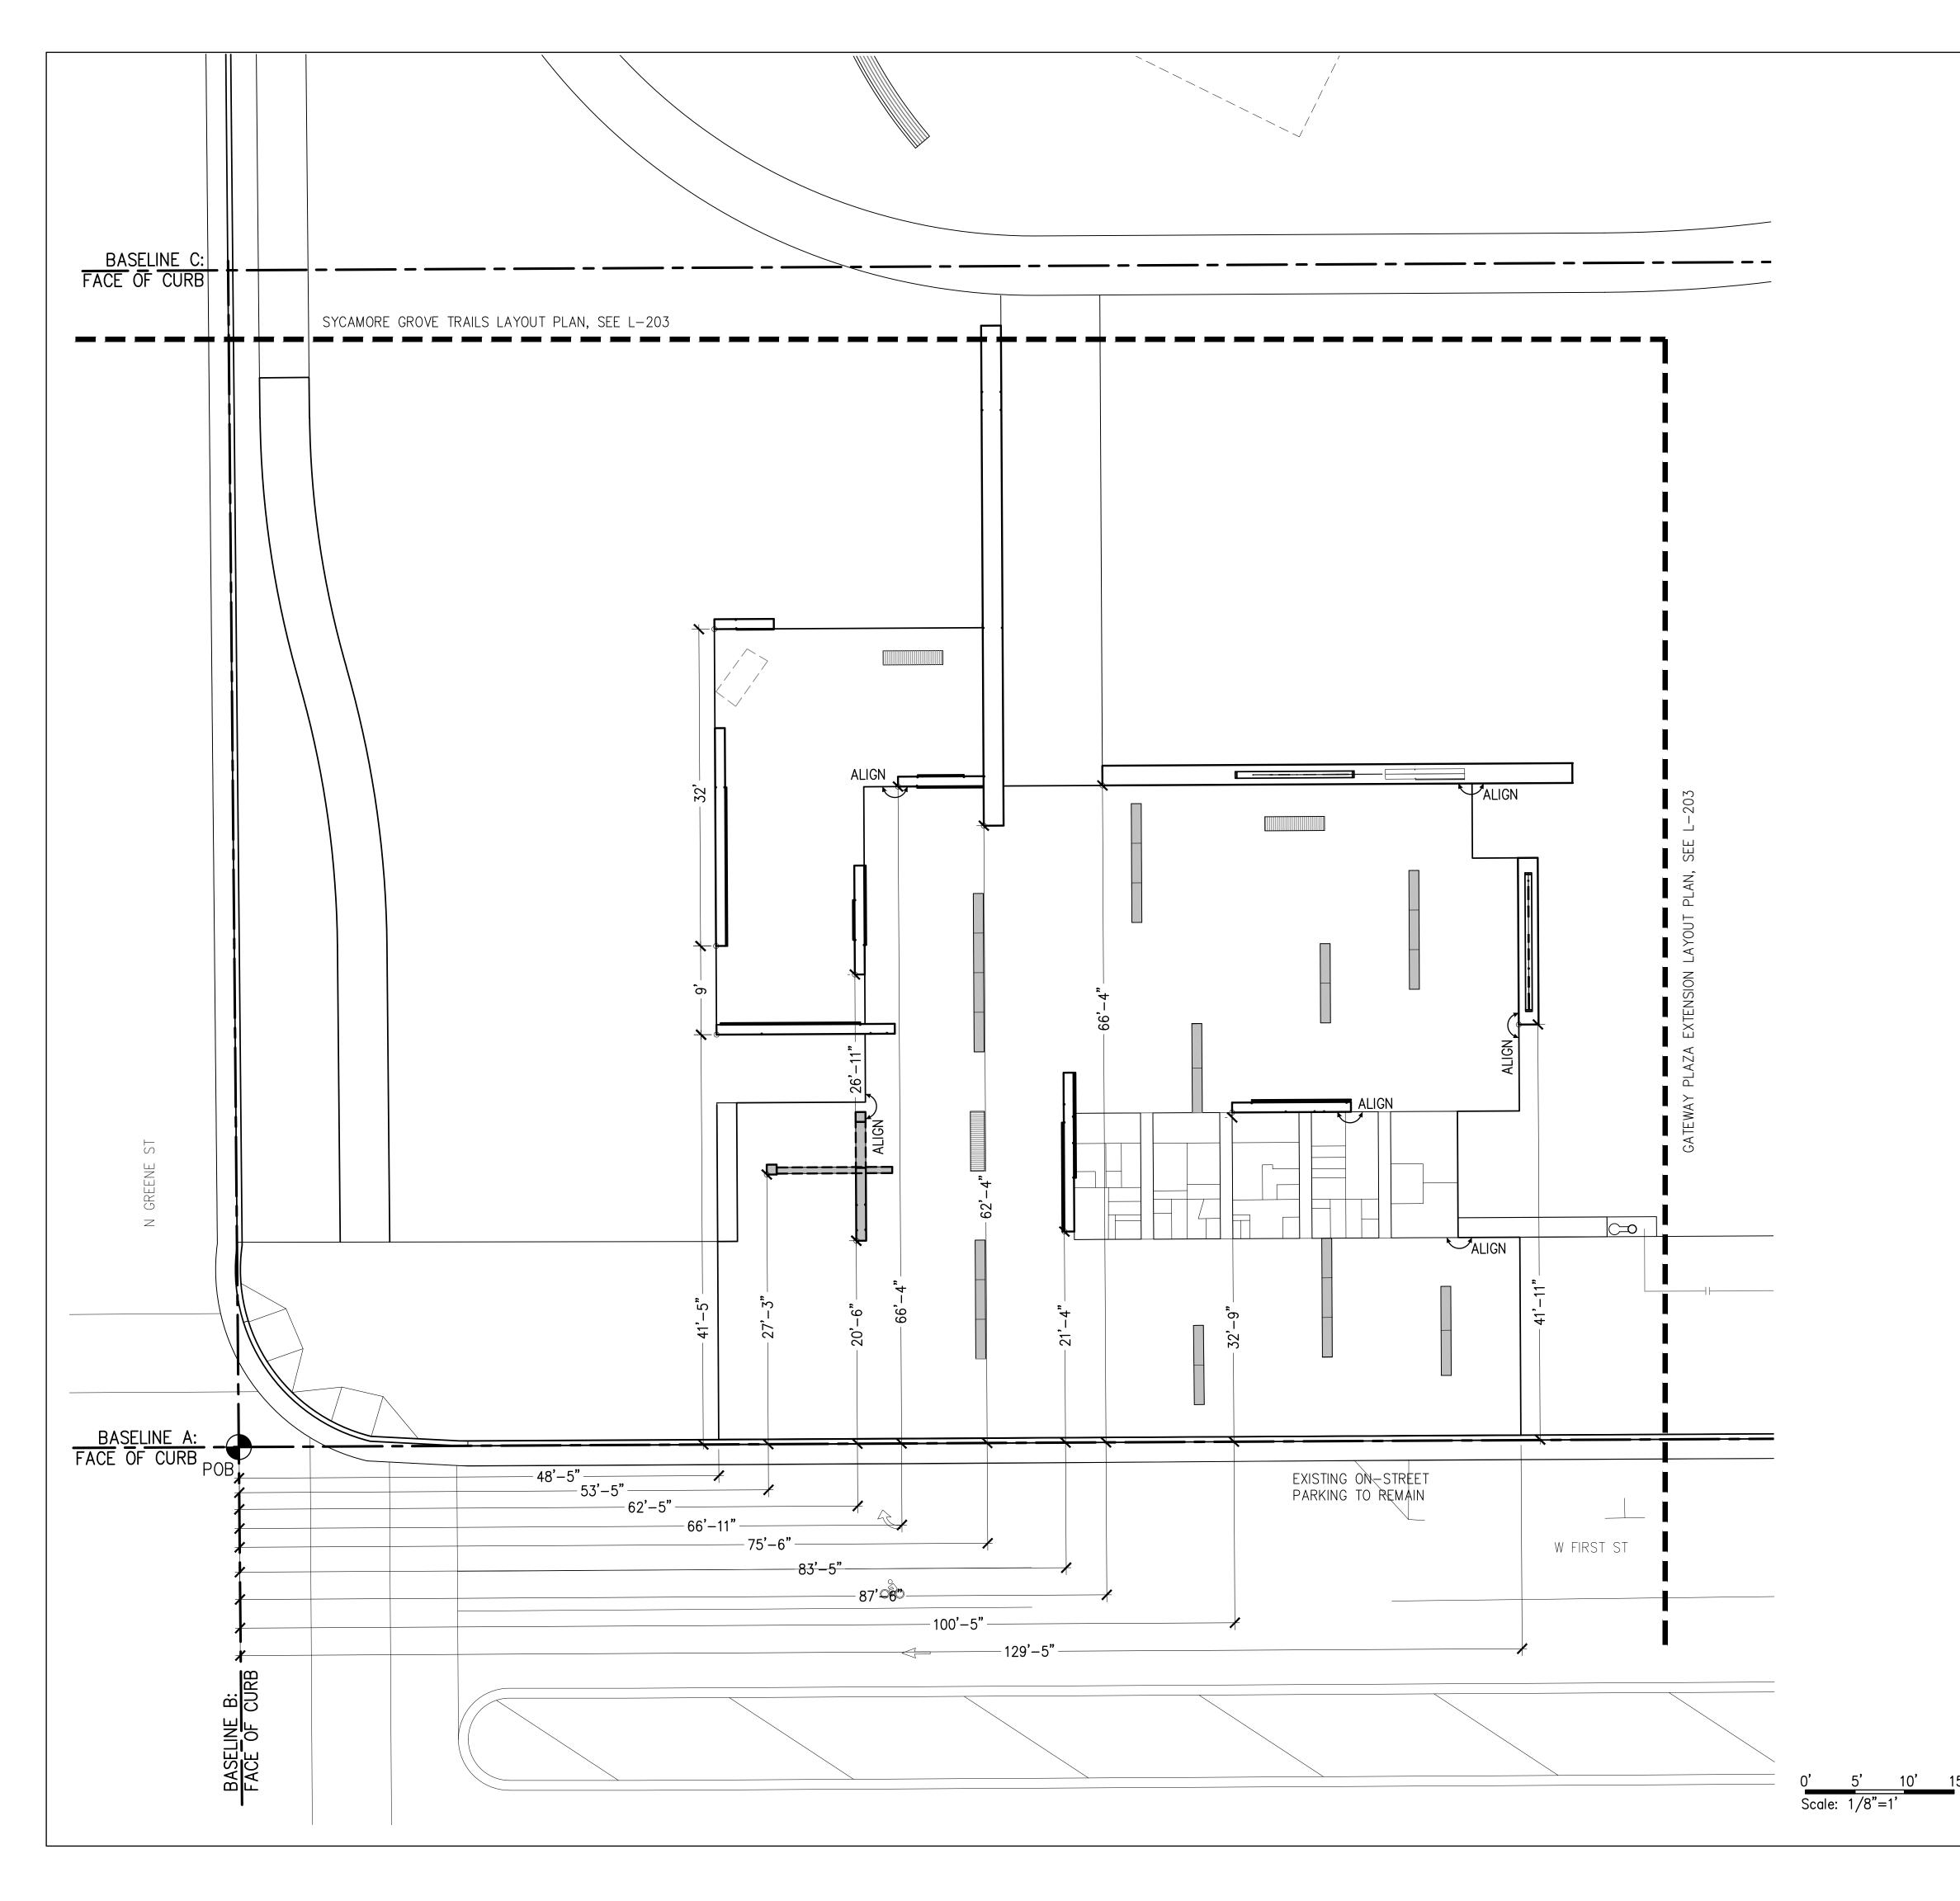


90% DESIGN SUBMISSION

ADDRESS: 201 W 1ST ST, GREENVILLE, NC 27858 Tel. 252.329.4567

OWNER:



DESIGN TEAM:

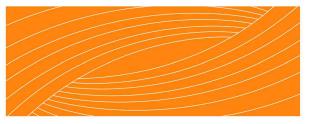

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### NOT FOR CONSTRUCTION OR BIDDING

**REVISION:** 

1/8'' = 1' - 0''

GATEWAY PLAZA WALL LAYOUT

SHEET NUMBER:


SHEET NAME:

SCALE:

DATE:

**L-202** SEPTEMBER 26 2018

NORTH

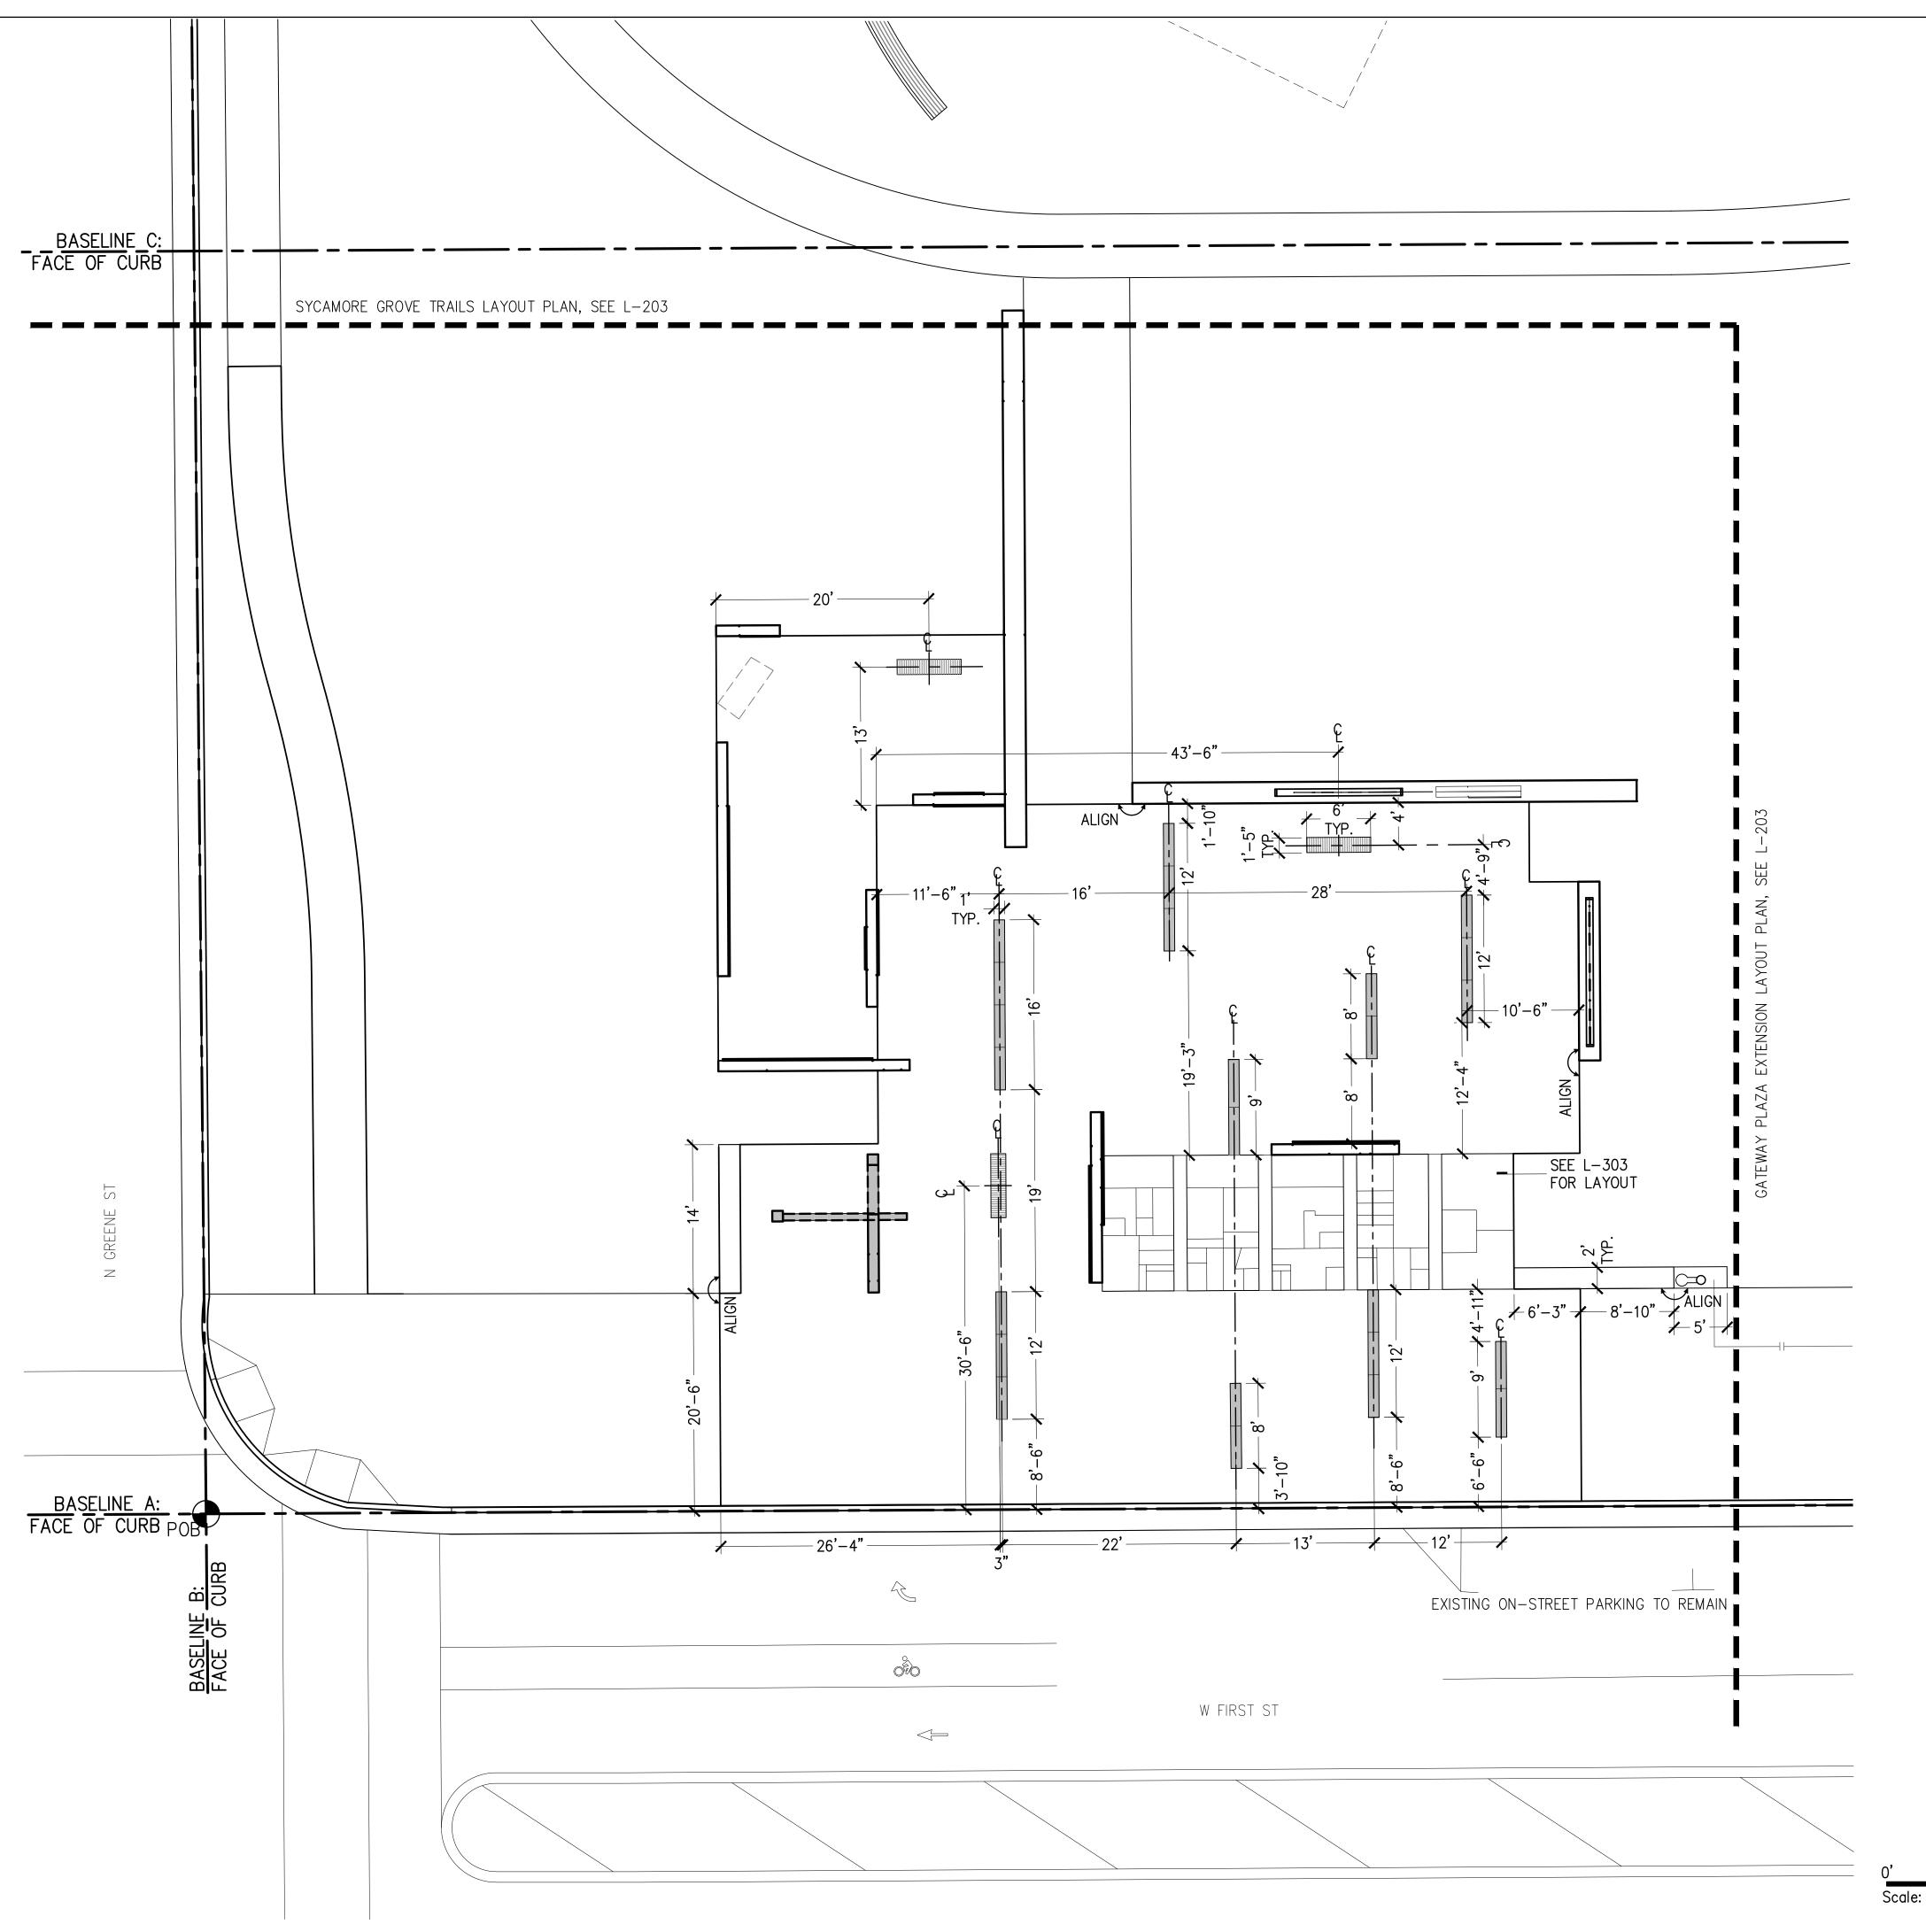

5' 10' Scale: 1/8"=1'

## GREENVILLE TOWN COMMON SYCAMORE HILL **GATEWAY PLAZA**


90% DESIGN SUBMISSION

ADDRESS: 201 W 1ST ST, GREENVILLE, NC 27858 Tel. 252.329.4567

OWNER:



DESIGN TEAM:

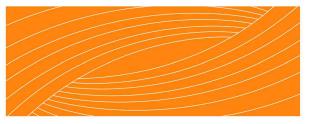

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### NOT FOR CONSTRUCTION **OR BIDDING**

**REVISION:** 

1/8'' = 1' - 0''

GATEWAY PLAZA INTERPRETIVE PAVING & BENCH LAYOUT


SHEET NUMBER:


SHEET NAME:

SCALE:

L-203

DATE:

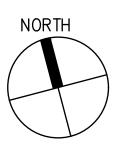

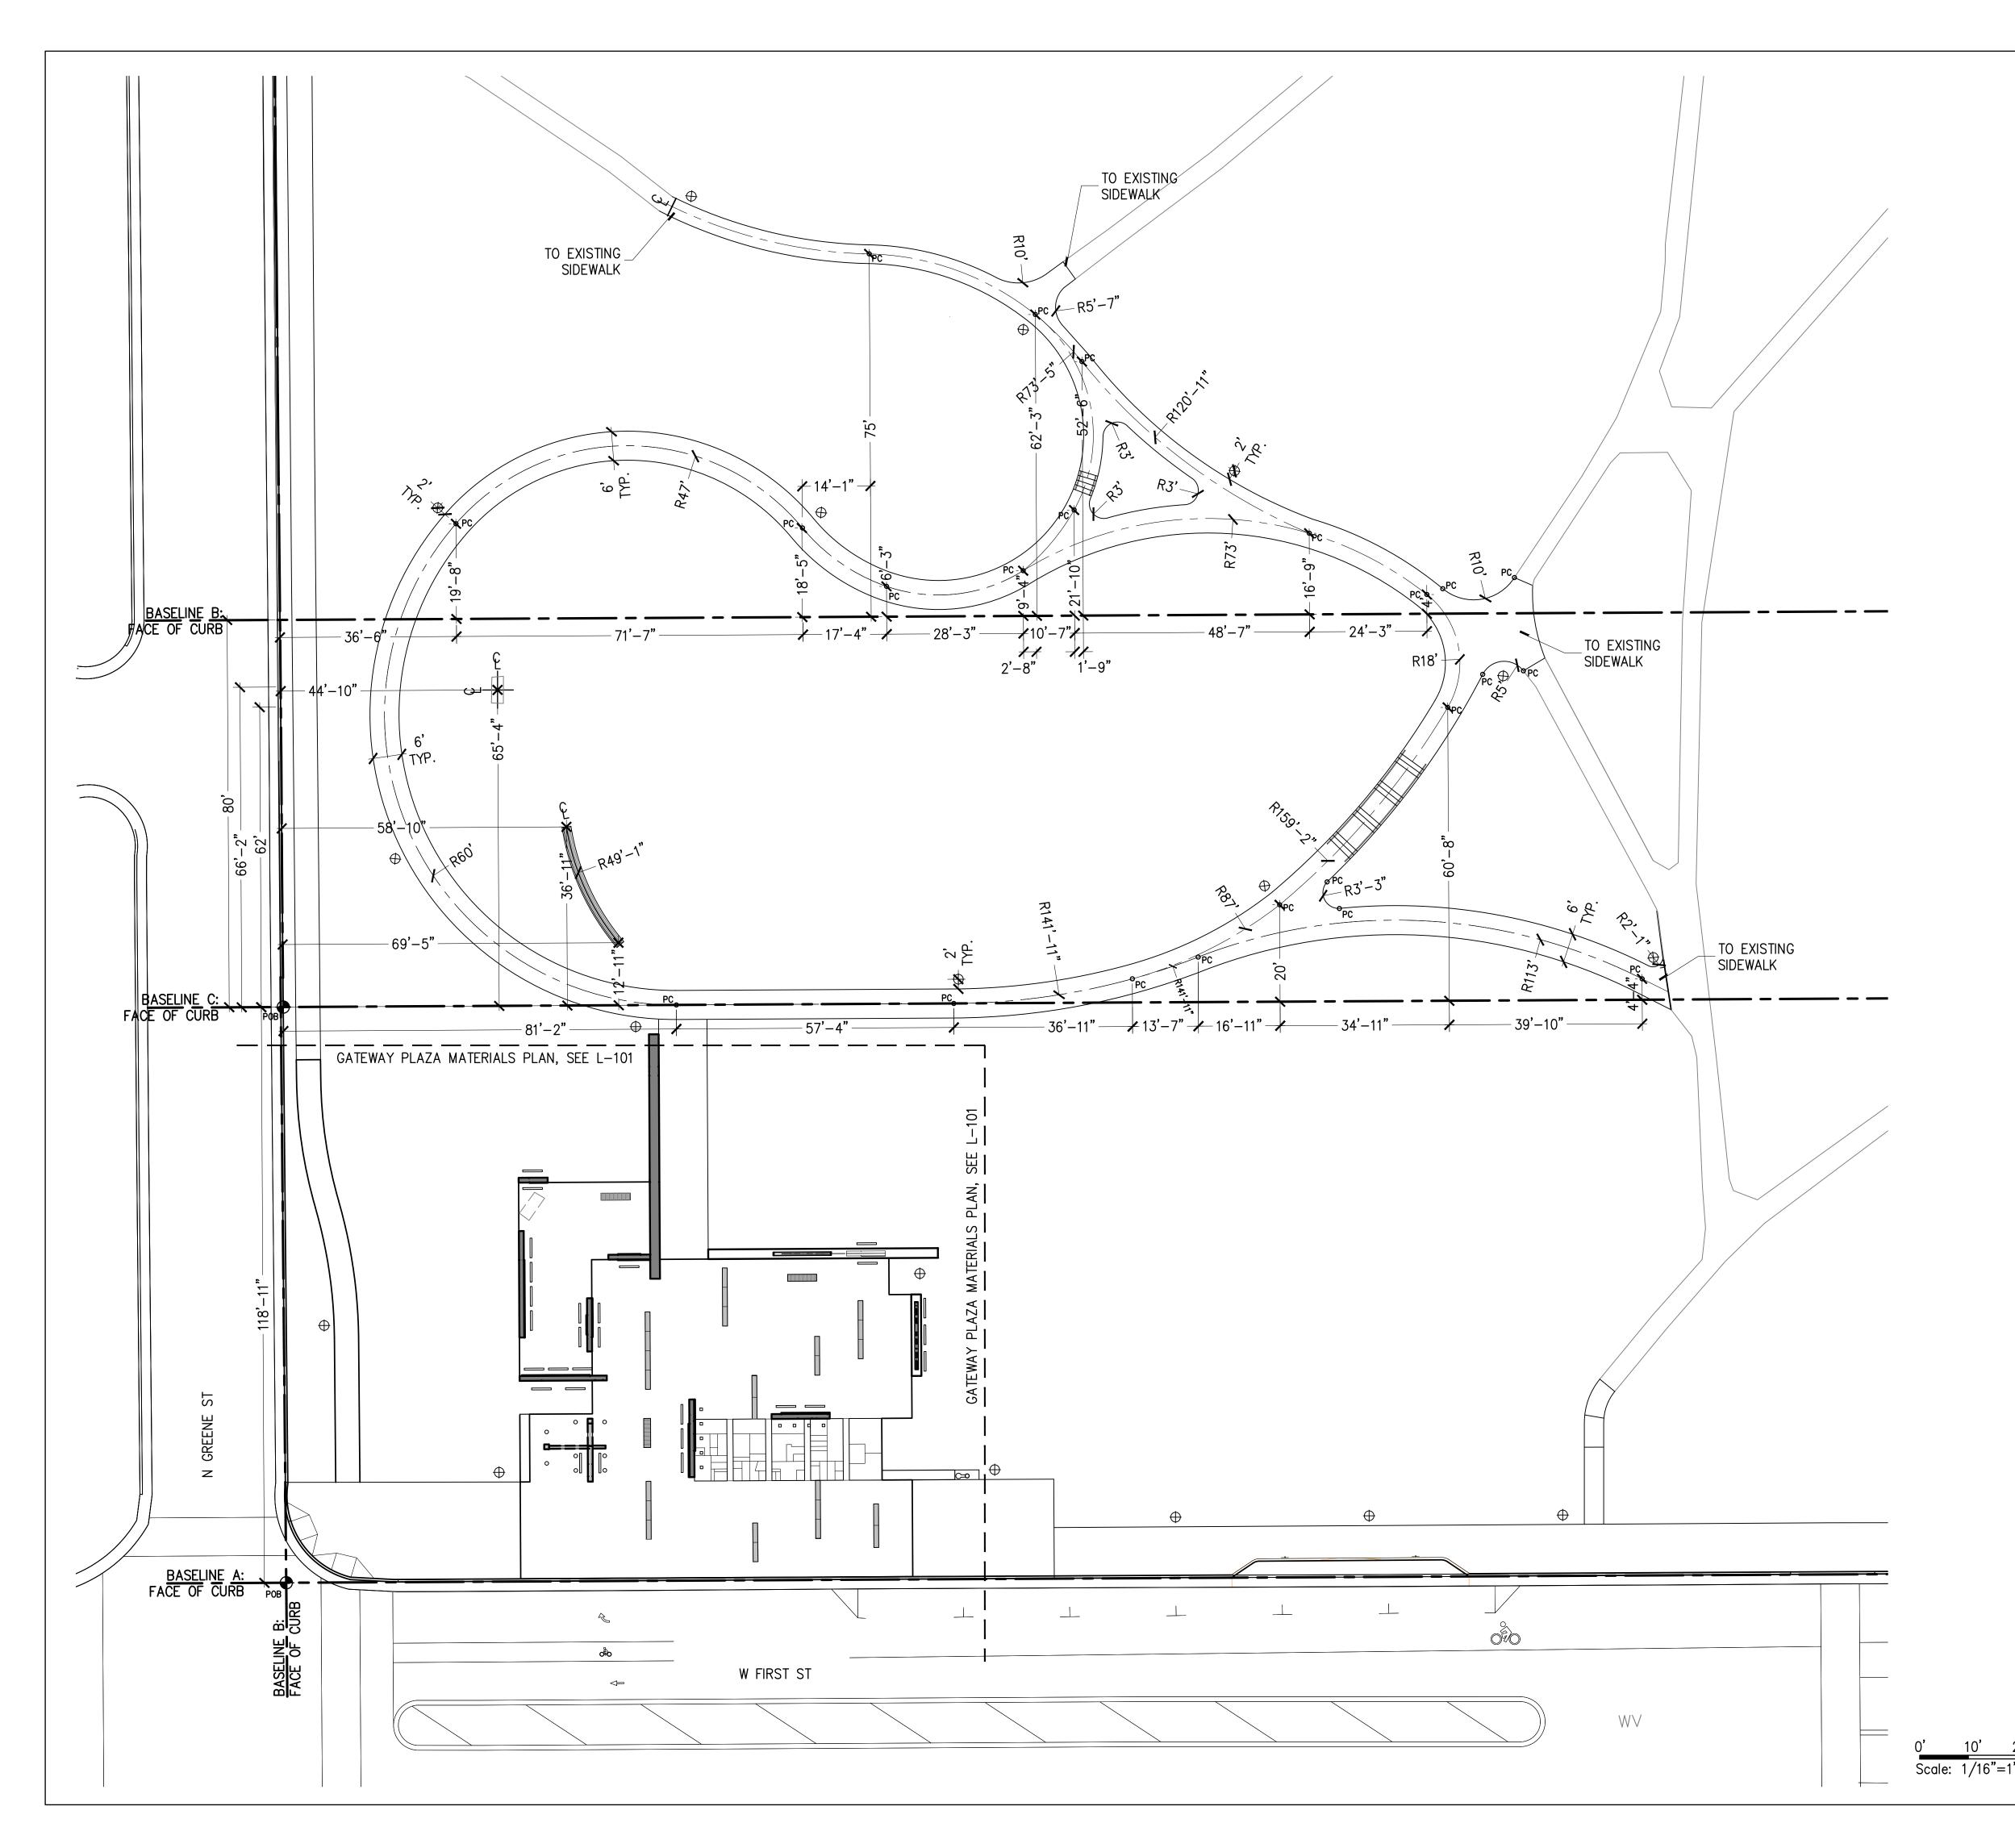


90% DESIGN SUBMISSION

ADDRESS: 201 W 1ST ST, GREENVILLE, NC 27858 Tel. 252.329.4567

OWNER:



DESIGN TEAM:

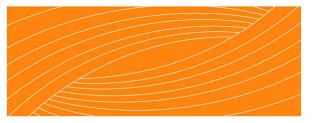

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THE EAST GROUP GALLAGHER & ASSOCIATES BREE & ASSOCIATES LIGHT DEFINES FORMS INC ENGINEERING SOURCE

### NOT FOR CONSTRUCTION **OR BIDDING**

**REVISION:** 

1/16'' = 1' - 0''

SHEET NAME: NAME: SYCAMORE GROVE & GATEWAY PLAZA EXTENSION LAYOUT PLAN


SHEET NUMBER:



DATE:


SCALE:

SEPTEMBER 26 2018

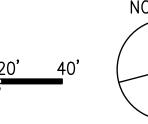

20'



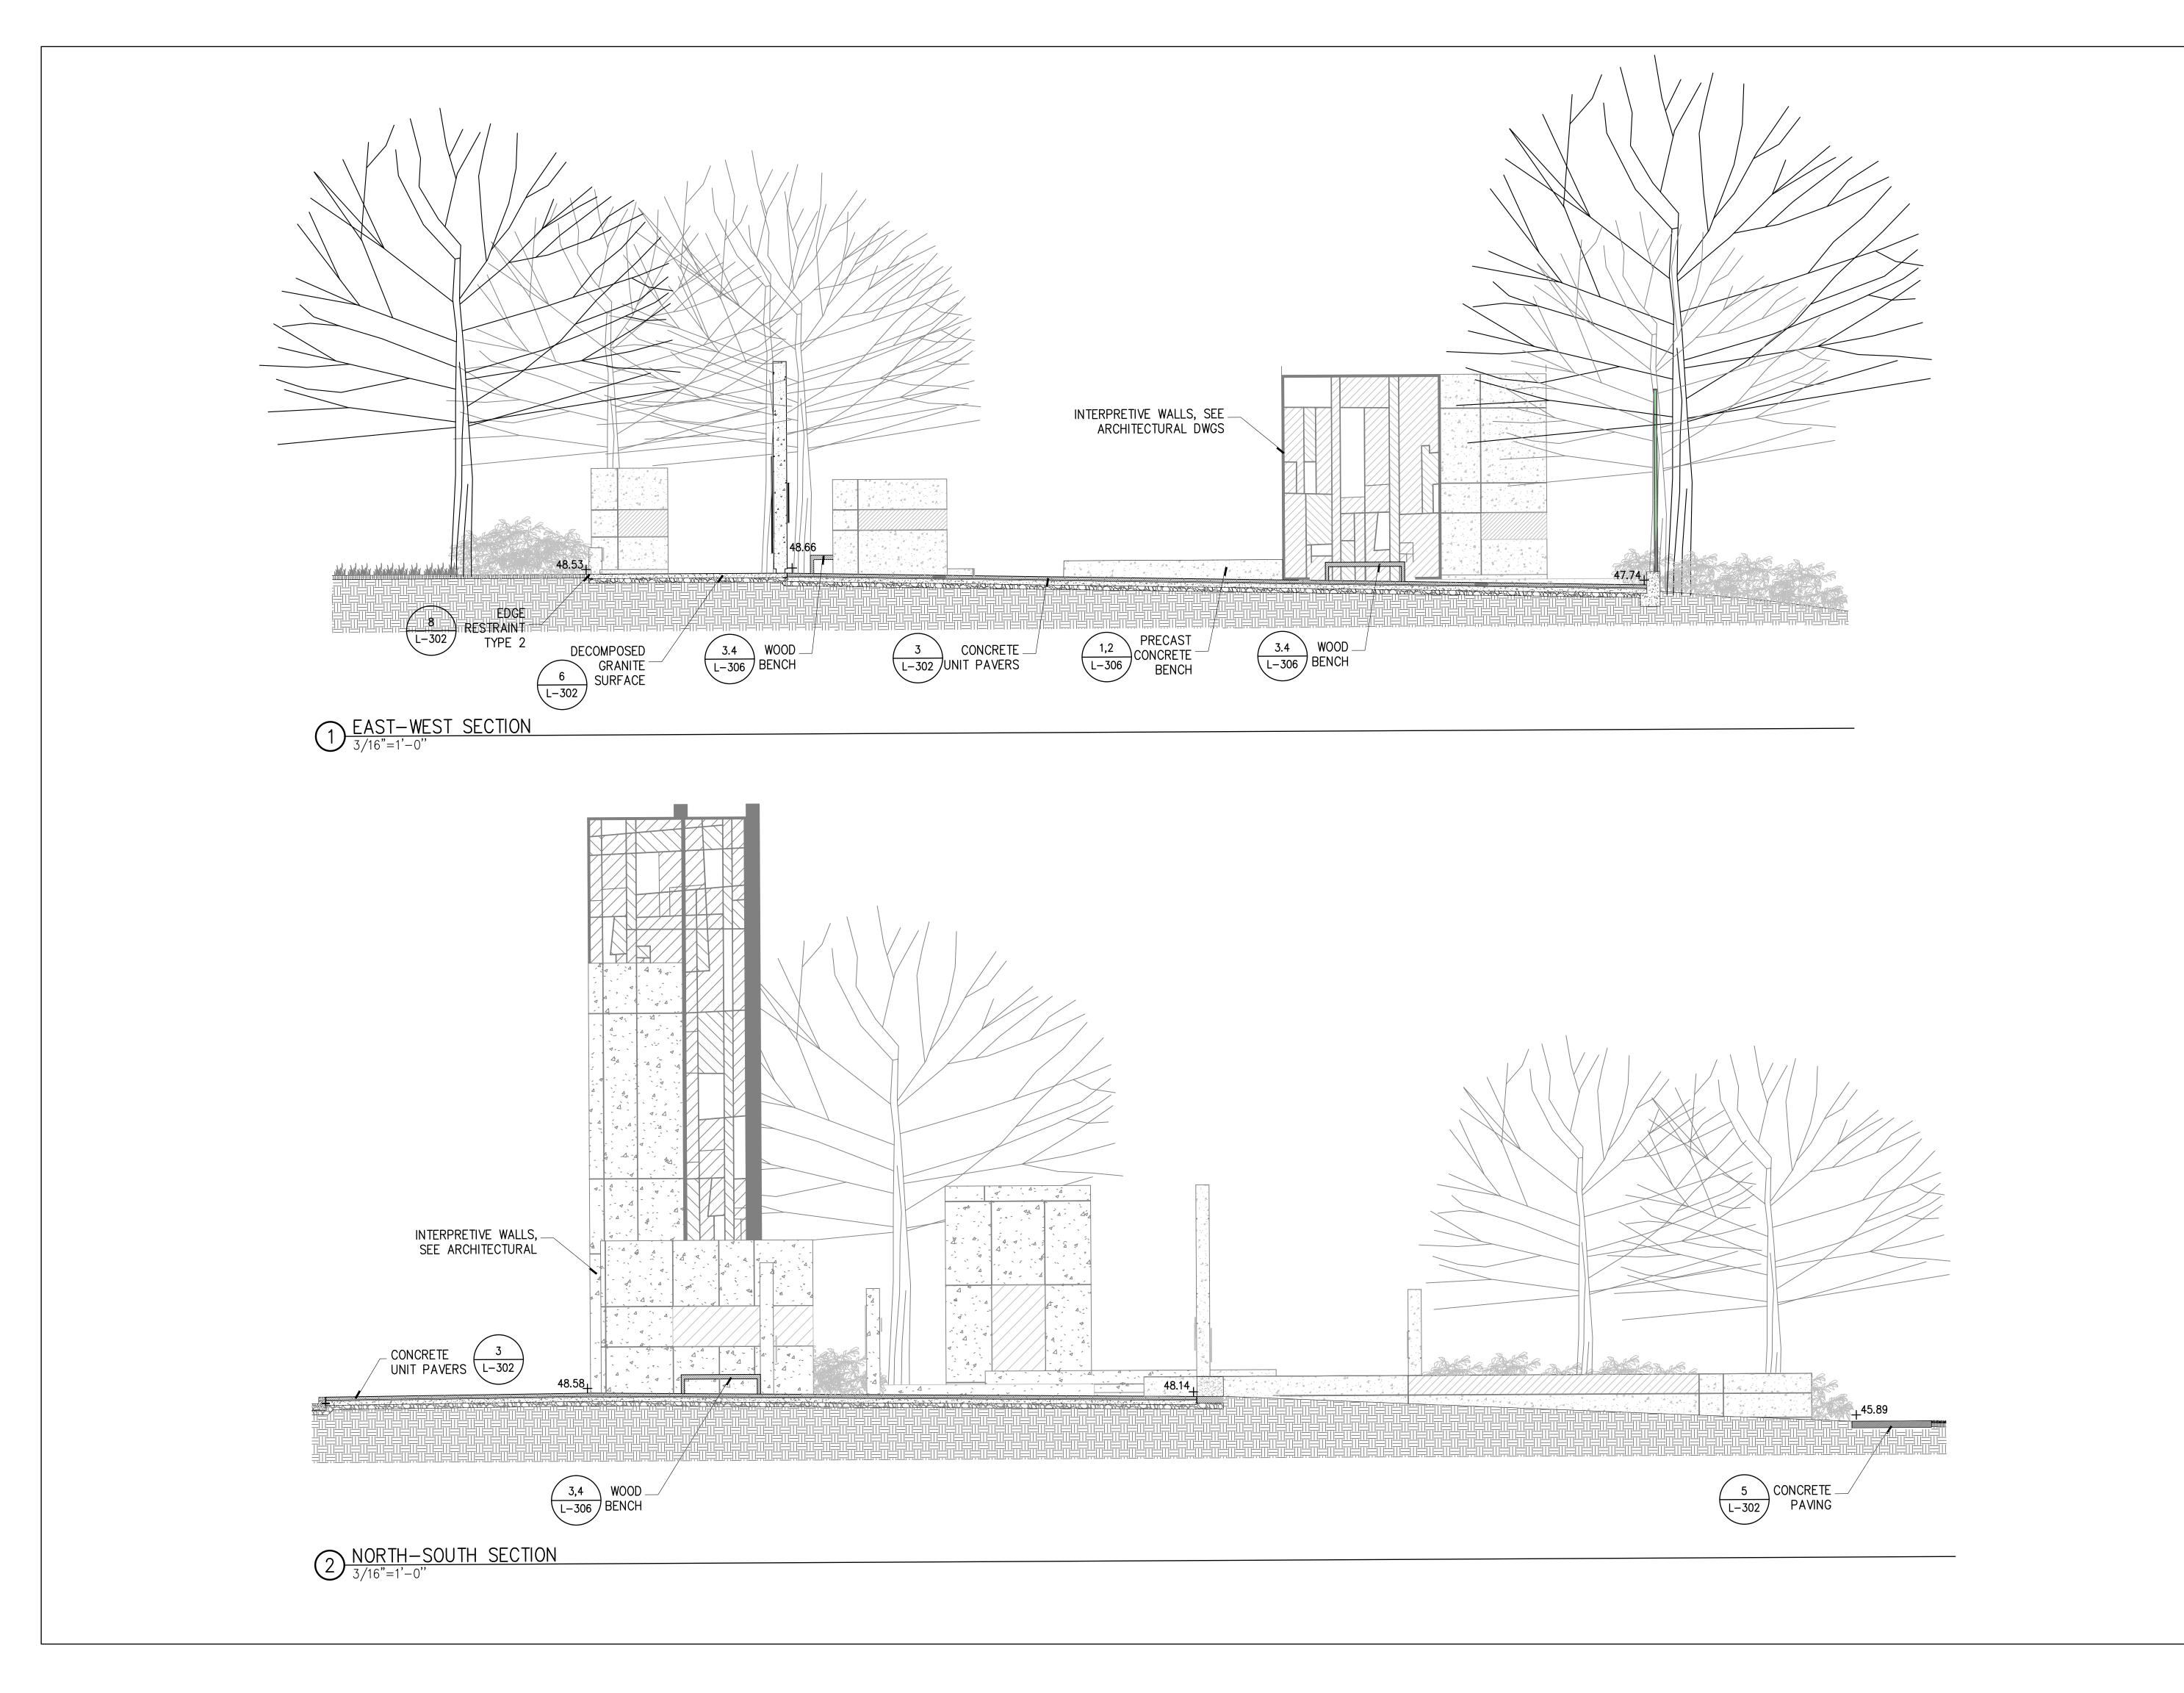


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OWNER:



DESIGN TEAM:



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### NOT FOR CONSTRUCTION OR BIDDING

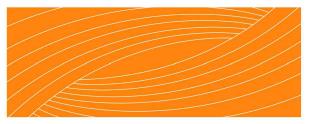**REVISION:** 

SHEET NAME:

SCALE:


SITE SECTIONS

3/16'' = 1' - 0''

SHEET NUMBER:

L-301

DATE:

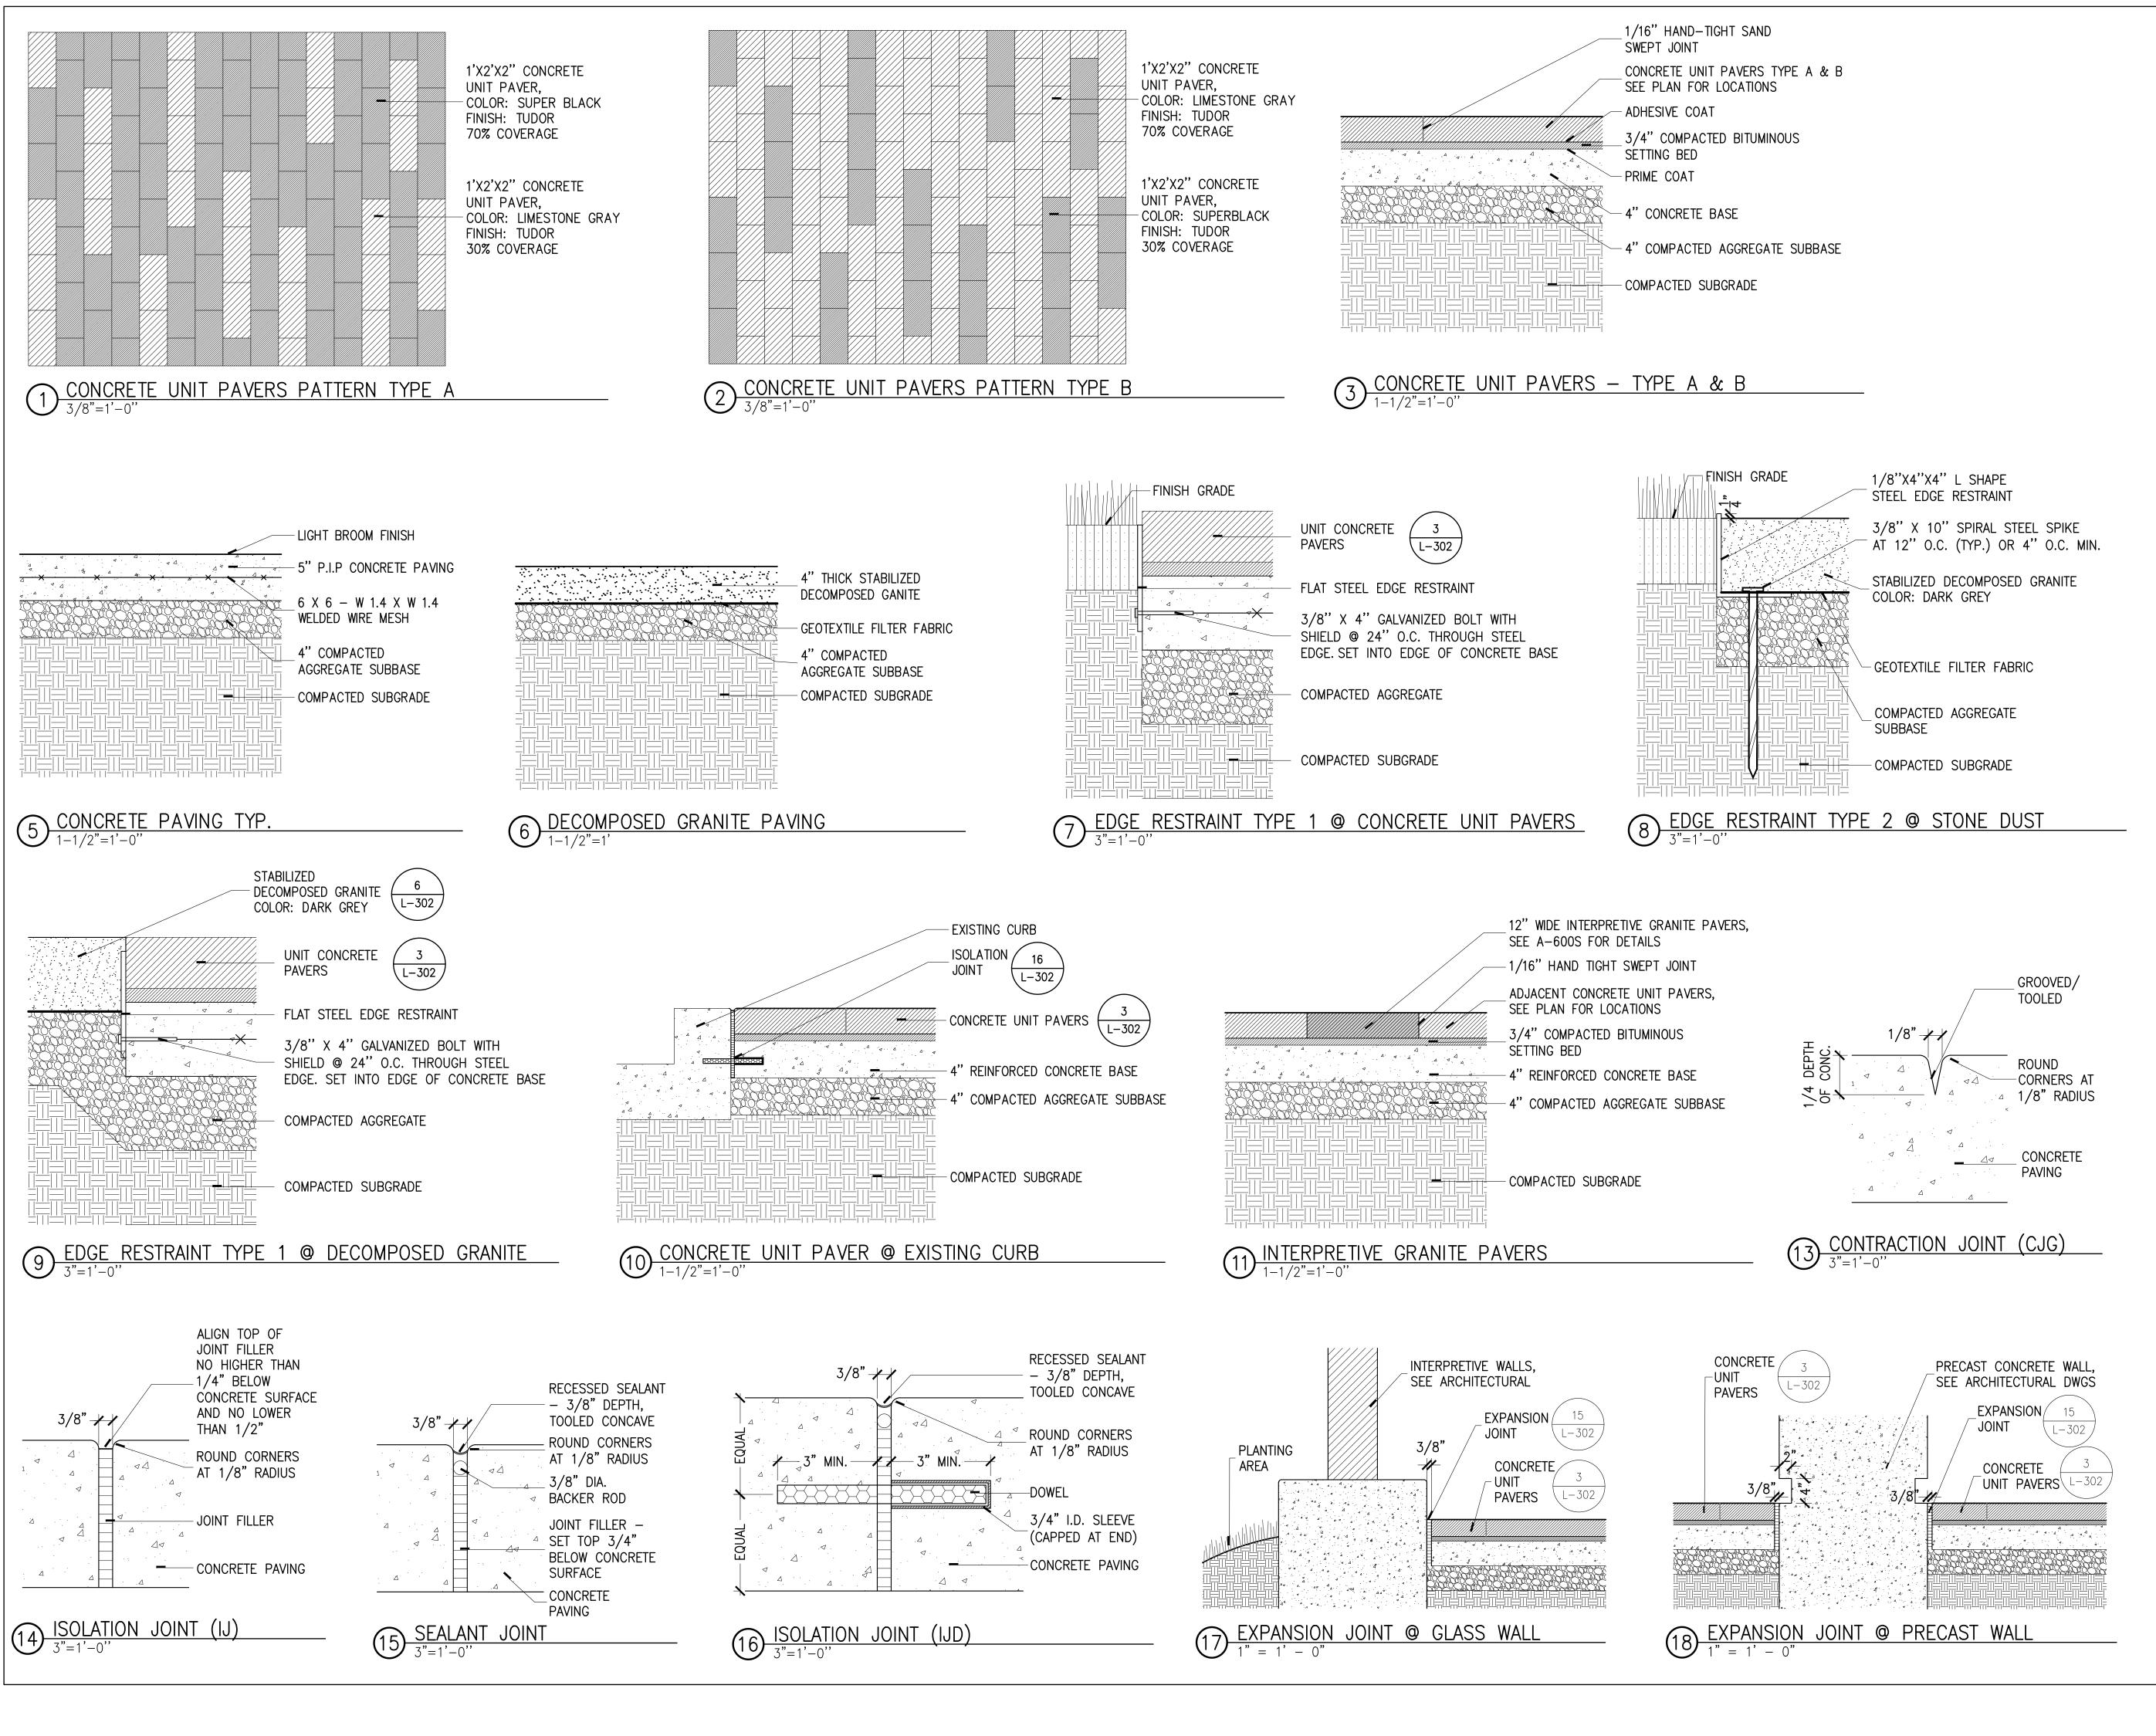


90% DESIGN SUBMISSION

ADDRESS: 201 W 1ST ST, GREENVILLE, NC 27858 Tel. 252.329.4567

**OWNER:** 



DESIGN TEAM:

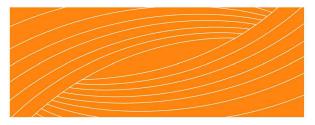

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### NOT FOR CONSTRUCTION **OR BIDDING**

**REVISION:** 

SCALE:


AS SHOWN

SHEET NAME:

**PAVING DETAILS** 

SHEET NUMBER:

**L-302** SEPTEMBER 26 2018

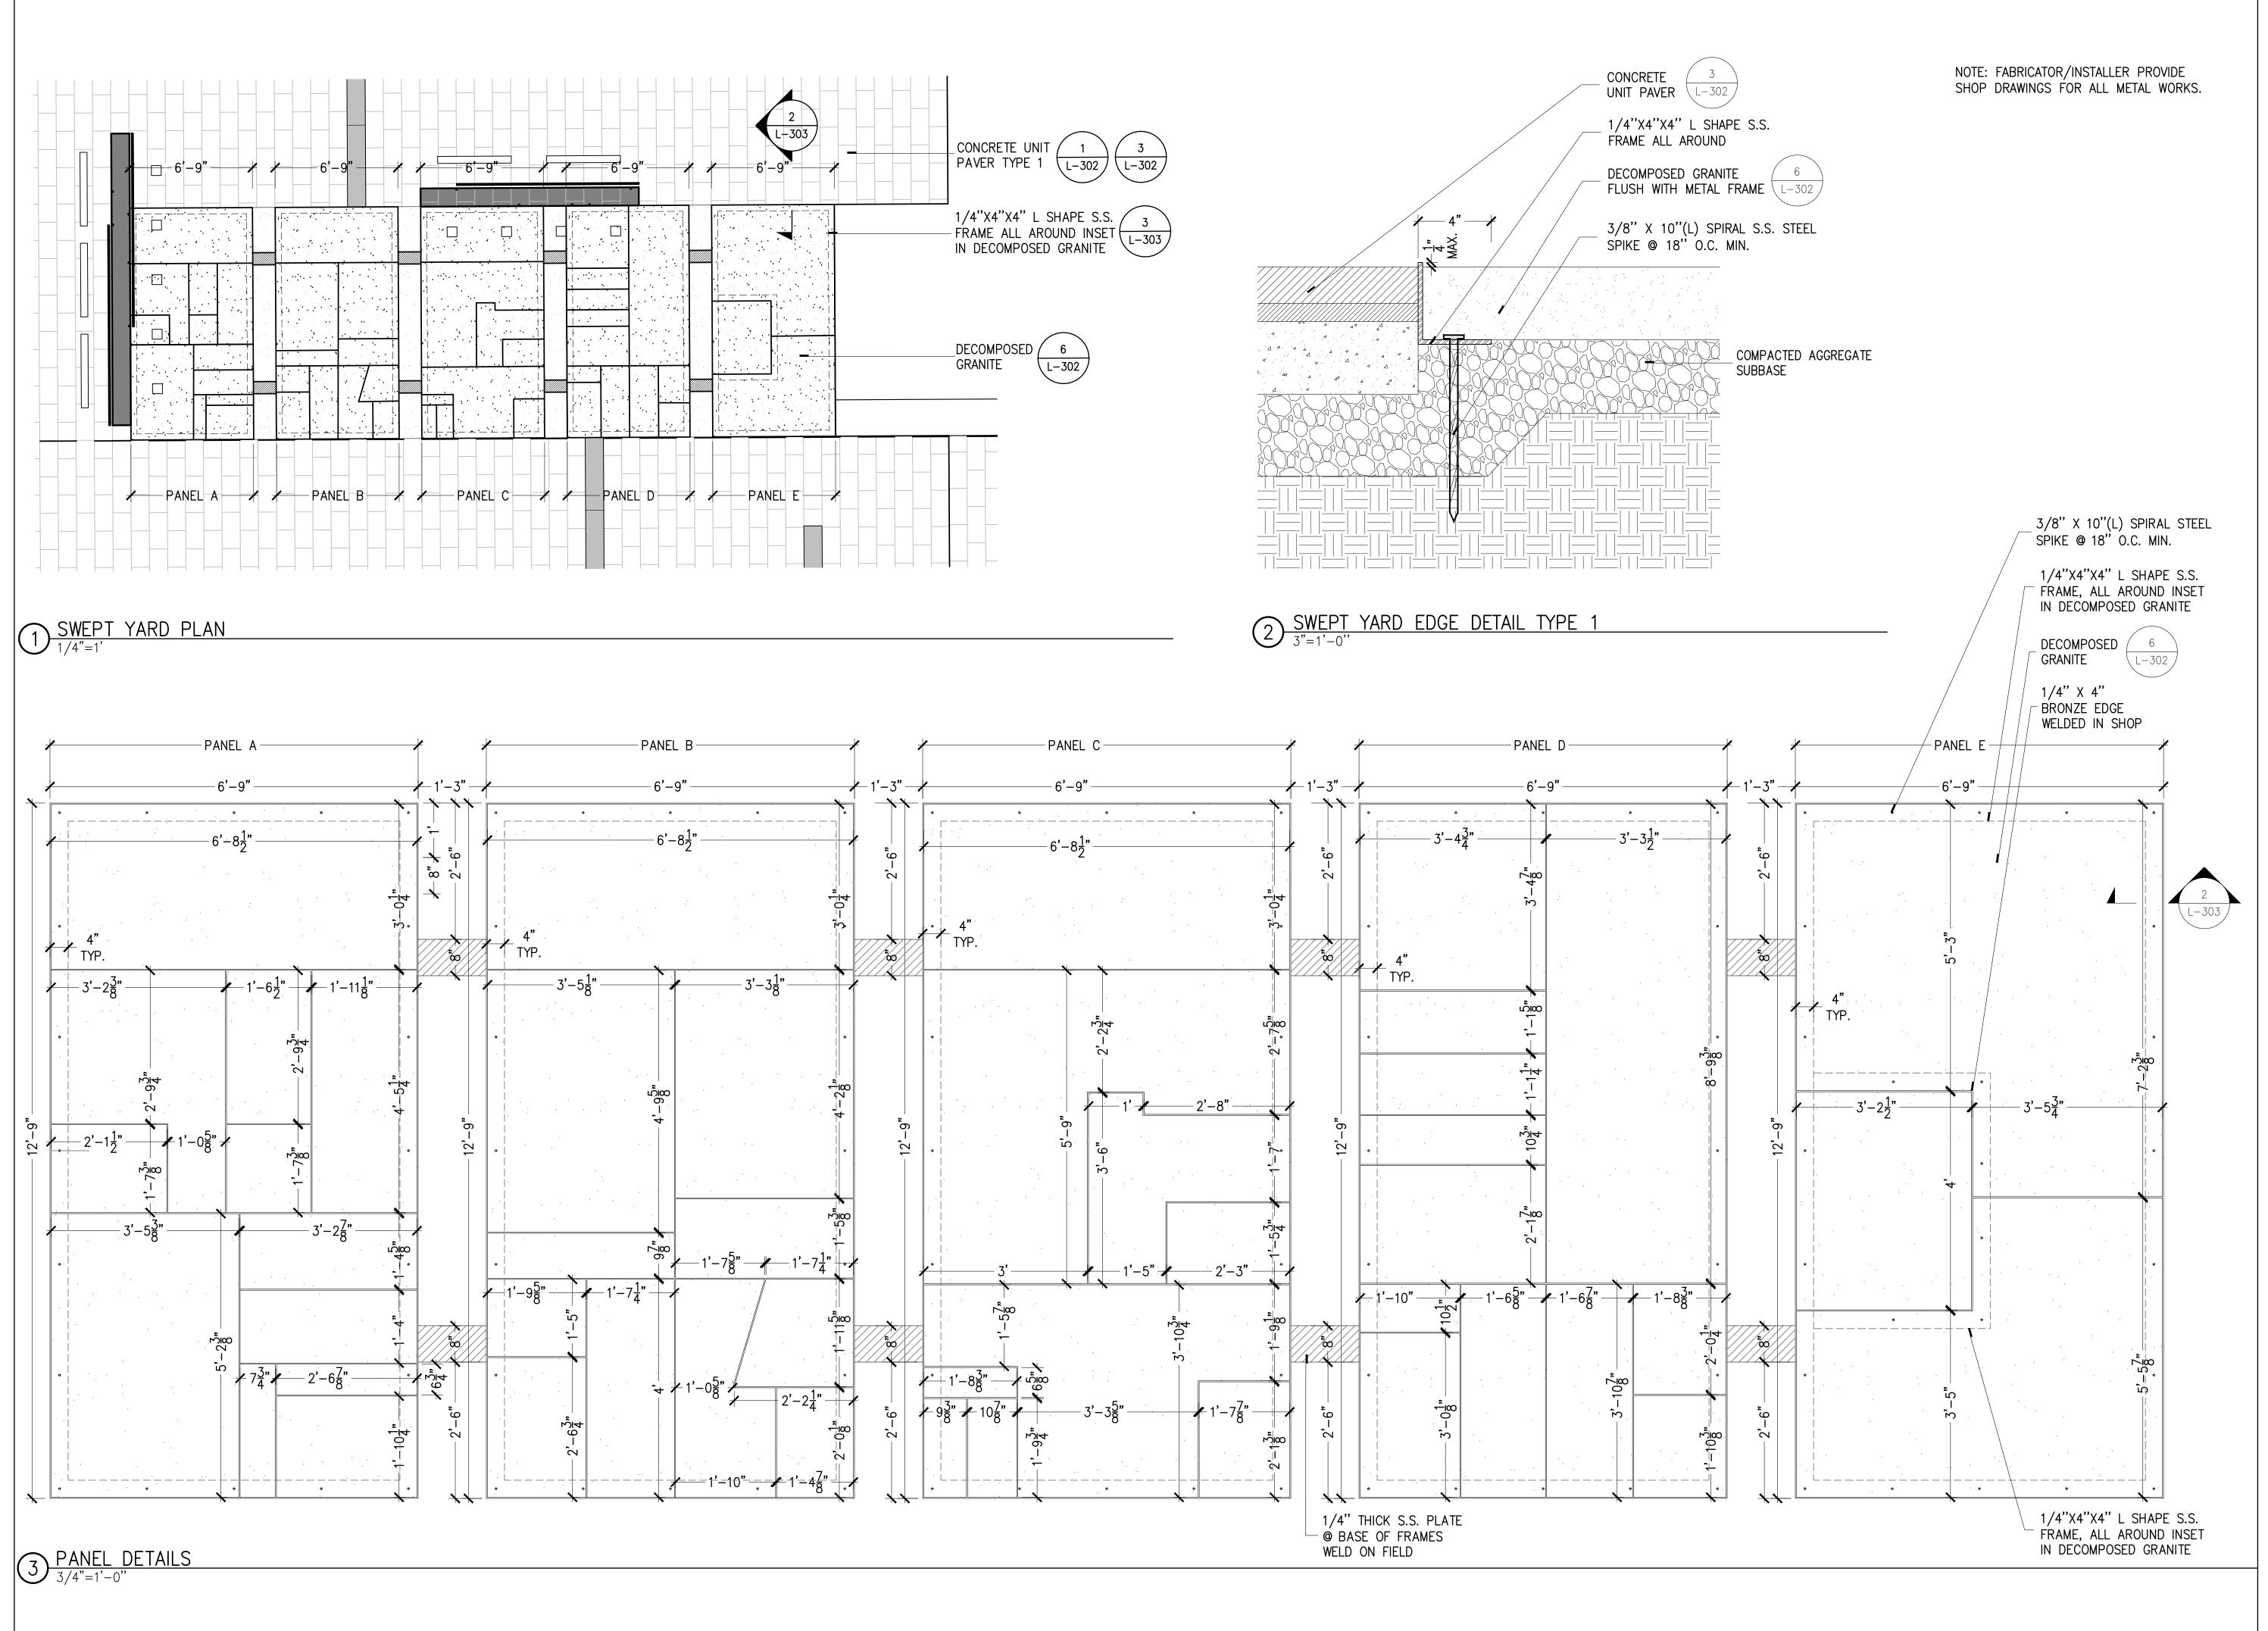

90% DESIGN SUBMISSION


ADDRESS:

201 W 1ST ST, GREENVILLE, NC 27858 Tel. 252.329.4567

OWNER:



DESIGN TEAM:

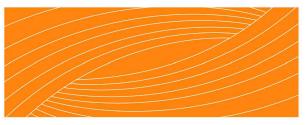

**RHODESIDE & HARWELL** 

510 King Street Suite 300 Alexandria, VA 22314 703-683-7447 ph 703-683-7449 fx www.rhodeside-harwell.com

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THE EAST GROUP GALLAGHER & ASSOCIATES BREE & ASSOCIATES LIGHT DEFINES FORMS INC ENGINEERING SOURCE

### NOT FOR CONSTRUCTION OR BIDDING

REVISION:

SCALE:


N.T.S


SHEET NAME:

PAVING DETAILS


SHEET NUMBER:

**L-303** SEPTEMBER 26 2018

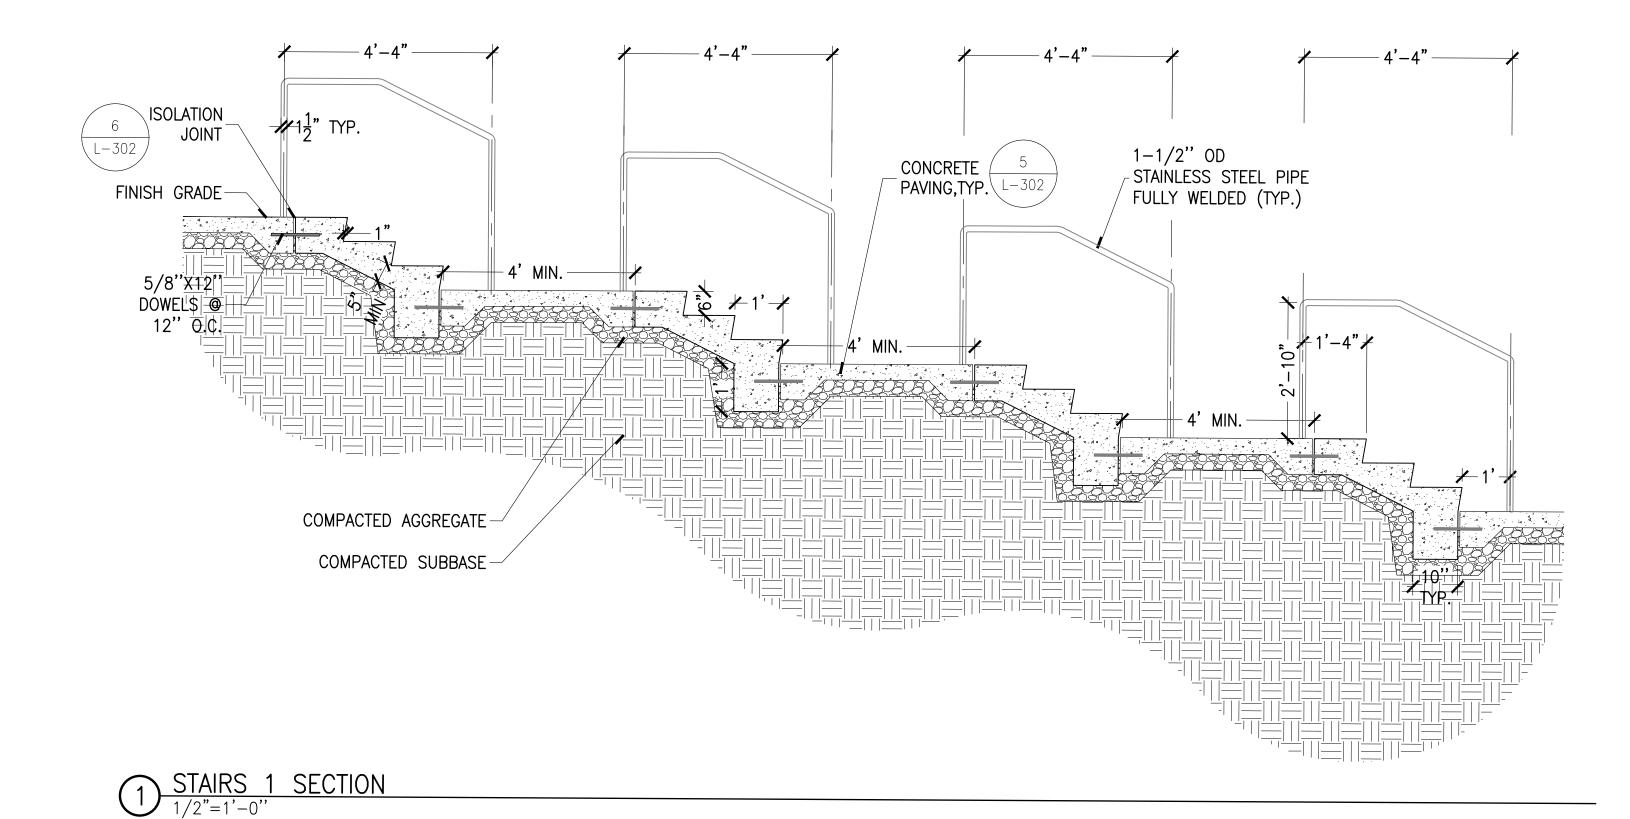

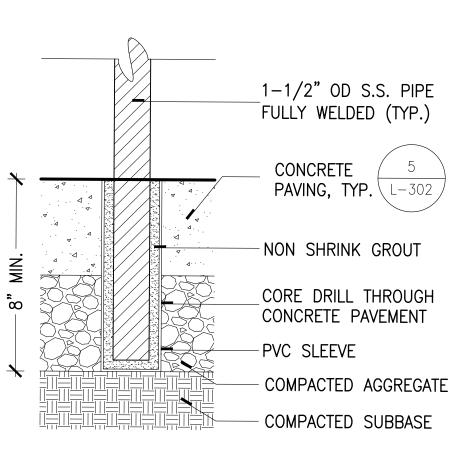

 $\underbrace{3}_{3"=1'-0"} \underbrace{\text{SLEEVE DETAIL}}_{3"=1'-0"}$ 

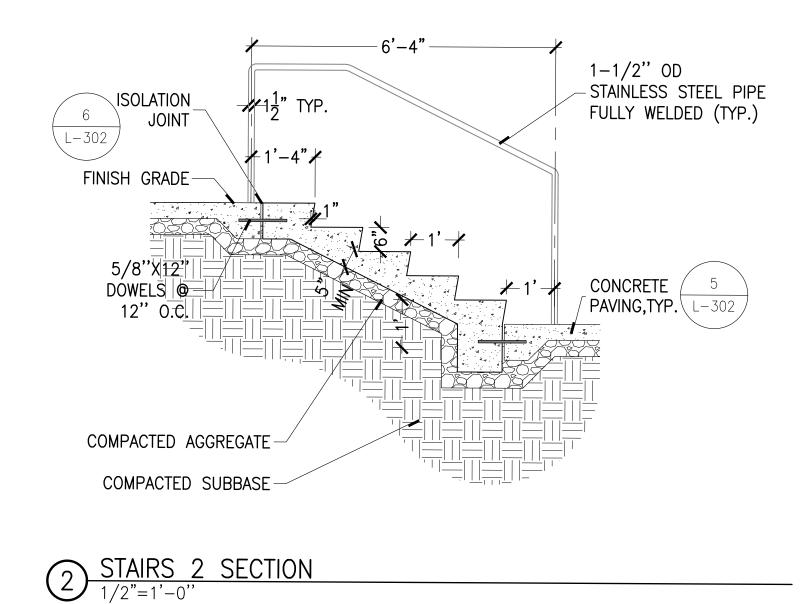

## GREENVILLE TOWN COMMON SYCAMORE HILL GATEWAY PLAZA


90% DESIGN SUBMISSION

ADDRESS: 201 W 1ST ST, GREENVILLE, NC 27858 Tel. 252.329.4567

OWNER:



DESIGN TEAM:

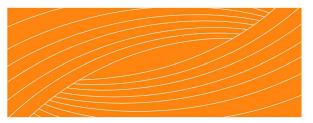

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## PERKINS+WILL


411 W. Chapel Hill St., Suite 200, Durham, NC 27701 919-433-5300 ph 919-433-5301 fx www.perkinswill.com


THE EAST GROUP GALLAGHER & ASSOCIATES BREE & ASSOCIATES LIGHT DEFINES FORMS INC ENGINEERING SOURCE


> NOT FOR CONSTRUCTION OR BIDDING

REVISION:	
SCALE:	N.T.S
SHEET NAME:	
	STAIRS
SHEET NUMBER:	1 704
	L-304

DATE:

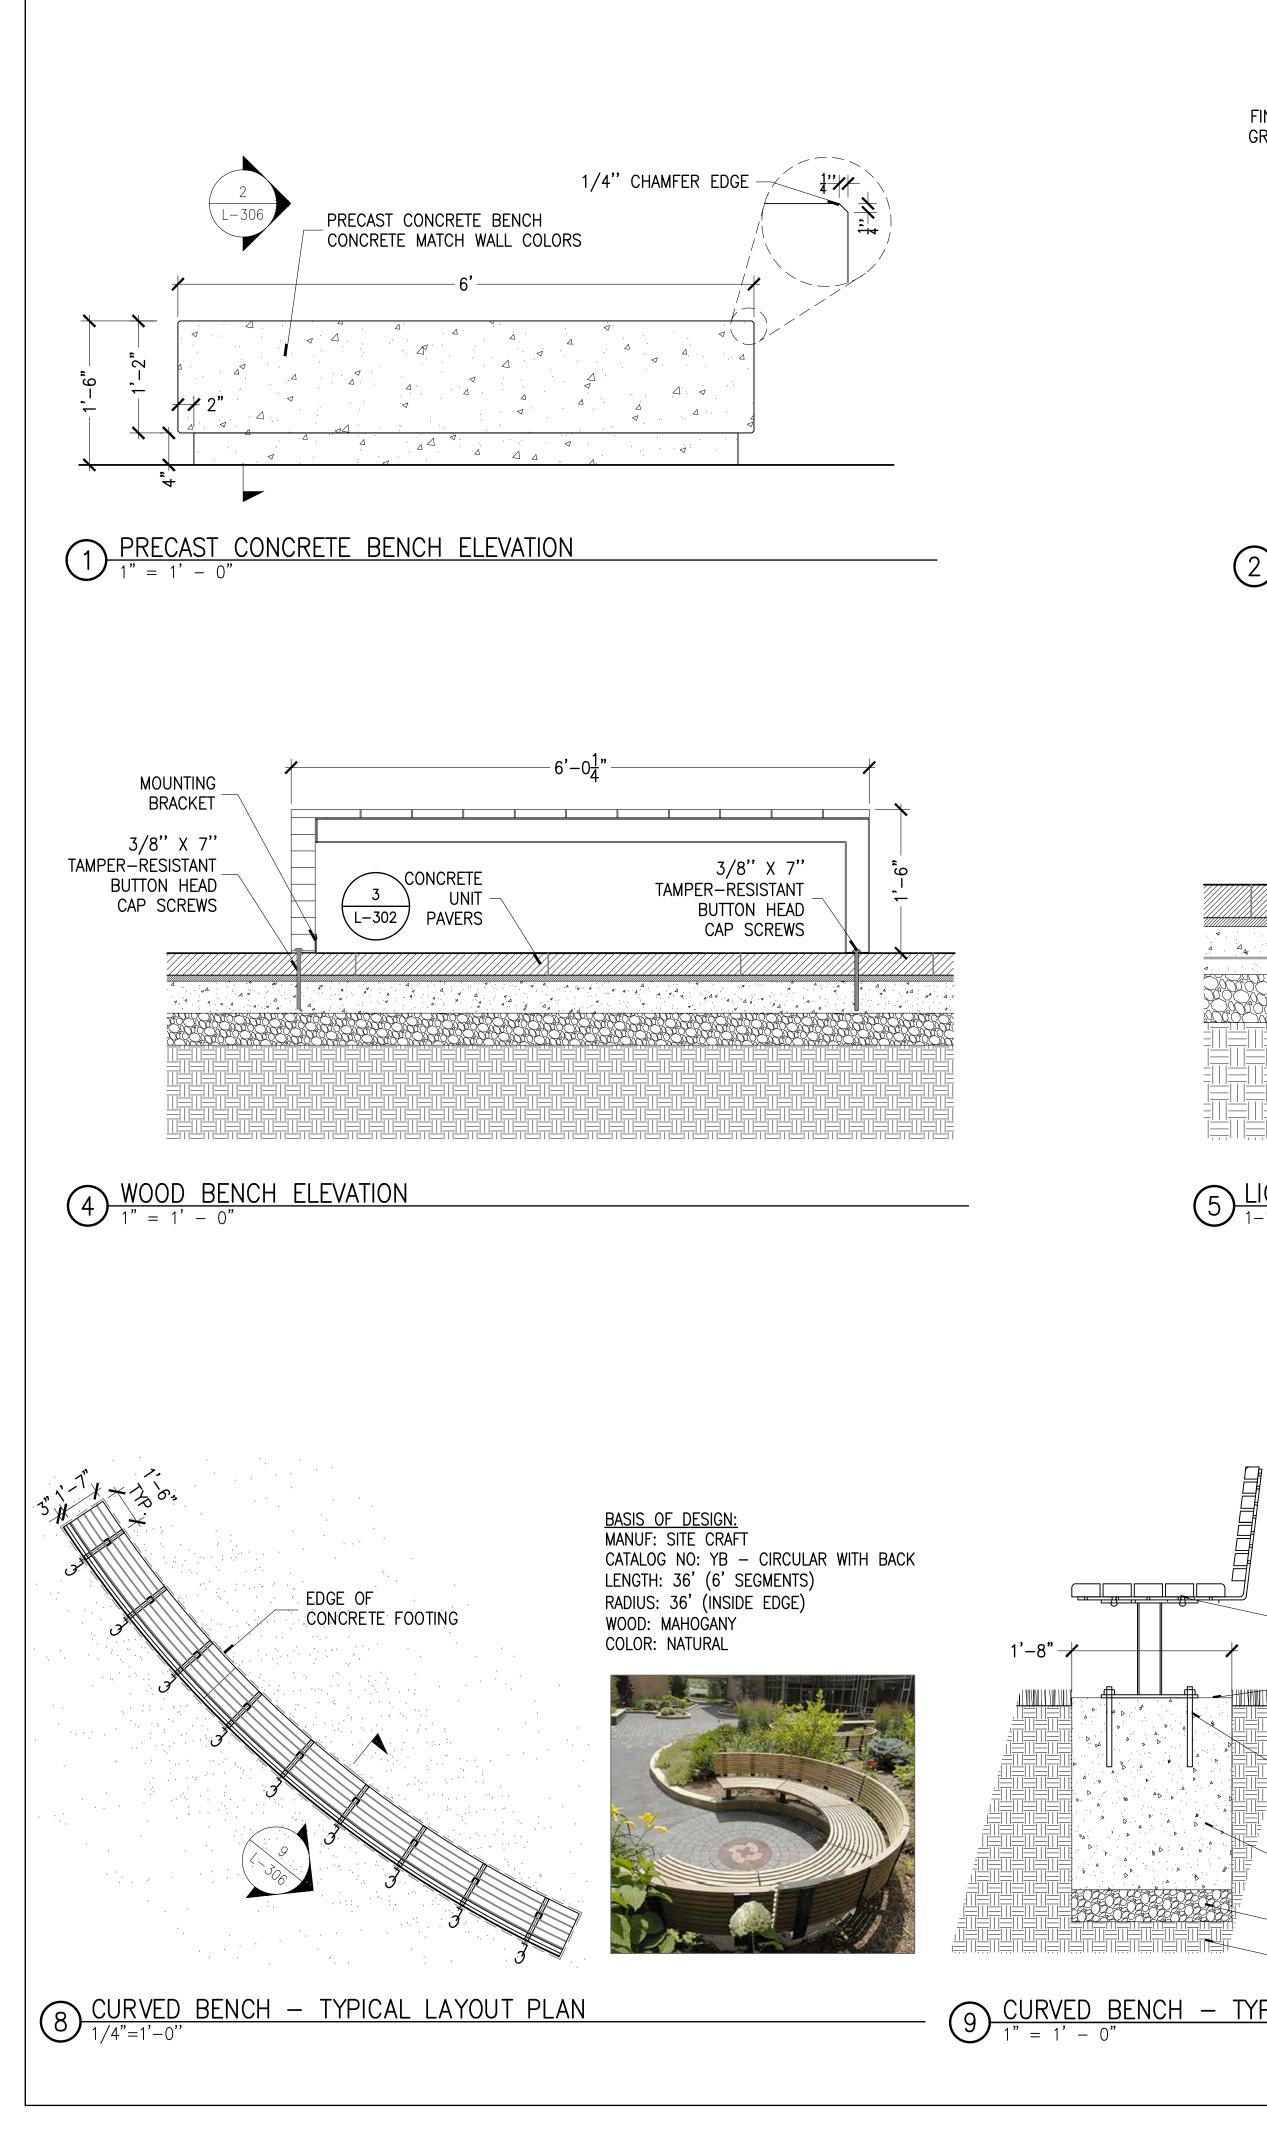

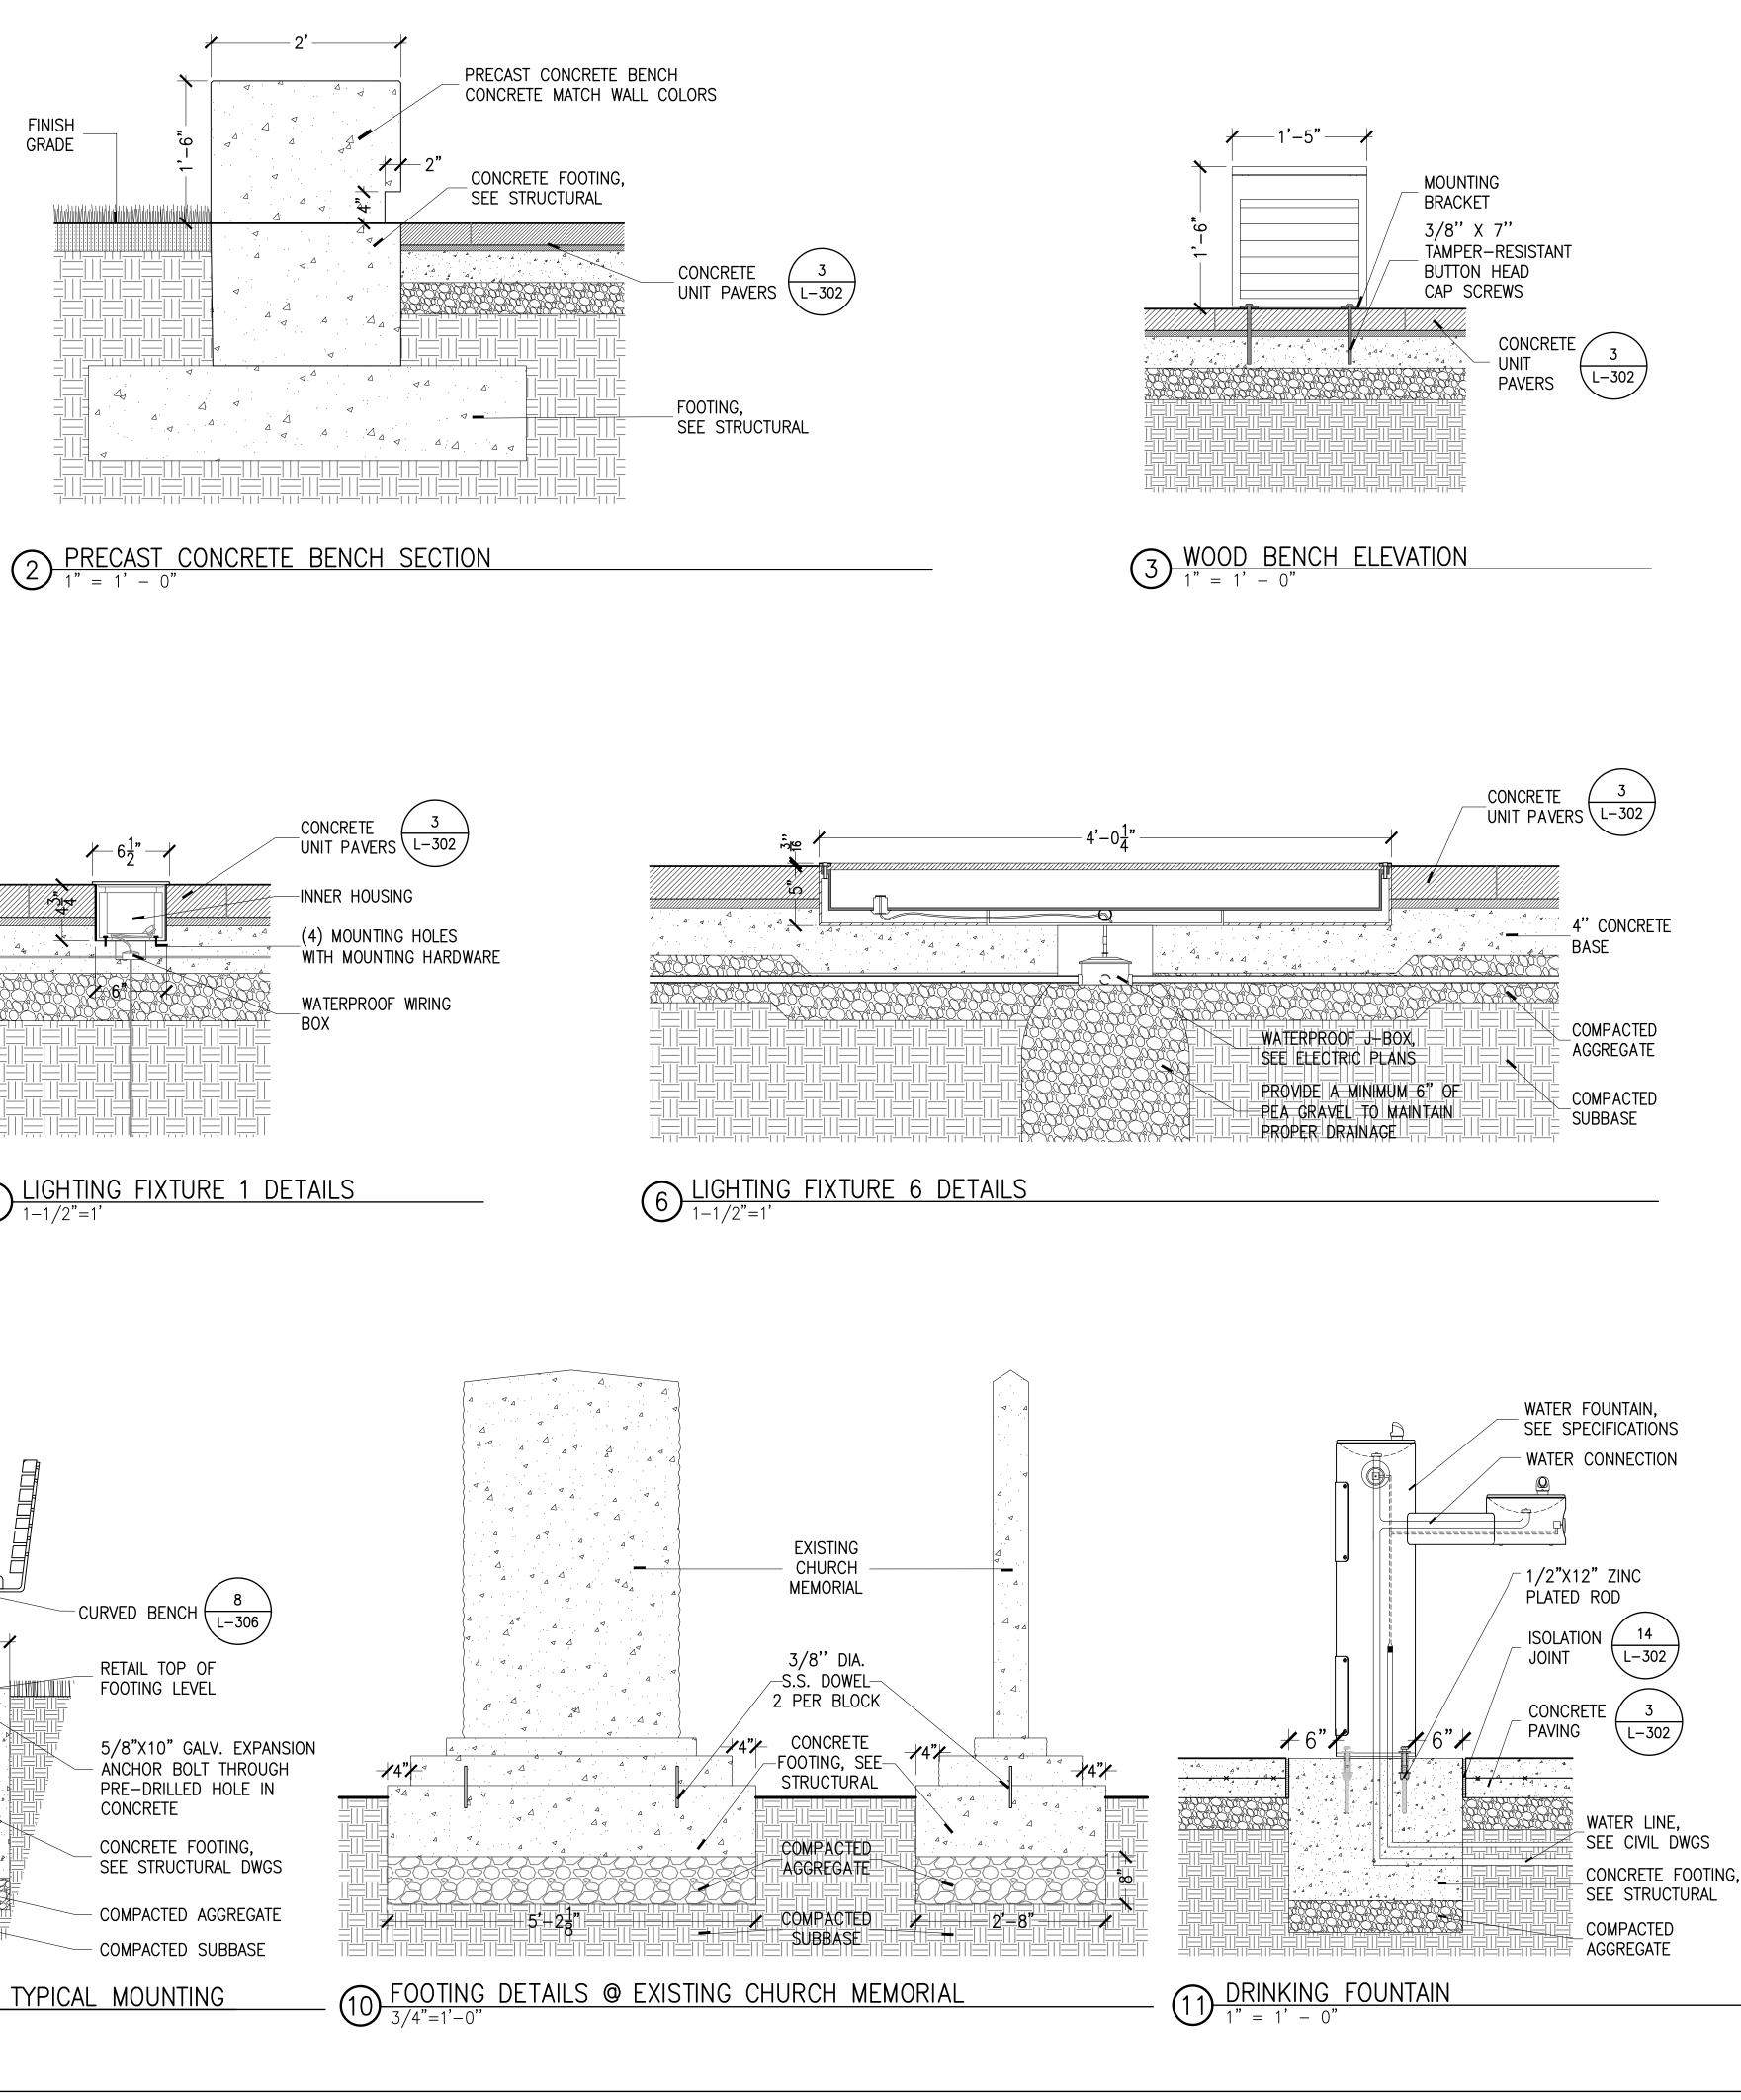

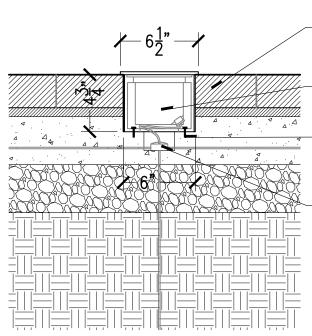

# 5 LIGHTING FIXTURE 1 DETAILS

CURVED BENCH B CURVED BENCH B L-306 RETAIL TOP OF FOOTING LEVEL 5/8"X10" GALV. EXPANSION ANCHOR BOLT THROUGH PRE-DRILLED HOLE IN CONCRETE CONCRETE FOOTING, SEE STRUCTURAL DWGS COMPACTED AGGREGATE COMPACTED SUBBASE	EXISTING CHURCH 3/8" DIA 5.S. DOWEL 2 PER BLOCK 4" CONCRETE FOOTING, SEE THE STRUCTURAL COMPACTED AGGREGATE SUBBASE
YPICAL MOUNTING	- 10 FOOTING DETAILS @ EXISTING CHURCH MEMORIAL

## GREENVILLE TOWN COMMON SYCAMORE HILL **GATEWAY PLAZA**


90% DESIGN SUBMISSION

ADDRESS: 201 W 1ST ST, GREENVILLE, NC 27858 Tel. 252.329.4567

OWNER:



DESIGN TEAM:

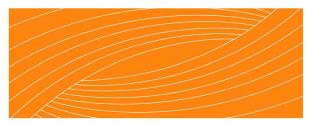

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Suite 300 Alexandria, VA 22314 703-683-7447 ph 703-683-7449 fx www.rhodeside-harwell.com

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NOT FOR
CONSTRUCTION
OR BIDDING

**REVISION:** 

SCALE:

DATE:


SHEET NAME:

SITE FURNISHINGS

N.T.S

SHEET NUMBER:

**L-306** 

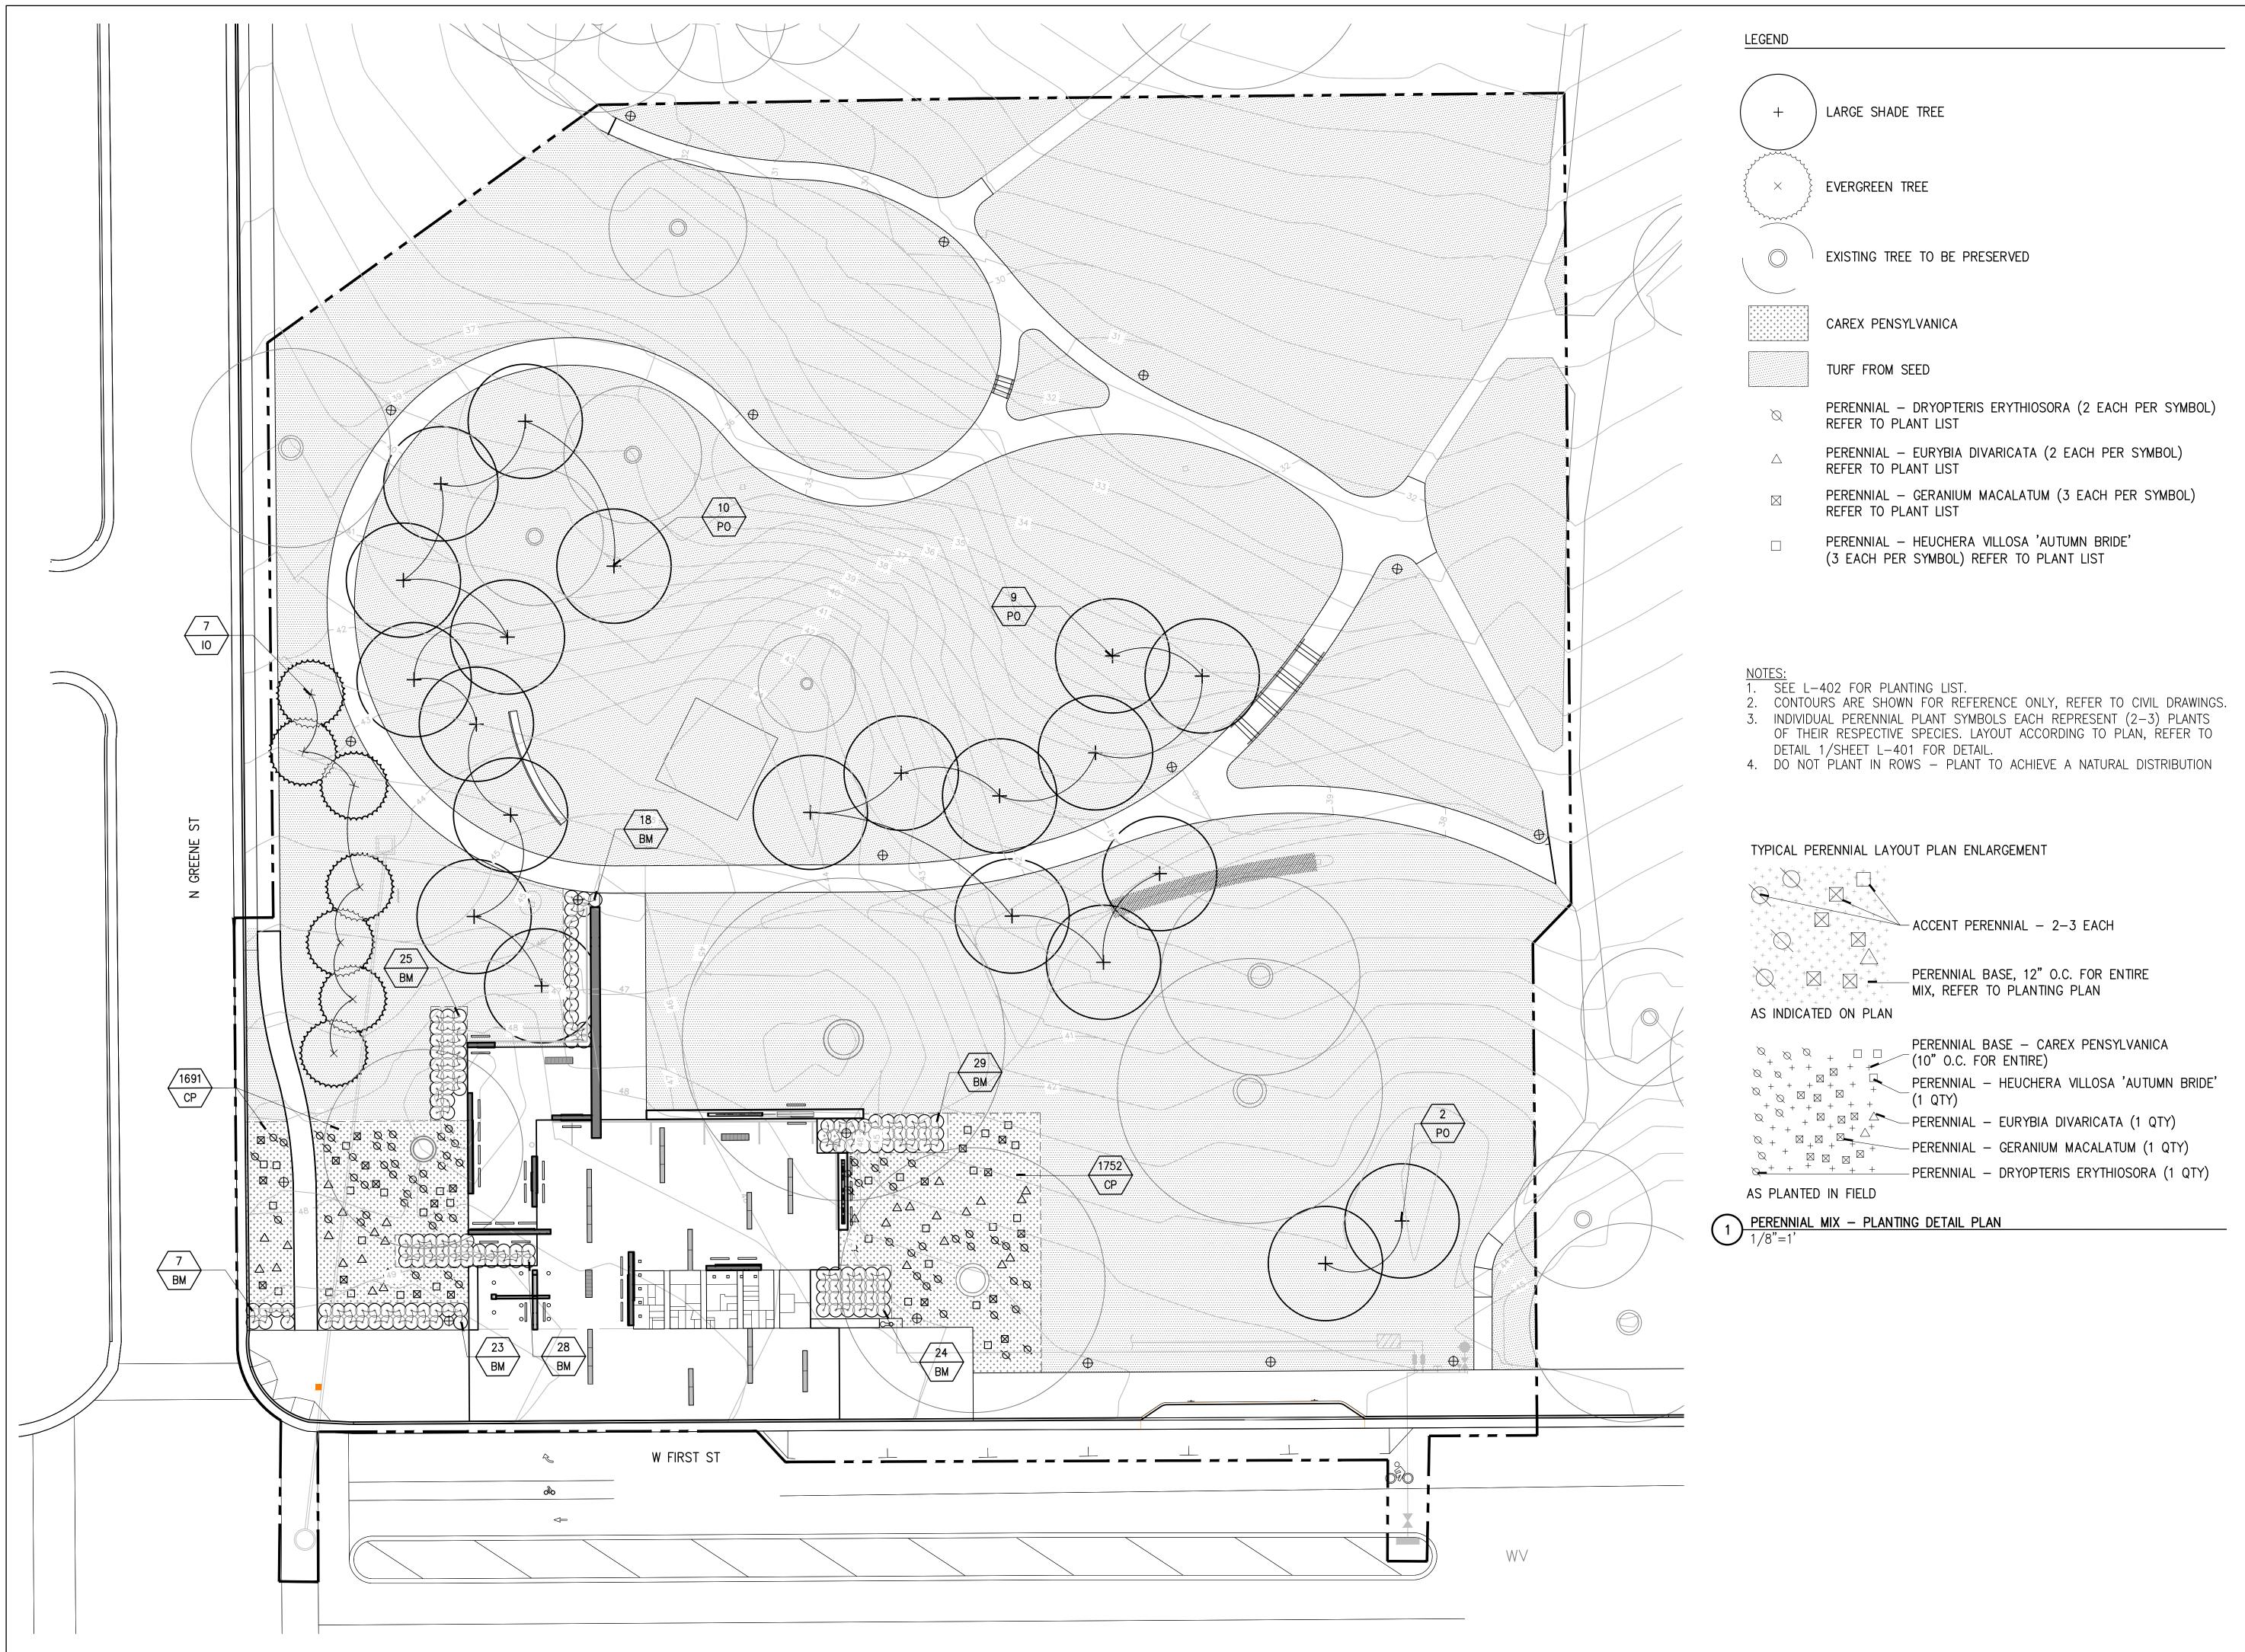

## GREENVILLE TOWN COMMON SYCAMORE HILL **GATEWAY PLAZA** 90% DESIGN SUBMISSION ADDRESS: 201 W 1ST ST, GREENVILLE, NC 27858 Tel. 252.329.4567 OWNER: Greenville NORTH CAROLINA CITY OF GREENVILLE, NC DESIGN TEAM: **RHODESIDE & HARWELL** 510 King Street Suite 300 Alexandria, VA 22314 703-683-7447 ph 703-683-7449 fx www.rhodeside-harwell.com PERKINS+WILL 411 W. Chapel Hill St., Suite 200, Durham, NC 27701 919-433-5300 ph 919-433-5301 fx www.perkinswill.com THE EAST GROUP GALLAGHER & ASSOCIATES BREE & ASSOCIATES LIGHT DEFINES FORMS INC ENGINEERING SOURCE NOT FOR CONSTRUCTION **OR BIDDING REVISION:**

SCALE:

1/16'' = 1' - 0''


SHEET NAME:

PLANTING PLAN

SHEET NUMBER:

L-401

DATE:

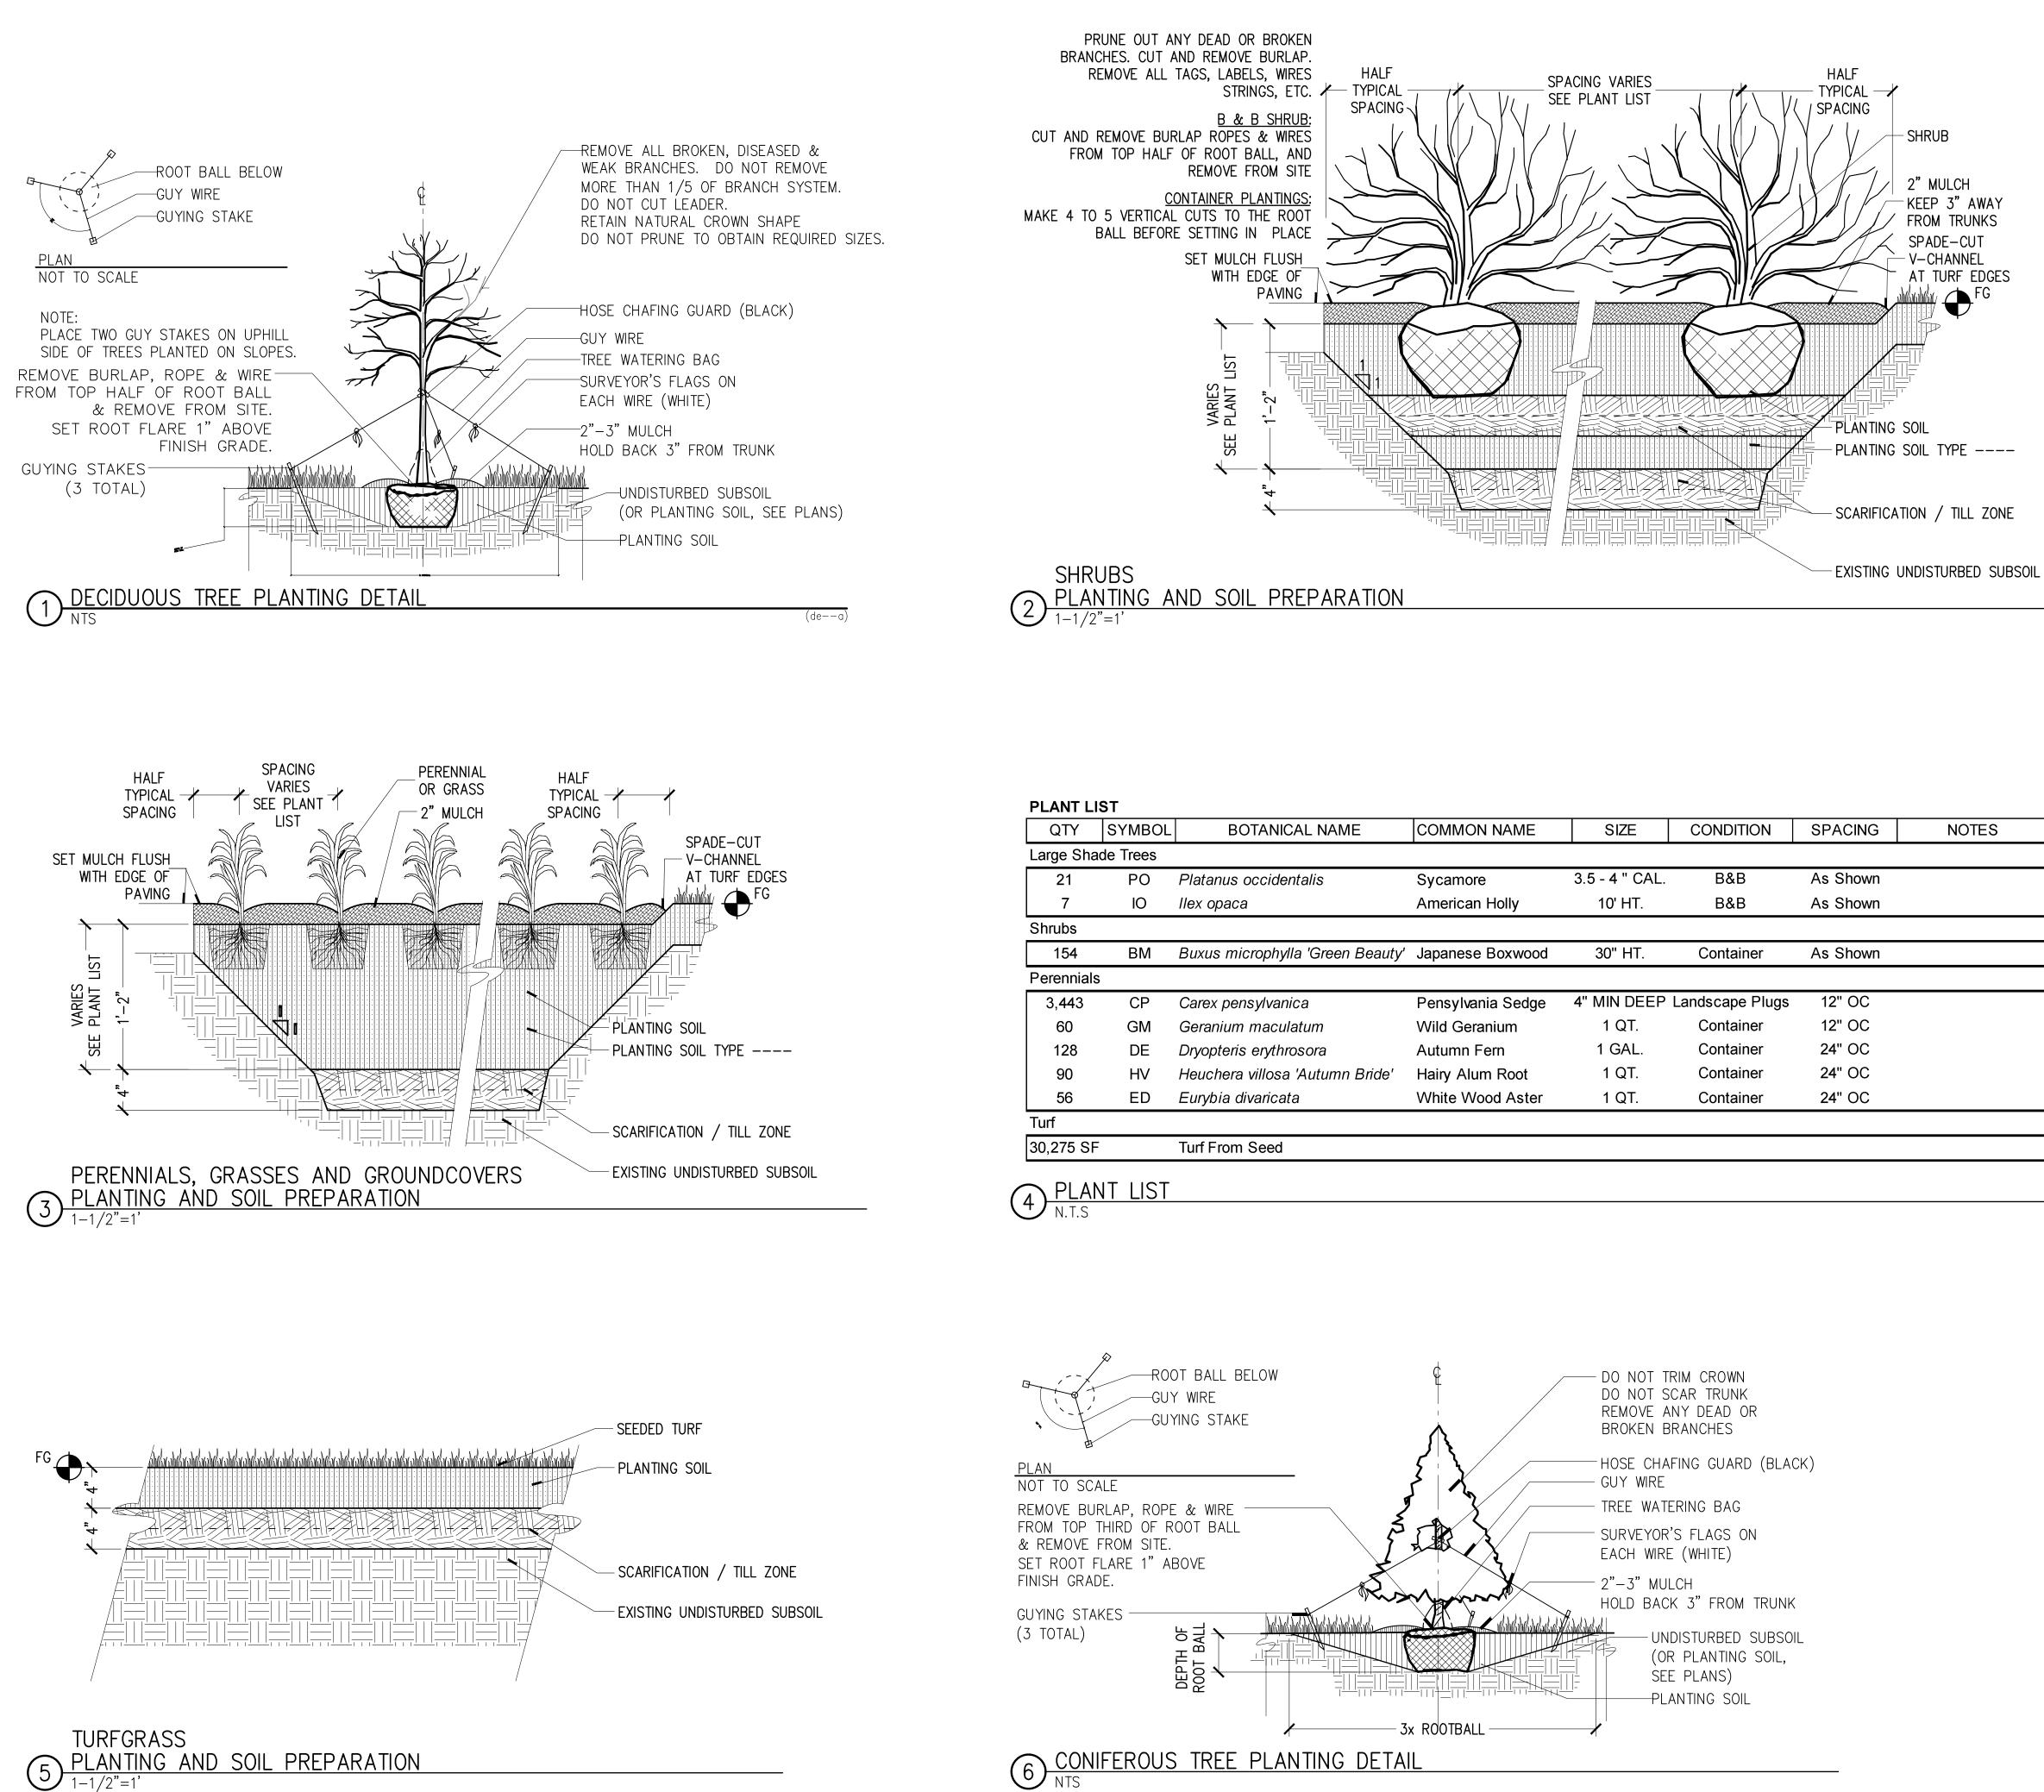

PLANT L	IST						
QTY	SYMBOL	BOTANICAL NAME	COMMON NAME	SIZE	CONDITION	SPACING	NOTES
Large Sha	ade Trees						
21	PO	Platanus occidentalis	Sycamore	3.5 - 4 " CAL.	B&B	As Shown	
7	IO	llex opaca	American Holly	10' HT.	B&B	As Shown	
Shrubs							
154	BM	Buxus microphylla 'Green Beauty'	Japanese Boxwood	30" HT.	Container	As Shown	
Perennial	S						
3,443	CP	Carex pensylvanica	Pensylvania Sedge	4" MIN DEEP	Landscape Plugs	12" OC	
60	GM	Geranium maculatum	Wild Geranium	1 QT.	Container	12" OC	
128	DE	Dryopteris erythrosora	Autumn Fern	1 GAL.	Container	24" OC	
90	HV	Heuchera villosa 'Autumn Bride'	Hairy Alum Root	1 QT.	Container	24" OC	
56	ED	Eurybia divaricata	White Wood Aster	1 QT.	Container	24" OC	
Turf							
30 275 SE	_	Turf From Seed					


90% DESIGN SUBMISSION

ADDRESS: 201 W 1ST ST, GREENVILLE, NC 27858 Tel. 252.329.4567

OWNER:



DESIGN TEAM:

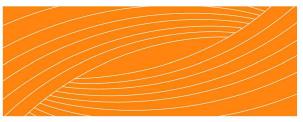

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THE EAST GROUP GALLAGHER & ASSOCIATES BREE & ASSOCIATES LIGHT DEFINES FORMS INC ENGINEERING SOURCE

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**REVISION:** 

SCALE:

SHEET NAME:


PLANTING SCHEDULE & DETAILS

N.T.S

SHEET NUMBER:

DATE:

**L-402** 

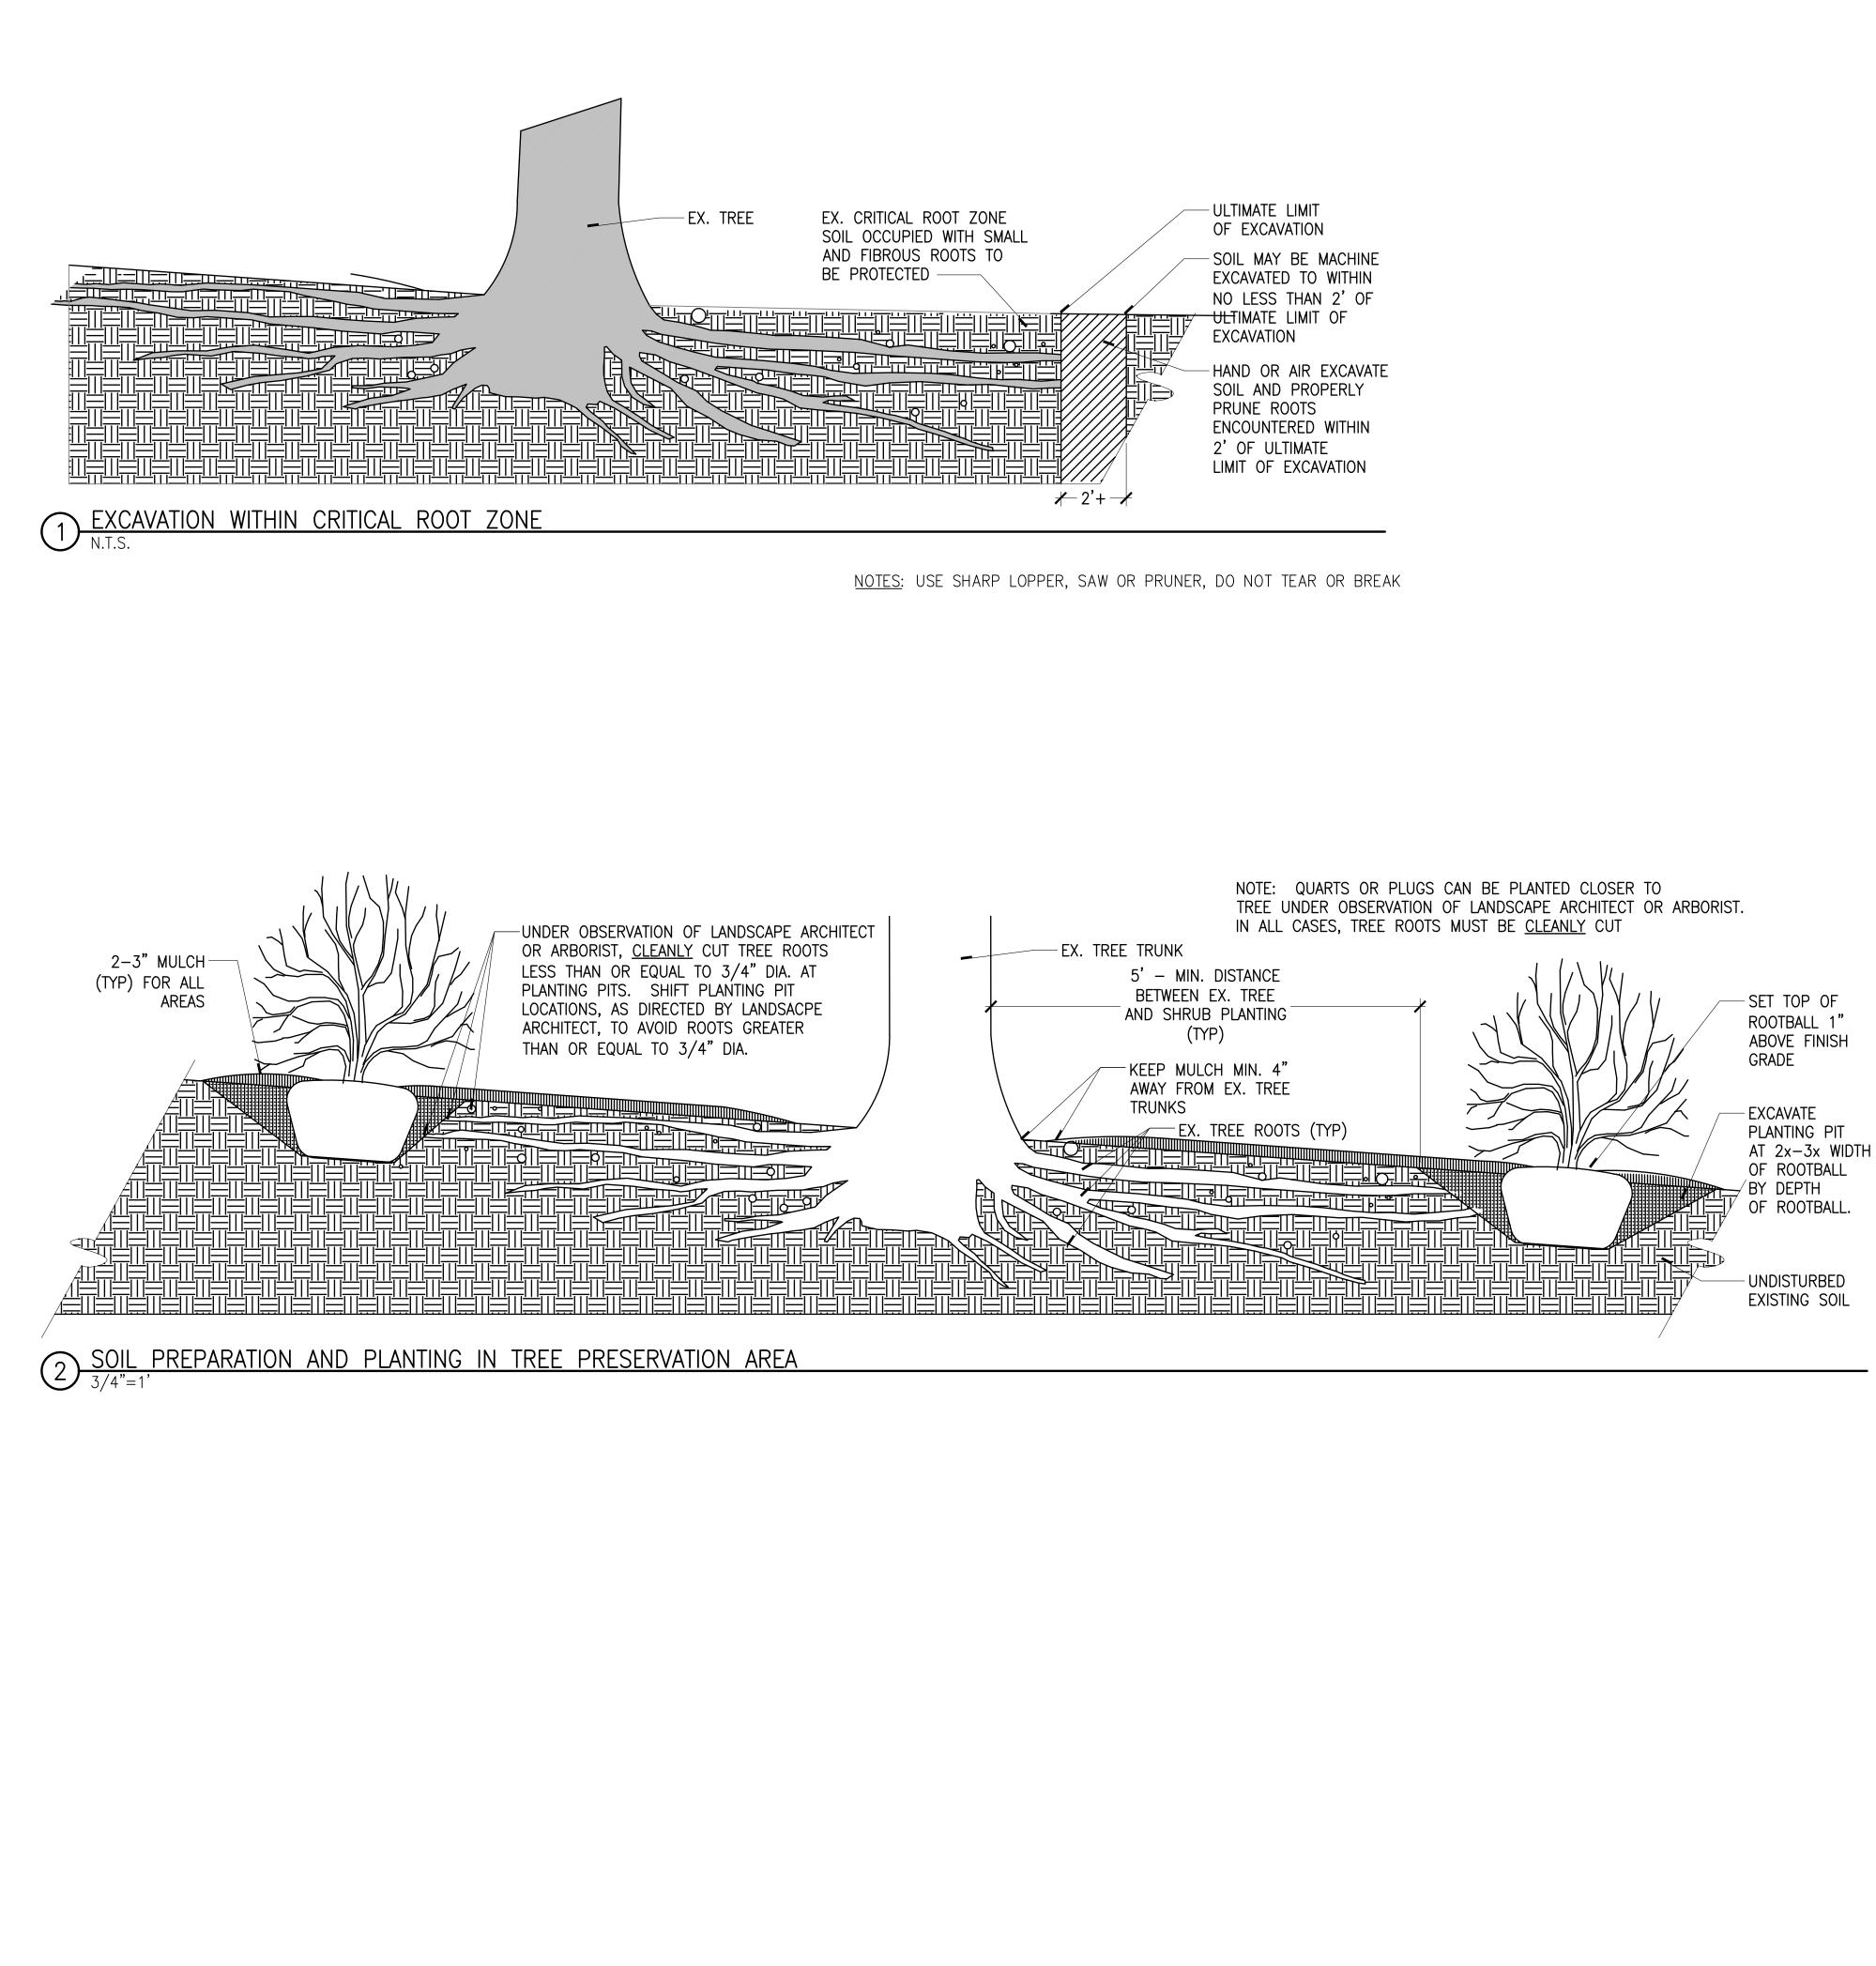


90% DESIGN SUBMISSION

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OWNER:



DESIGN TEAM:

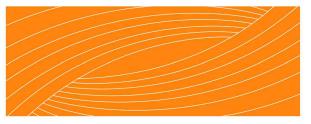

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**REVISION:** 

N.T.S

TREE PRESERVATION DETAILS

SHEET NUMBER:

**L-403** 

DATE:

SCALE:

SHEET NAME:



### KEYNOTE LEGEND

#### **KEYNOTE**

03 45 00 PRECAST ARCHITECTURAL CONCRETE

		CONCRETE ACCENTS (W-X)
05 50 00	METAL FABRICATIONS	STAINLESS STEEL (S.S.) MEMBERS AND ELEMENTS THROUGHOUT; FINISHES AND FASTENERS.

08 91 13 DECORATIVE GLASS GLAZING

08 91 13 DECORATIVE GLASS GLAZING CONTENT PANELS

05 12 13 ARCHITECTURAL EXPOSED STRUCTURAL STEEL (AESS)

AESS C: CUSTOM ELEMENTS - FOR ALL EXPOSED STRUCTURAL ELEMENTS ON WALL H, WALL I, AND GATEWAY TOWER

INTERPRETIVE GRAPHICS AND IMAGERY.

LAMINATED GLASS PANELS -

LAMINATED GLASS PANELS WITH

2 SOLID COLORS.

MONOLITHIC LIGHT GREY PRECAST CONCRETE

FEATURE WALLS W/ DARK CHARCOAL PRECAST

## ABBREVIATIONS

ABBREVIATION AESS BW FV P.C. CONC. TW

SS

DESCRIPTION ARCHITECTURAL EXPOSED STRUCTURAL STEEL BOTTOM OF WALL ELEVATION FIELD VERIFY PRE-CAST CONCRETE TOP OF WALL ELEVATION STAINLESS STEEL

DESCRIPTION

ILLUSTRATIVE PERSPECTIVE FROM FAITH GALLERY, LOOKING WEST.

## **GENERAL PROJECT NOTES**

- 1. REFER TO COMPLETE SET OF ISSUED CONTRACT DOCUMENTS FOR APPLICABLE NOTES, ABBREVIATIONS, AND SYMBOLS.
- 2. CONTRACTOR TO PROVIDE SHOP DRAWINGS FOR ALL ARCHITECTURAL PRECAST CONCRETE WALLS, DECORATIVE GLASS ASSEMBLIES, AND METAL PRODUCTS.
- 3. DO NOT SCALE THE DRAWING. IF DIMENSIONS ARE IN QUESTION, OBTAIN CLARIFICATION FROM THE ARCHITECT BEFORE CONTINUING.
- 4. DIMENSIONS SHOWN ON THE PLANS AND ELEVATIONS ARE TO THE FACE OF WALLS, TO CENTER LINE OF COLUMNS AND TO FACE OF CONCRETE OR MASONRY WALLS, UNLESS OTHERWISE INDICATED.
- 5. FIELD MEASURE AND CONFIRM DIMENSIONS.
- 6. REFER TO CIVIL DRAWINGS FOR ELEVATIONS.
- 7. REFER TO LANDSCAPE DRAWINGS FOR LAYOUT PLAN.
- 8. SEE A-500 DRAWING SERIES FOR CONTENT PANEL GRAPHICS AND DETAILS. NARRATIVE INCLUDED IN ADDENDUM.
- 9. APPROVE EXTERIOR OUTLET AND LIGHTING CONTROL BOX LOCATIONS WITH ARCHITECT.
- 10. WHERE MATERIALS ARE APPLIED TO, OR ARE IN DIRECT CONTACT WITH WORK INSTALLED BY ANOTHER SUBCONTRACTOR, COMMENCEMENT OF WORK IMPLIES ACCEPTANCE OF THE SUBSTRATE AS SUITABLE FOR THE APPLICATION INTENDED.
- 11. ISOLATE DISSIMILAR METALS TO PREVENT GALVANIC CORROSION.
- 12. SEALANTS ASSOCIATED WITH ARCHITECTURAL FEATURES EXPOSED TO VIEW SHALL BE CUSTOM COLOR AS SELECTED BY THE ARCHITECT.
- 13. COORDINATE LOCATION OF SEALANT AND COMPATIBILITY OF SEALANTS WITH ADJACENT WORK, INCLUDING MATERIALS AND OTHER CONTIGUOUS SEALANTS.

## GREENVILLE TOWN COMMON SYCAMORE HILL GATEWAY PLAZA

### 90% DESIGN SUBMISSION


#### ADDRESS:

201 W 1ST ST, GREENVILLE, NC 27858 Tel. 252.329.4567

OWNER:



DESIGN TEAM:

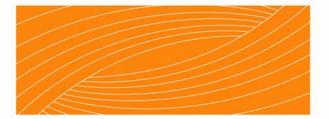

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### THE EAST GROUP GALLAGHER & ASSOCIATES BREE & ASSOCIATES LIGHT DEFINES FORMS INC ENGINEERING SOURCE

### NOT FOR CONSTRUCTION AND BIDDING

REVISION:		
SCALE:		
SHEET NAME:	<b>GENERAL NOTE</b>	S,
	SYMBOLS AN	D
	ABBREVIATION	IS
SHEET NUMBER:		
GHEET NOWDER.		
	A-000	J

## 2012 APPENDIX B - BUILDING CODE SUMMARY FOR ALL COMMERCIAL PROJECTS (EXCEPT 1 AND 2-FAMILY DWELLINGS AND TOWNHOUSES)

ROJECT INFORMATION								
ddress: 201 W. 1 roposed Use: PUBLIC	/ILLE TOWN COMMON: SYC st ST., GREENVILLE, NC PLAZA CITY OF GREENVILLE	AMORE HILL GATE	WAY PLAZA	27858				
wned By: ode Enforcement Jurisdiction		County	□ P	mail rivate ounty		<ul><li>□ State</li><li>□ State</li></ul>		STO
EAD DESIGN PROFESSIONA	L:	RWELL						
ESIGNER rchitectural	FIRM PERKINS+WILL	NAM MICHAEL ST		ICENSE # 4581	TELEPHONE 919.433.5348		-MAIL son@perkinswill.com	
rchitectural - PM	PERKINS+WILL	MICHAEL ST	EVENSON	4581	919.433.5348	michael.stevens	son@perkinswill.com	
ivil lectrical	TEG ENGINEERING SOURCE	MYRIAH SHE WILSON POL					nuk@eastgroup.com ngrsource.com	1
re Alarm Jumbing	NA NA							1 Fror
echanical prinkler-Standpipe	NA NA							
ructural	LYNCH MYKINS	COLLETTE R			919.809.8946	·	ynchmykins.com	
etaining Walls >5' High ther	LYNCH MYKINS LIGHT DEFINES FORM	COLLETTE R SCOTT RICH			919.809.8940 336.230.1990		ynchmykins.com dson@ldf.us	2 The
012 EDITION OF NC STATE C EXISTING:	CODE FOR:		ion A R GINAL USE(S) (C RRENT USE(S) (C DPOSED USE(S) (	epair H. 3) H. 3)				<sup>3</sup> Unli 4 Max <sup>5</sup> The
uilding data <u>not app</u>	PLICABLE							ALLOW
onstruction Type: heck all that apply)	□ I-A □ II-A □ I-B □ II-B	□ III-A □ III-B		□ V-A □ V-B				
prinklers:	□ No □ Partial □ Ye		NFPA 13	] NFPA 13R	🗆 NFPA 13	BD		Type of
tandpipes:	□ No □ Yes Class			] Dry				Type of Building
ire District: uilding Height: Feet45	□ No □ Yes (Primary)	Flood Haz	ard Area:	]No 🗆 Ye	S			Building
ross Building Area:								
•	NG (SQ FT) NEW (SQ F	T) SUBTOTAL	FLOOR		existing (SQ i	T) NEW (SQ FT)	SUBTOTAL	FIRE PR
								BUILDI
DTAL			TOTAL					Structu
LOWABLE AREA NOT APP								girders,
ccupancy:								Bearinç Ex
Assembly Business	□ A-1 □	] A-2	□ A-3	🗆 A-4		□ A-5		
Educational		] F-2 Low						
Factory Hazardous	□ H-1 Detonate □	H-2 Deflagrate	□ H-3 Combus		Health	□ H-5 HPM		
Institutional	□ I-1 □ I-3 Condition □	] I-2 ] 1	□ I-3 □ 2	□ I-4 □ 3		□ 4	□ 5	Inte Nonbea
Mercantile Residential	□ □ R-1 □	R-2	🗆 R-3	🗆 R-4				Ext
Storage	S-1 Moderate	S-2 Low	High-piled					
Utility and Miscelland	0 0	Open	□ Enclosed	🗆 Rep	bair Garage			
ccessory Occupancies: Assembly	□ A-1 □	] A-2	□ A-3	🗆 A-4		□ A-5		Int
Business		η <del>Γ</del> -Ζ						Inte
Educational Factory	□ □ F-1 Moderate □	] F-2 Low						Floor C beams
Hazardous Institutional		H-2 Deflagrate	□ H-3 Combus □ I-3	t □ H-4 □ I-4	Health	□ H-5 HPM		Roof C
	I-3 Condition		$\square$ 2			□ 4	□ 5	beams
Mercantile Residential	□ □ R-1 □	] R-2	🗆 R-3	🗆 R-4				Shaft E Shaft E
Storage		S-2 Low Open	☐ High-piled ☐ Enclosed	🗆 Reg	bair Garage			Corrido
Rooms with boile Refrigerant mach	: here any piece of equipment is ers where the largest piece of e hine room	equipment is over 15	•	ower	-			Occupa Party/F Smoke Tenant Inciden
<ul> <li>Incinerator rooms</li> <li>Paint shops, not</li> <li>Laboratories and</li> </ul>	classified as Group H, located vocational shops, not classifie	in occupancies othe		I-2 occupancy				* Indicate
Group I-2 waste	ver 100 square feet quipped with padded surfaces and linen collection rooms collection rooms over 100 squ							EXIT RI NUMBE
facility standby p Rooms containin Group I-2 storage Group I-2 comme	e rooms over 100 square feet	interrupted power su		) gallons, or a li	thium-ion capaci	ty of 1,000 pounds use	d for	FI SP/
Group I-2 rooms	or spaces that contain fuel-fire 402	ed heating equipmen ↓ □ 405 □	406 407		□ 409 □ 420		□ 412 □ 422	
_	413 414 415		□ 417 □ 418	3 🗌 419		□ 421 □ 422	□ 423	
								l l
Decial Provisions:	509.2 🗆 509.3	509.4 🗆 509			509.8	509.9		1 Coi

For each story, the area of the occupancy shall be such that the sum of the ratios of the actual floor area of each use divided by the allowable floor area for each use shall not exceed 1.

#### NOT APPLICABLE

Actual Area of Occupancy B Allowable Area of Occupancy B Actual Area of Occupancy A \_\_\_\_\_≤1 Allowable Area of Occupancy A

			+			= ≤	< 1.00
10.	DESCRIPTION AND USE	(A) BLDG. AREA PER STORY (ACTUAL)	(B) TABLE 503 AREA⁵	(C) AREA FOR FRONTAGE INCREASE <sup>1</sup>	(D) AREA FOR SPRINKLER INCREASE <sup>2</sup>	(E) ALLOWABLE AREA OR UNLIMITED <sup>3</sup>	(F) MAXIMUM BUILDING AREA⁴

area increases from Section 506.2 are computed thus:

Perimeter which fronts a public way or open space having 20 feet minimum width = \_\_\_\_\_ (F)

otal Building Perimeter = \_\_\_\_ (P) Ratio (F/P) = \_\_\_\_ (F/P)

' = Width of public way = \_\_\_\_ (W)

rea increase due to frontage I =  $[F/P - 0.25] \times W/30 =$ 

kler increase per Section 506.3 is as follows:

fulti-story building  $I_{\rm S}$  = 200 single story building  $I_{\rm S}$  = 300

I area applicable under conditions of Section 507.

n Building Area = total number of stories in the building  $x \in (506.4)$ .

imum area of open parking garages must comply with Table 406.3.5. The maximum area of air traffic control towers must comply with Table 412.3.2.

#### E HEIGHT NOT APPLICABLE

	ALLOWABLE (TABLE 503)	INCREASE FOR SPRINKLERS	SHOWN ON PLANS	CODE REFERENCE
truction	Туре		Туре	Table 503
nt in Feet		Feet = H + 20' =		504.2
nt in Stories		Stories + 1 =		504.2

ION REQUIREMENTS	NOT APPLICABL	<u>.</u>					
EMENT	FIRE SEPARATION DISTANCE (FEET)	REQ'D	RATING PROVIDED (W/  REDUCTION)	DETAIL # AND SHEET #	DESIGN # FOR RATED ASSEMBLY	DESIGN # FOR RATED PENETRATION	DESIGN # FOR RATED JOINTS
ne, including columns,							
lls and Partitions							
Ills							
Is and partitions							
tion including supporting ts							
ion including supporting ts							
es - Exit							
es - Other							
ation							
paration							
Separation							
Separation							
tion							
essory Separation							

tion number permitting reduction

#### EMENTS D ARRANGEMENT OF EXITS

ROOM OR SIGNATION	MINIMUM NUMBER OF EXITS <sup>2</sup>		TRAVEL DISTA	ARRANGEMENT MEANS OF EGRESS (SECTION 1015.2) <sup>1,3</sup>		
	REQUIRED	SHOWN ON PLANS	ALLOWABLE TRAVEL DISTANCE (TABLE 1016.1)	RAVEL DISTANCE SHOWN ON		ACTUAL DISTANCE SHOWN ON PLANS

Dead Ends (Section 1018.4)

s with single exits (Table 1021.2); Spaces with one means of egress (Table 1015.1) Path of Travel (Section 1014.3)

EXIT WIDTH - REFER TO LIFE SAFETY SHEETS FOR EXIT WIDTH INFORMATION

<u>Not api</u>	PLICABLE	
🗆 No	□ Yes	Section 1006
🗆 No	□ Yes	Section 1011
🗆 No	🗆 Yes	Section 907
🗆 No	🗆 Yes	Partial
🗆 No	□ Yes	Section 1008
	<ul> <li>No</li> <li>No</li> <li>No</li> <li>No</li> <li>No</li> </ul>	No     Yes       No     Yes       No     Yes       No     Yes

LIFE SAFETY PLAN REQUIREMENTS NOT APPLICABLE

Life Safety Plan Sheet #:  $\Box$  Fire and/or smoke rated wall locations (Chapter 7)

□ Assumed and real property line locations

Exterior wall opening area with respect to distance to assumed property lines (705.8)

Existing structures within 30' of the proposed building

□ Occupancy types for each area as it relates to occupant load calculation (Table 1004.1.1) Occupant load for each area

 $\Box$  Exit access travel distances (1016)

□ Common path of travel distances (1014.3 & 1028.8)

Dead end lengths (1018.4)

Clear exit widths for each exit door

□ Maximum calculated occupant load capacity each exit door can accommodate based on egress width (1005.1)

Actual occupant load for each exit door

A separate schematic plan indicating where fire rated floor/ceiling and/or roof structure is provided for purposes of occupancy separation  $\Box$  Location of doors with panic hardware (1008.1.10)

□ Location of doors with delayed egress locks and the amount of delay (1008.1.9.7)

□ Location of doors with electromagnetic egress locks (1008.1.9.8)

□ Location of doors equipped with hold-open devices

 $\Box$  Location of emergency escape windows (1029)

 $\Box$  The square footage of fire area (902)

□ The square footage of each smoke compartment (407.4) □ Note any code exceptions or table notes that may have been utilized regarding the items above

ACCESSIBLE DWEL (SECTION 1107)	APPLICABLE		
TOTAL UNITS	ACCESSIBLE UNITS	ACCESSIBLE UNITS	ΤY

TOTAL UNITS	ACCESSIBLE UNITS REQUIRED	accessible Units Provided	type a Units Required	TYPE A UNITS PROVIDED	TYPE B UNITS REQUIRED	TYPE B UNITS PROVIDED	TOTAL ACCESSIBLE UNITS PROVIDED
XXX	XXX	XXX	XXXX	XXX	XXX	XXX	ХХ

ACCESSIBLE PARKING

SEE LANDSCAPE ARCHITECTURE / CIVIL (SECTION 1106)

ſ		TOTAL # OF PARKING SPACES		# OF ACCESSIBLE SPACES PROVIDED			TOTAL #
LOT OR	DEOLUDED		<b>REGULAR WITH 5'</b>	VAN SPACES WITH		ACCESSIBLE	
	PARKING AREA	REQUIRED PI	PROVIDED	ACCESS AISLE	132" ACCESS AISLE	8' ACCESS AISLE	PROVIDED
ſ	PARKING LOT						
	TOTAL						

NOT APPLICABLE

# GREENVILLE TOWN COMMON

## SYCAMORE HILL **GATEWAY PLAZA**

### 90% DESIGN SUBMISSION


### ADDRESS:

201 W 1ST ST, GREENVILLE, NC 27858 Tel. 252.329.4567

OWNER:



DESIGN TEAM:

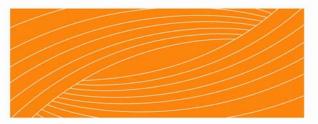

RHODESIDE&HARWELL 510 King Street Suite 300 Alexandria, VA 22314 703-683-7447 ph 703-683-7449 fx www.rhodeside-harwell.com

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THE EAST GROUP GALLAGHER & ASSOCIATES **BREE & ASSOCIATES** LIGHT DEFINES FORMS INC **ENGINEERING SOURCE** 

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REVISION:
SCALE:
SHEET NAME:
CODE COMPLIANCE
DATA - PART 01
SHEET NUMBER:
A001

STRUCTUR DESIGN LO Import

Live L

Groun Wind L

SEISMIC DI Provide the Occupa

Spectra Site Cla Basic

Seismi Analys Archite LATERAL E SOIL BEAR Field T

Presun Pile siz SPECIAL IN PLUMBING

(TABLE 290 OCCUI USE G

SPACE

SPECIAL AI **Special Ap** 

\_\_\_\_\_

\_\_\_\_\_

## **2012 APPENDIX B - BUILDING CODE SUMMARY FOR ALL COMMERCIAL PROJECTS** (EXCEPT 1 AND 2-FAMILY DWELLINGS AND TOWNHOUSES)

RAL DESIGN	ENERGY SUMMARY NOT APPLICABLE
DADS: tance Factors: Wind (I <sub>w</sub> ) 1.0	ENERGY REQUIREMENTS:
Snow (Is)     1.0       Seismic (IE)     1.0       Loads:     Roof	The following data shall be considered minimum and any special attribute required to r portions of the project information for the plan data sheet. If performance method, sta cost for the proposed design.
Floor Floor	Climate Zone: 3 4 5
Floor Floor	Method of Compliance:
Floor	Prescriptive (Energy Code)
	Performance (Energy Code)
nd Snow Load: <u>10</u> psf	<ul><li>Prescriptive (ASHRAE 90.1)</li><li>Performance (ASHRAE 90.1)</li></ul>
Load: Basic Wind Speed <u>105</u> mph (ASCE-7) Exposure Category <u>C</u>	
Wind Base Shears (for MWFRS) $V_x = \underline{NA}$ $V_y = \underline{NA}$ ESIGN CATEGORY	THERMAL ENVELOPE       NOT APPLICABLE         Roof/ceiling Assembly       (each assembly)         Description of assembly
following Seismic Design Parameters: vancy Category (Table 1604.5) □ I ■ II □ III □ IV	U-Value of total assembly
ral Response Acceleration S <sub>s</sub> %g S <sub>1</sub> %g	R-Value of insulation
lassification (Table 1613.5.2)	U-Value of skylight
Structural System (check one)         Bearing Wall         Dual w/ Special Moment Frame         Dual w/ Intermediate R/C or Special Steel	total square footage of skylights in each assembly Exterior Walls (each assembly)
$\Box \text{ Moment Frame} \qquad \Box \text{ Inverted Pendulum}$ ic Base Shear: $V_x = NA \qquad V_y = NA$	Description of assembly
sis Procedure: ■ Simplified □ Equivalent Lateral Force □ Dynamic tectural, Mechanical, Components anchored ? □ Yes ■ No	U-Value of total assembly
DESIGN CONTROL: $\Box$ Earthquake $\Box$ Wind NA	Openings (windows or doors with glazing) ASSEMBLY 01 (FILL II
RING CAPACITIES: NA	U-Value of assembly
Fest (provide copy of test report) psf mptive Bearing Capacity psf	projection factor Door R-Values
ze, type, and capacity	Walls below grade (each assembly)
NSPECTIONS REQUIRED: □ Yes ■ No	Description of assembly
FIXTURE REQUIREMENTS	U-Value of total assembly
02.1)	
PANCY WATER CLOSETS URINALS LAVATORIES SHOWERS/ DRINKING FOUNTAINS GROUP MALE FEMALE MALE FEMALE TUBS REGULAR ACCESSIBLE	Floors over unconditioned space (each assembly) Description of assembly
EXISTING EXISTING	U-Value of total assembly
NEW I I I I I I I I I I I I I I I I I I I	
REQUIRED	Floors slab on grade Description of assembly
	U-Value of total assembly
PPROVALS <u>NOT APPLICABLE</u> proval: (Local Jurisdiction, Department of Insurance, OSC, DPI, DHHS, ICC, etc., describe below)	R-Value of insulation
	Horizontal/vertical requirement
	MECHANICAL SUMMARY <u>NOT APPLICABLE</u>
	MECHANICAL SYSTEMS, SERVICE SYSTEMS AND EQUIPMENT
	Thermal Zone winter dry bulb
	summer dry bulb
	Interior design conditions winter dry bulb
	summer dry bulb
	relative humidityBuilding heating load:
	Building cooling load:
	Mechanical Spacing Conditioning System
	Unitary         SEE PLANS AND SPECIFICATIONS           description of unit:         SEE PLANS AND SPECIFICATIONS
	heating efficiency: SEE PLANS AND SPECIFICATIONS
	cooling efficiency:SEE PLANS AND SPECIFICATIONSsize category of unit:SEE PLANS AND SPECIFICATIONS
	Boiler
	Size category. If oversized, state reason:Chiller
	Size category. If oversized, state reason:
	List equipment efficiencies: SEE PLANS AND SPECIFICATIONS
	ELECTRICAL SUMMARY NOT APPLICABLE
	ELECTRICAL SYSTEM AND EQUIPMENT METHOD OF COMPLIANCE:
	Energy Code:  Prescriptive  Performance
	ASHRAE 90.1:
	Lighting schedule (each fixture type)
	lamp type required in fixtureSEE ENERGY CODE STATEMENTnumber of lamps in fixtureSEE ENERGY CODE STATEMENT
	ballast type used in the fixture SEE ENERGY CODE STATEMENT
	number of ballasts in fixtureSEE ENERGY CODE STATEMENTtotal wattage per fixtureREFER TO ELECTRICAL SHEETS
	total interior wattage specified vs allowed (whole building or space by space) total exterior wattage specified vs allowed
	Equipment schedules with motors
	506.2.1 More Efficient Mechanical Equipment
	506.2.2 Reduced Lighting Power Density
	506.2.3 Energy Recovery Ventilation Systems
	<ul> <li>506.2.4 Higher Efficiency Service Water Heating</li> <li>506.2.5 On-Site Supply of Renewable Energy</li> </ul>

### o meet the energy code shall also be provided. Each Designer shall furnish the required state the annual energy cost budget for the standard reference design vs. annual energy

ASSEMBLY 02 (FILL IN)

#### NT LOCATED ON ELECTRICAL SHEETS NT LOCATED ON ELECTRICAL SHEETS NT LOCATED ON ELECTRICAL SHEETS NT LOCATED ON ELECTRICAL SHEETS

REFER TO ELECTRICAL SHEETS REFER TO ELECTRICAL SHEETS

# GREENVILLE TOWN COMMON

## SYCAMORE HILL GATEWAY PLAZA

### 90% DESIGN SUBMISSION


#### ADDRESS:

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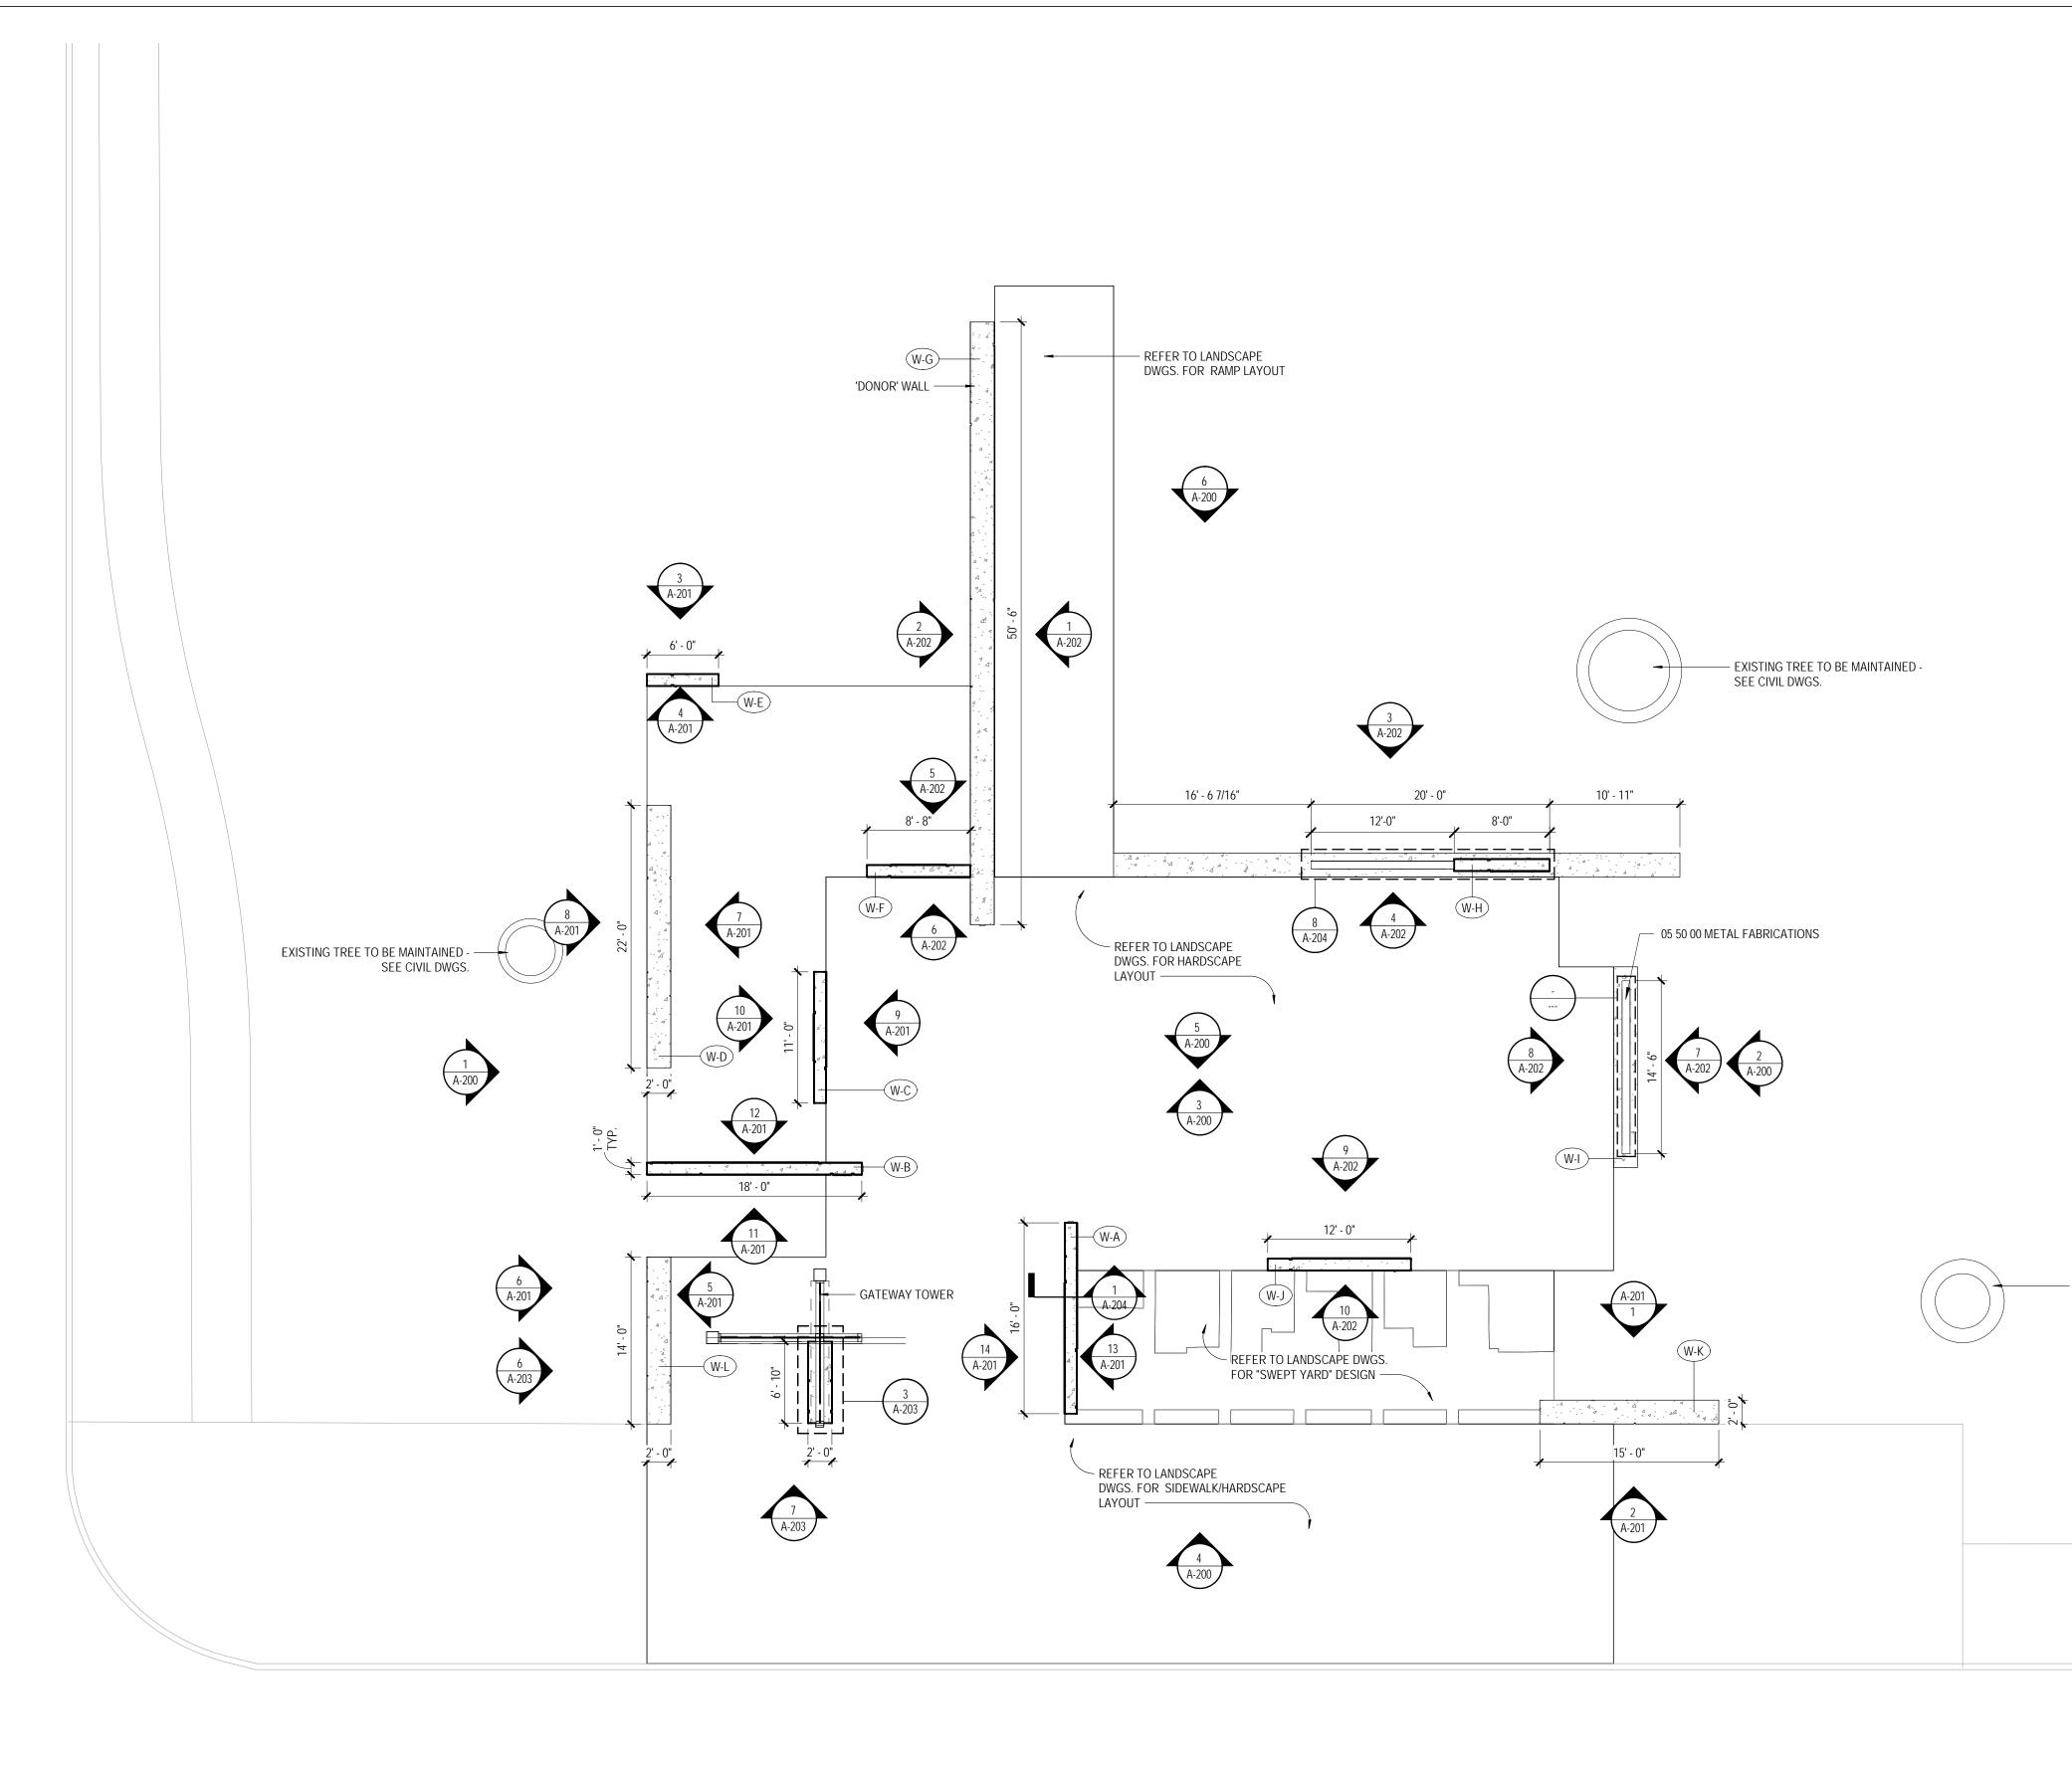
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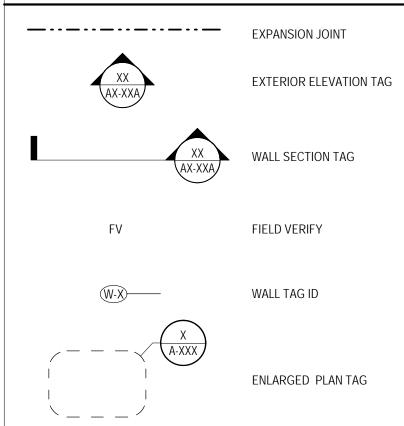
NOT FOR CONSTRUCTION AND BIDDING

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SCALE:	
SHEET NAME:	
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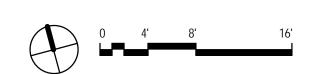


## 1 ARCHITECTURAL WALL AND SITE PLAN

## FLOOR PLAN LEGEND

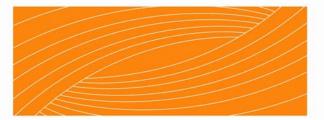

#### - EXISTING TREE TO BE MAINTAINED -SEE CIVIL DWGS.



## GREENVILLE TOWN COMMON SYCAMORE HILL

## SYCAMORE HILL GATEWAY PLAZA

### 90% DESIGN SUBMISSION


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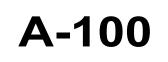
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**REVISION:** 


SCALE:

SHEET NAMF ARCHITECTURAL SITE PLAN


SHEET NUMBER:

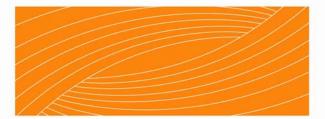

DATE:

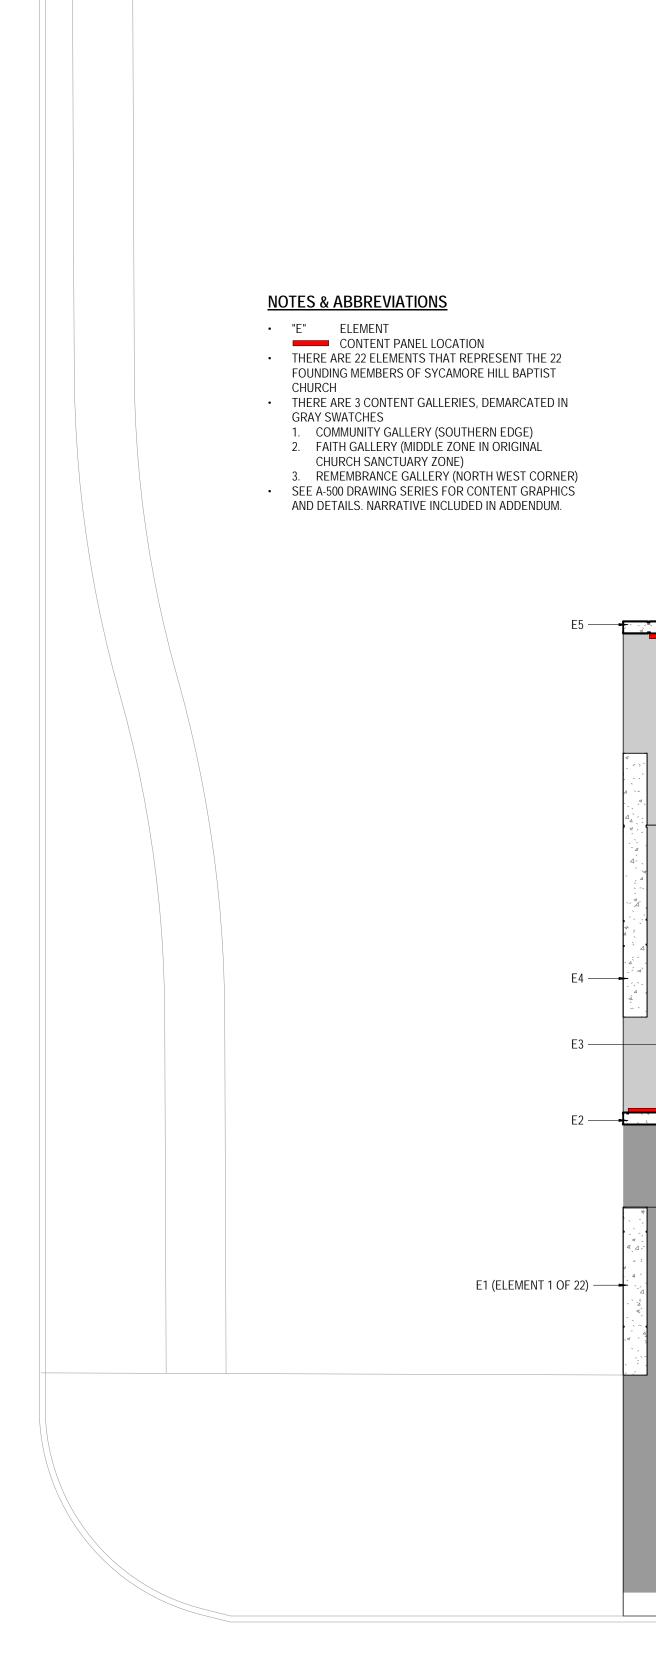

### INTERPRETIVE CONTENT PLAN + 22 <u>ELMENTS - DIAGRAM</u> 1/8" = 1'-0"

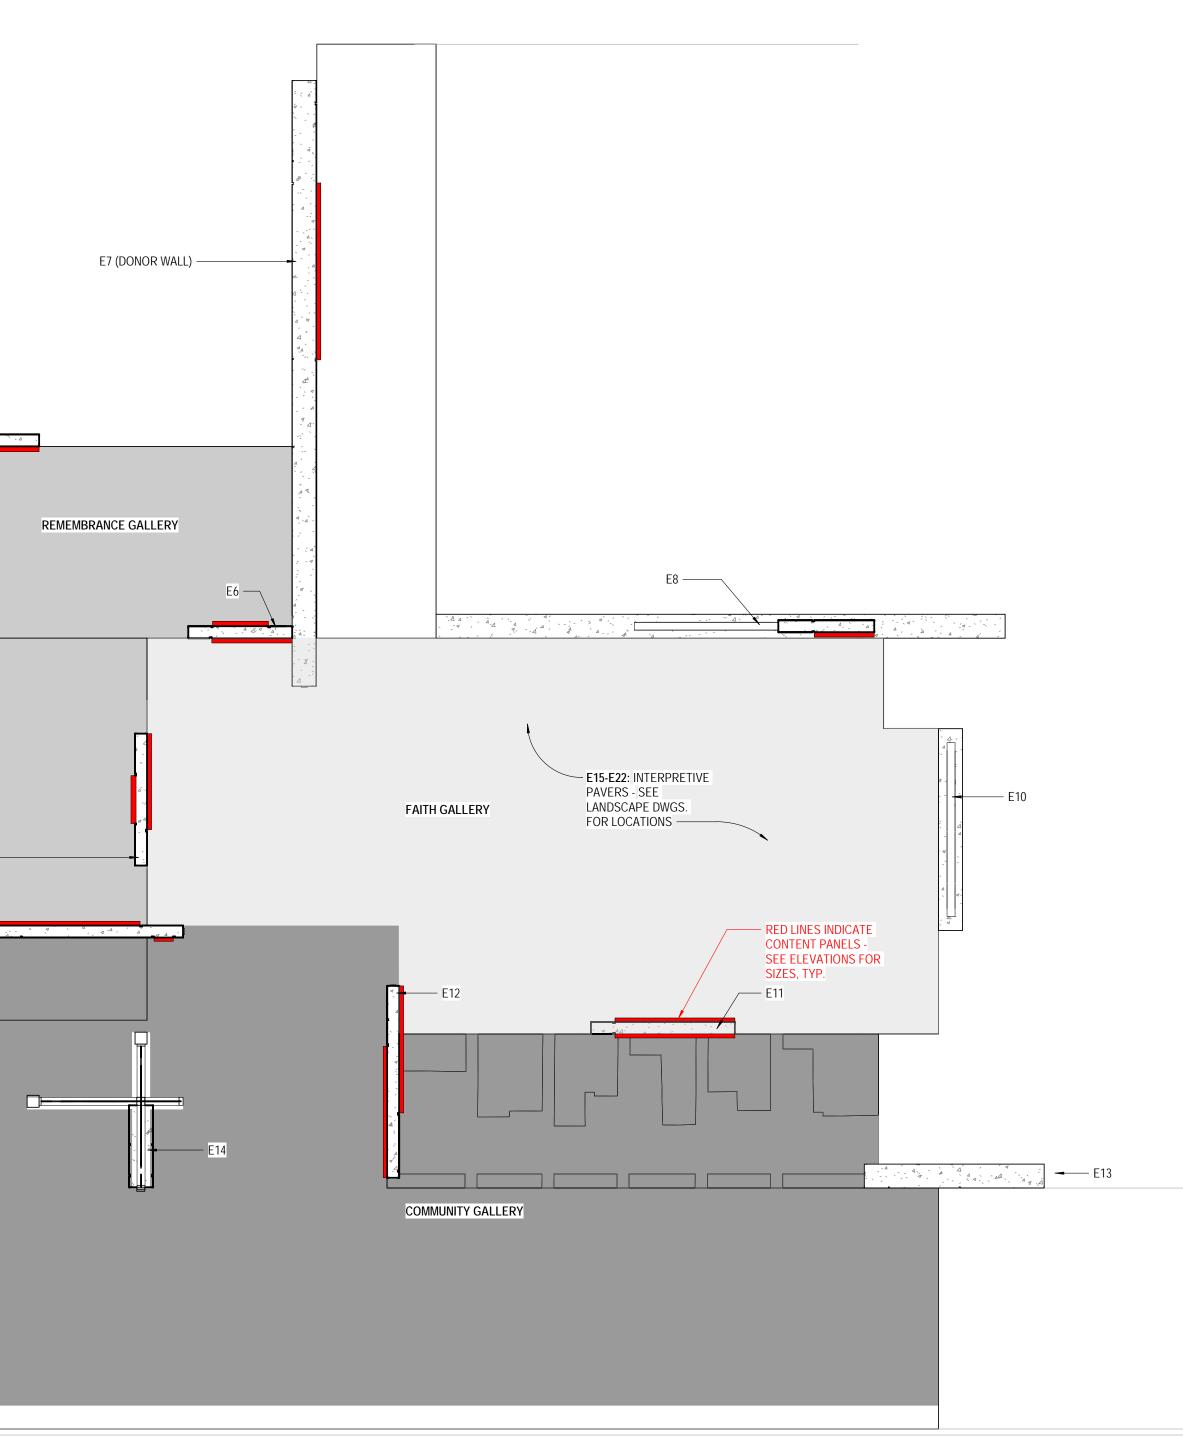

## GREENVILLE TOWN COMMON SYCAMORE HILL

## GATEWAY PLAZA

## 90% DESIGN SUBMISSION

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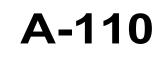
> NOT FOR CONSTRUCTION AND BIDDING

REVISION:

SCALE:

SHEET NAME INTERPRETIVE CONTENT DIAGRAM


SHEET NUMBER:




#### REFER TO STRUCTURAL DWGS. FOR STRUCTURAL FRAMING DETAILS, TYP.

03 45 00 PRECAST . ARCHITECTURAL CONCRETE

05 50 00 METAL FABRICATIONS

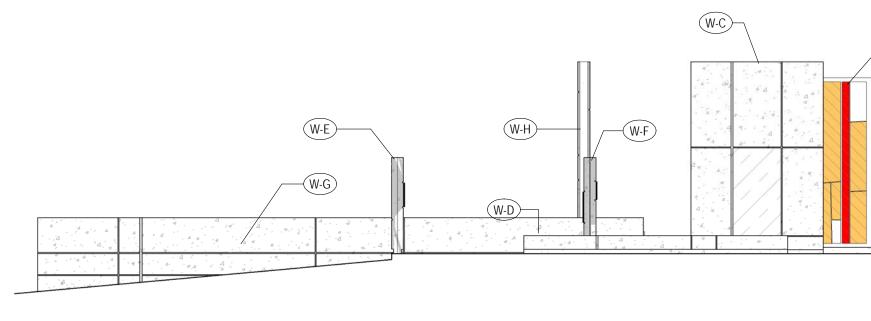





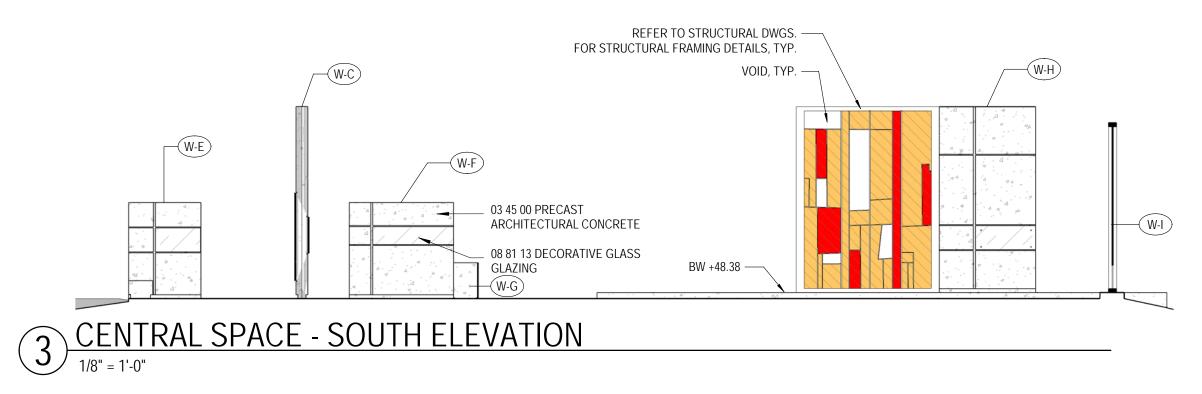


REFER TO STRUCTURAL DWGS. FOR STRUCTURAL FRAMING DETAILS, TYP. VOID, TYP. -


05 50 00 METAL FABRICATIONS

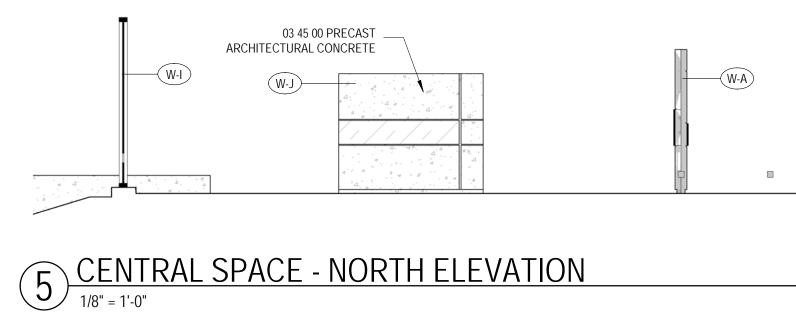


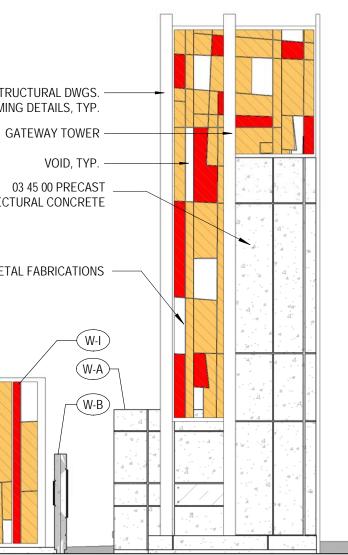


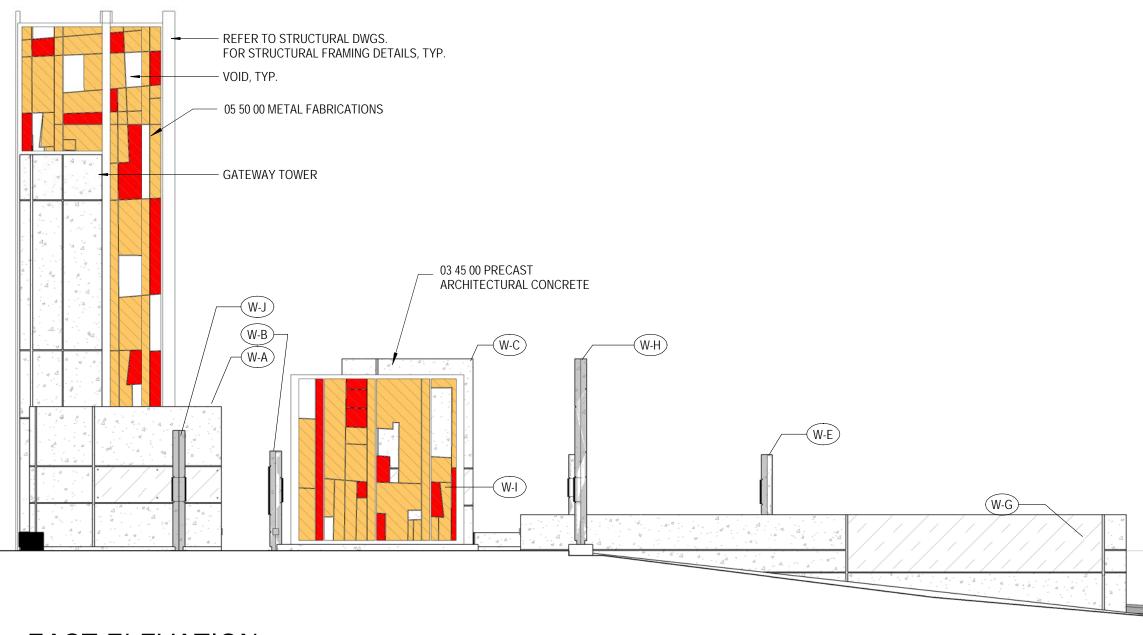



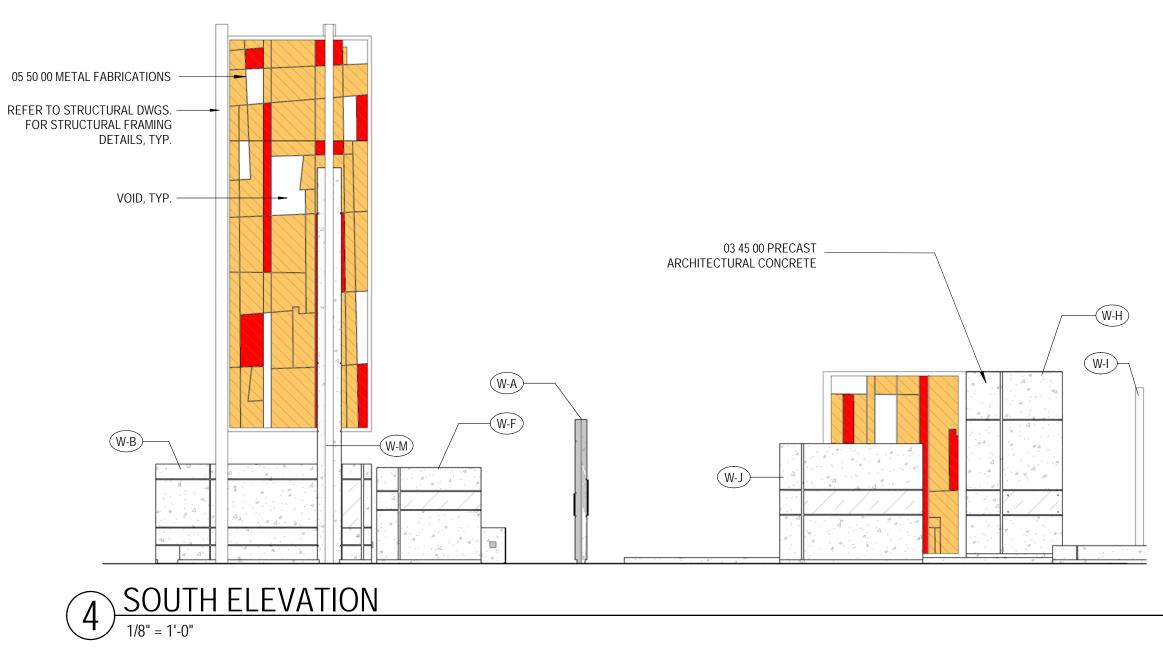

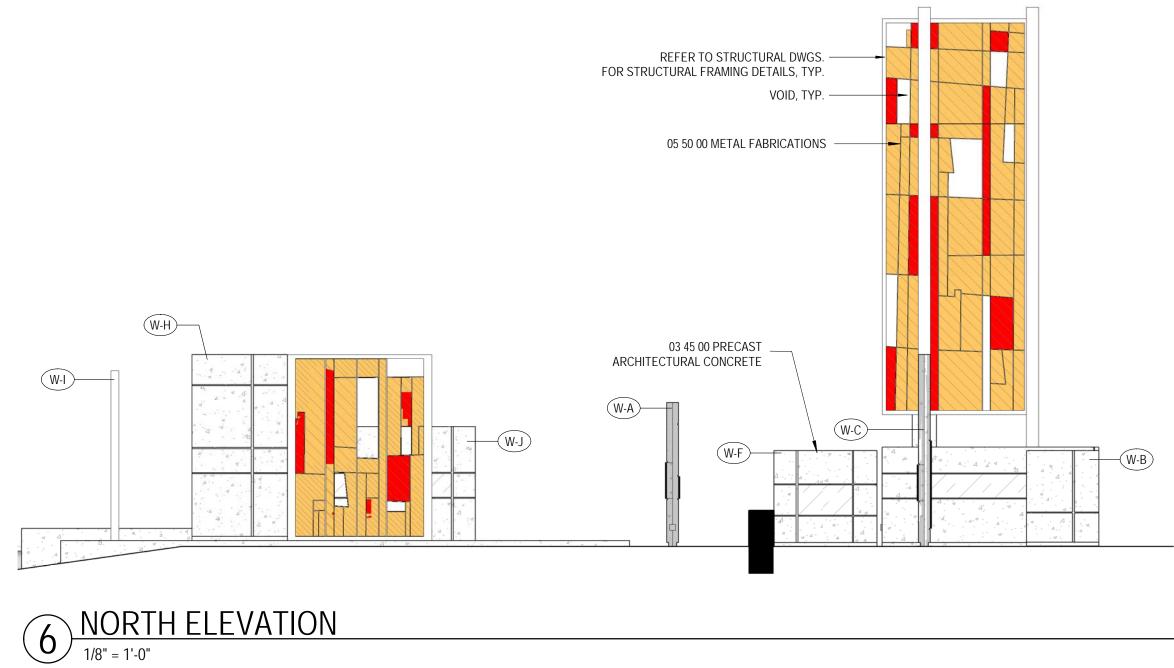

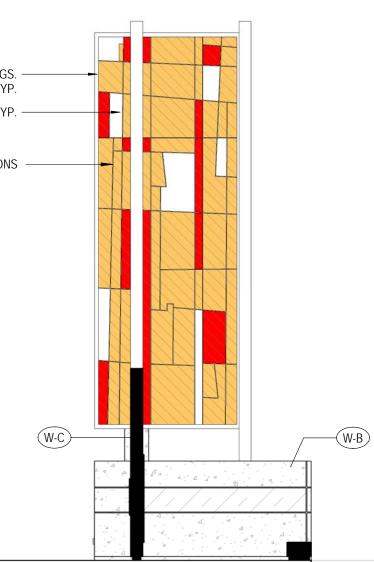



## GREENVILLE TOWN COMMON SYCAMORE HILL

## **GATEWAY PLAZA** 90% DESIGN SUBMISSION


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OWNER:



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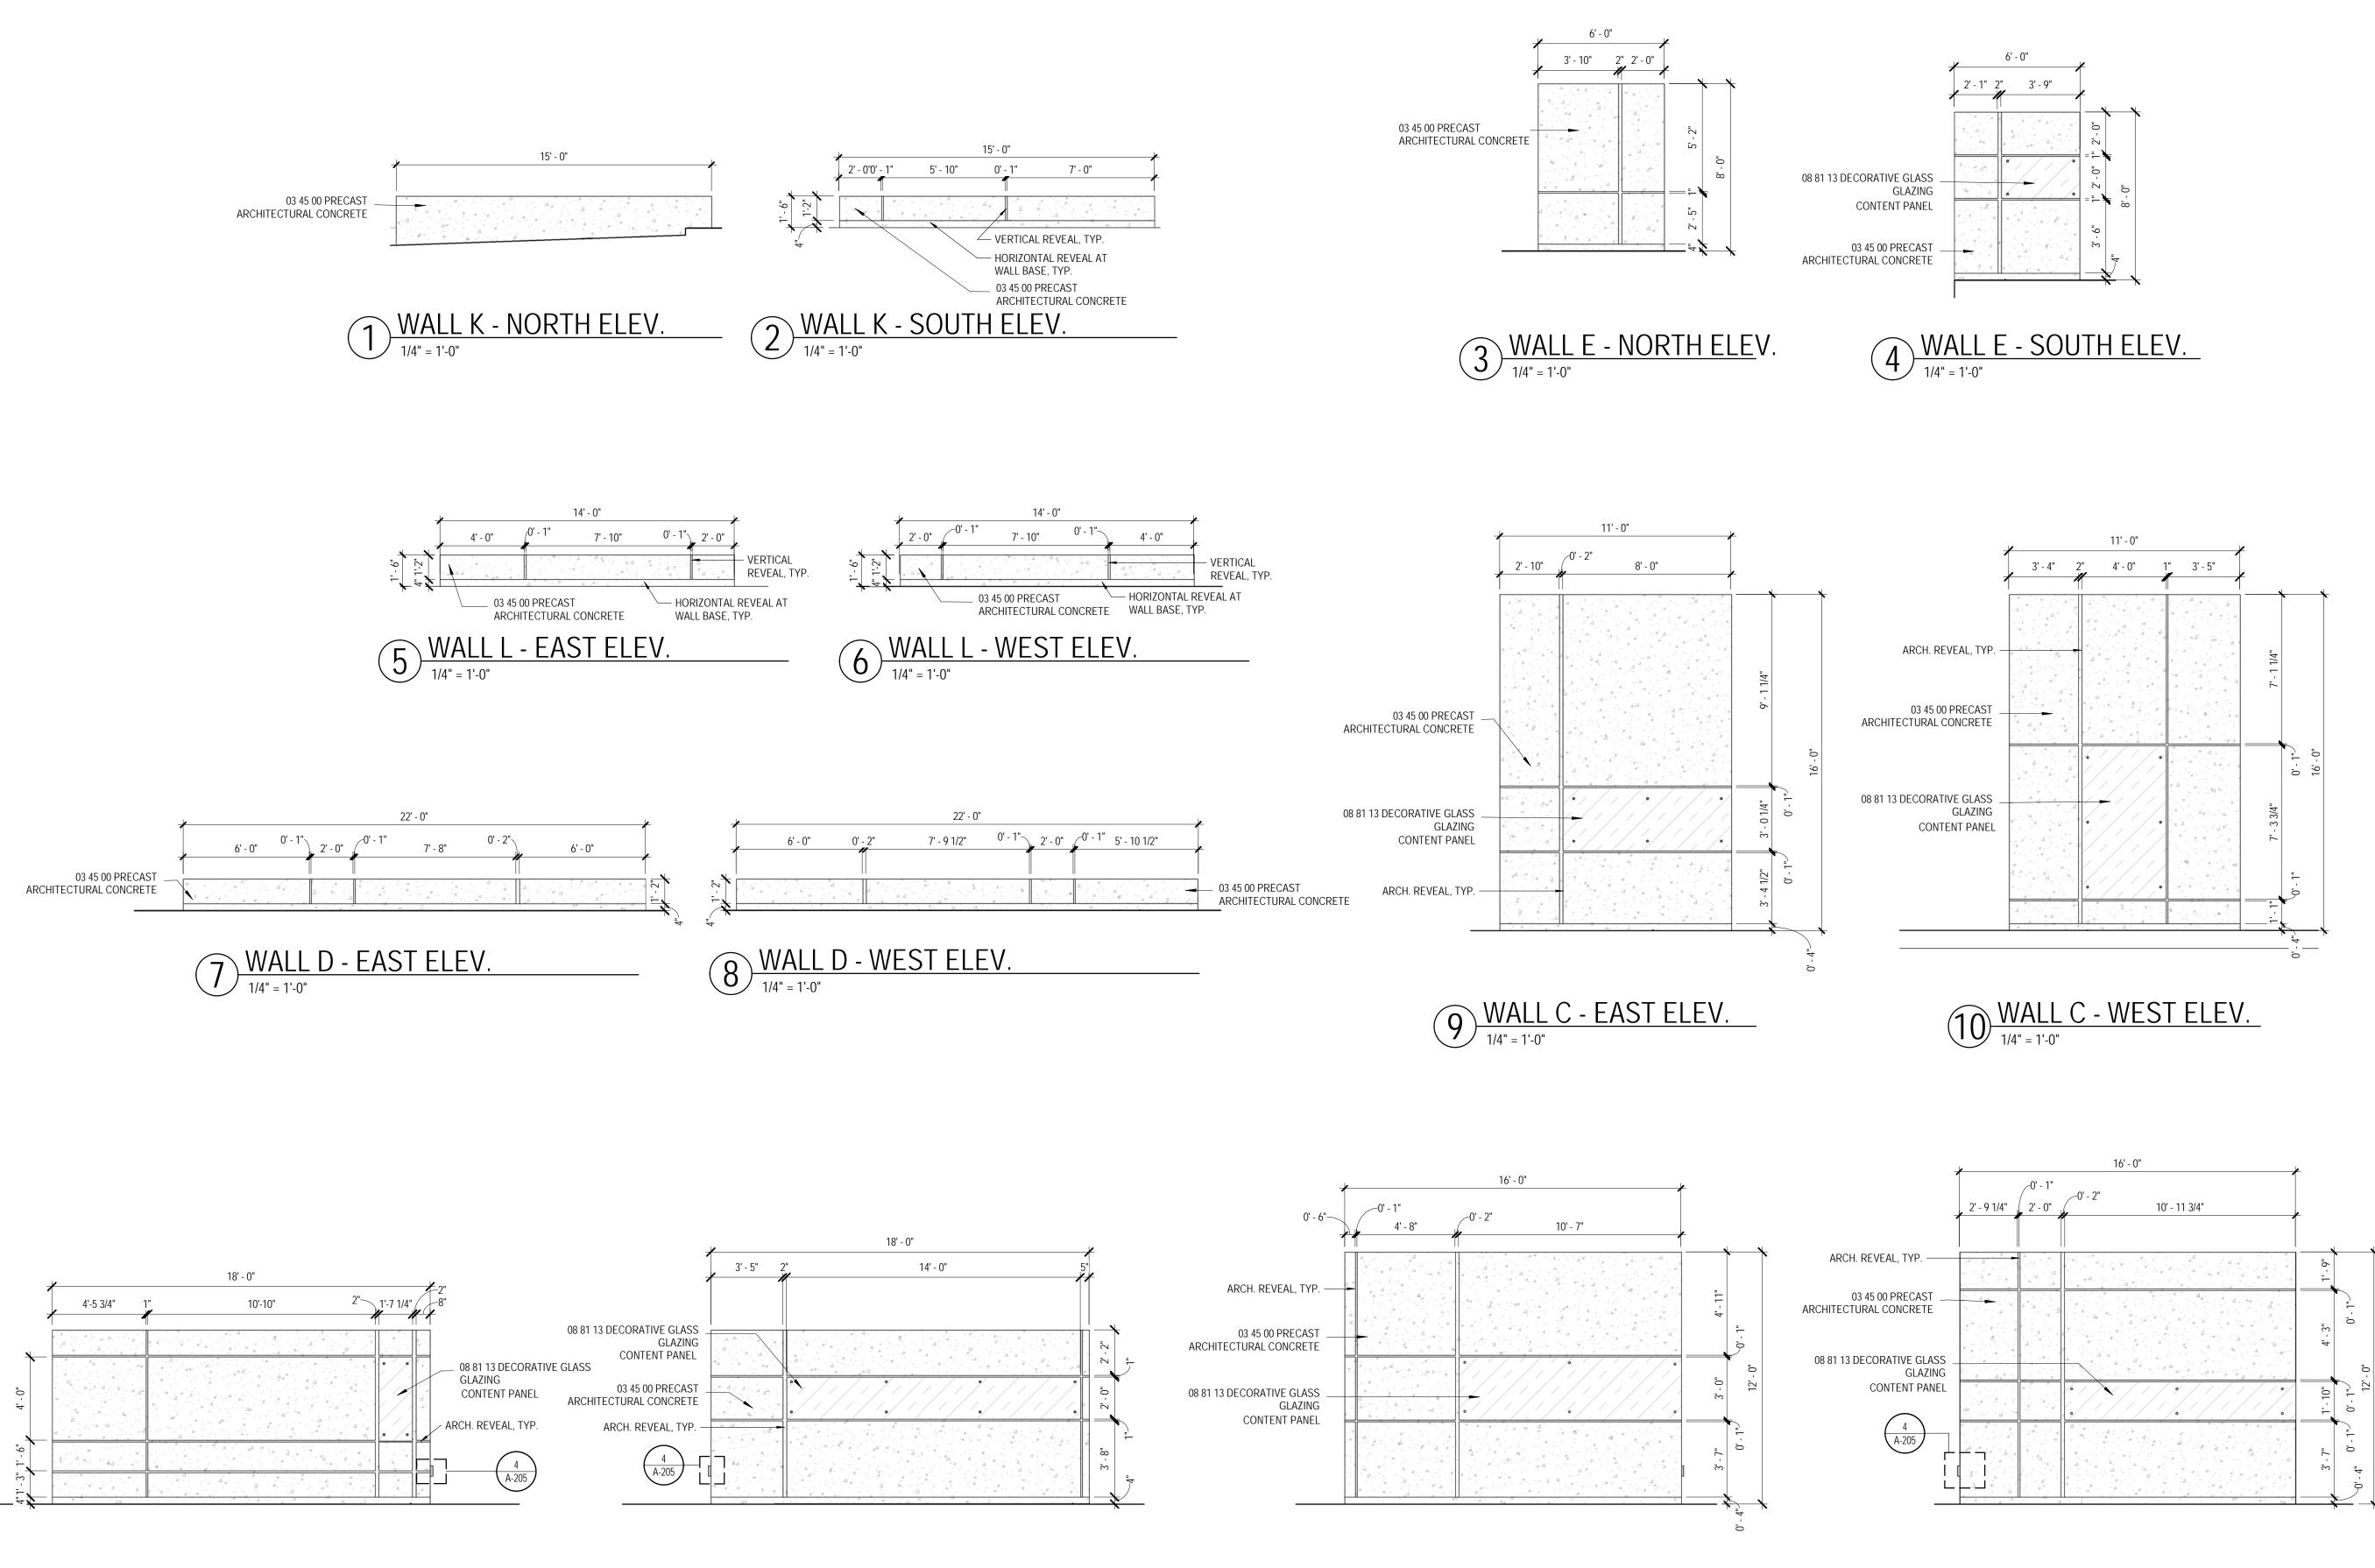
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### THE EAST GROUP **GALLAGHER & ASSOCIATES BREE & ASSOCIATES** LIGHT DEFINES FORMS INC **ENGINEERING SOURCE**

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REVISION:	
SCALE:	1/8" = 1'-0"
SHEET NAME:	
	SITE ELEVATIONS
SHEET NUMBER:	
	<b>A-200</b>

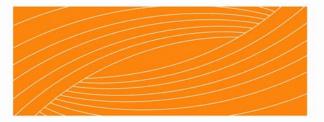

 $\underbrace{11}_{1/4" = 1'-0"} WALL B - SOUTH ELEV.$ 

12 WALL B - NORTH ELEV.

(13) WALL A - EAST ELEV. 1/4" = 1'-0"



## GREENVILLE TOWN COMMON SYCAMORE HILL

# **GATEWAY PLAZA**

### 90% DESIGN SUBMISSION


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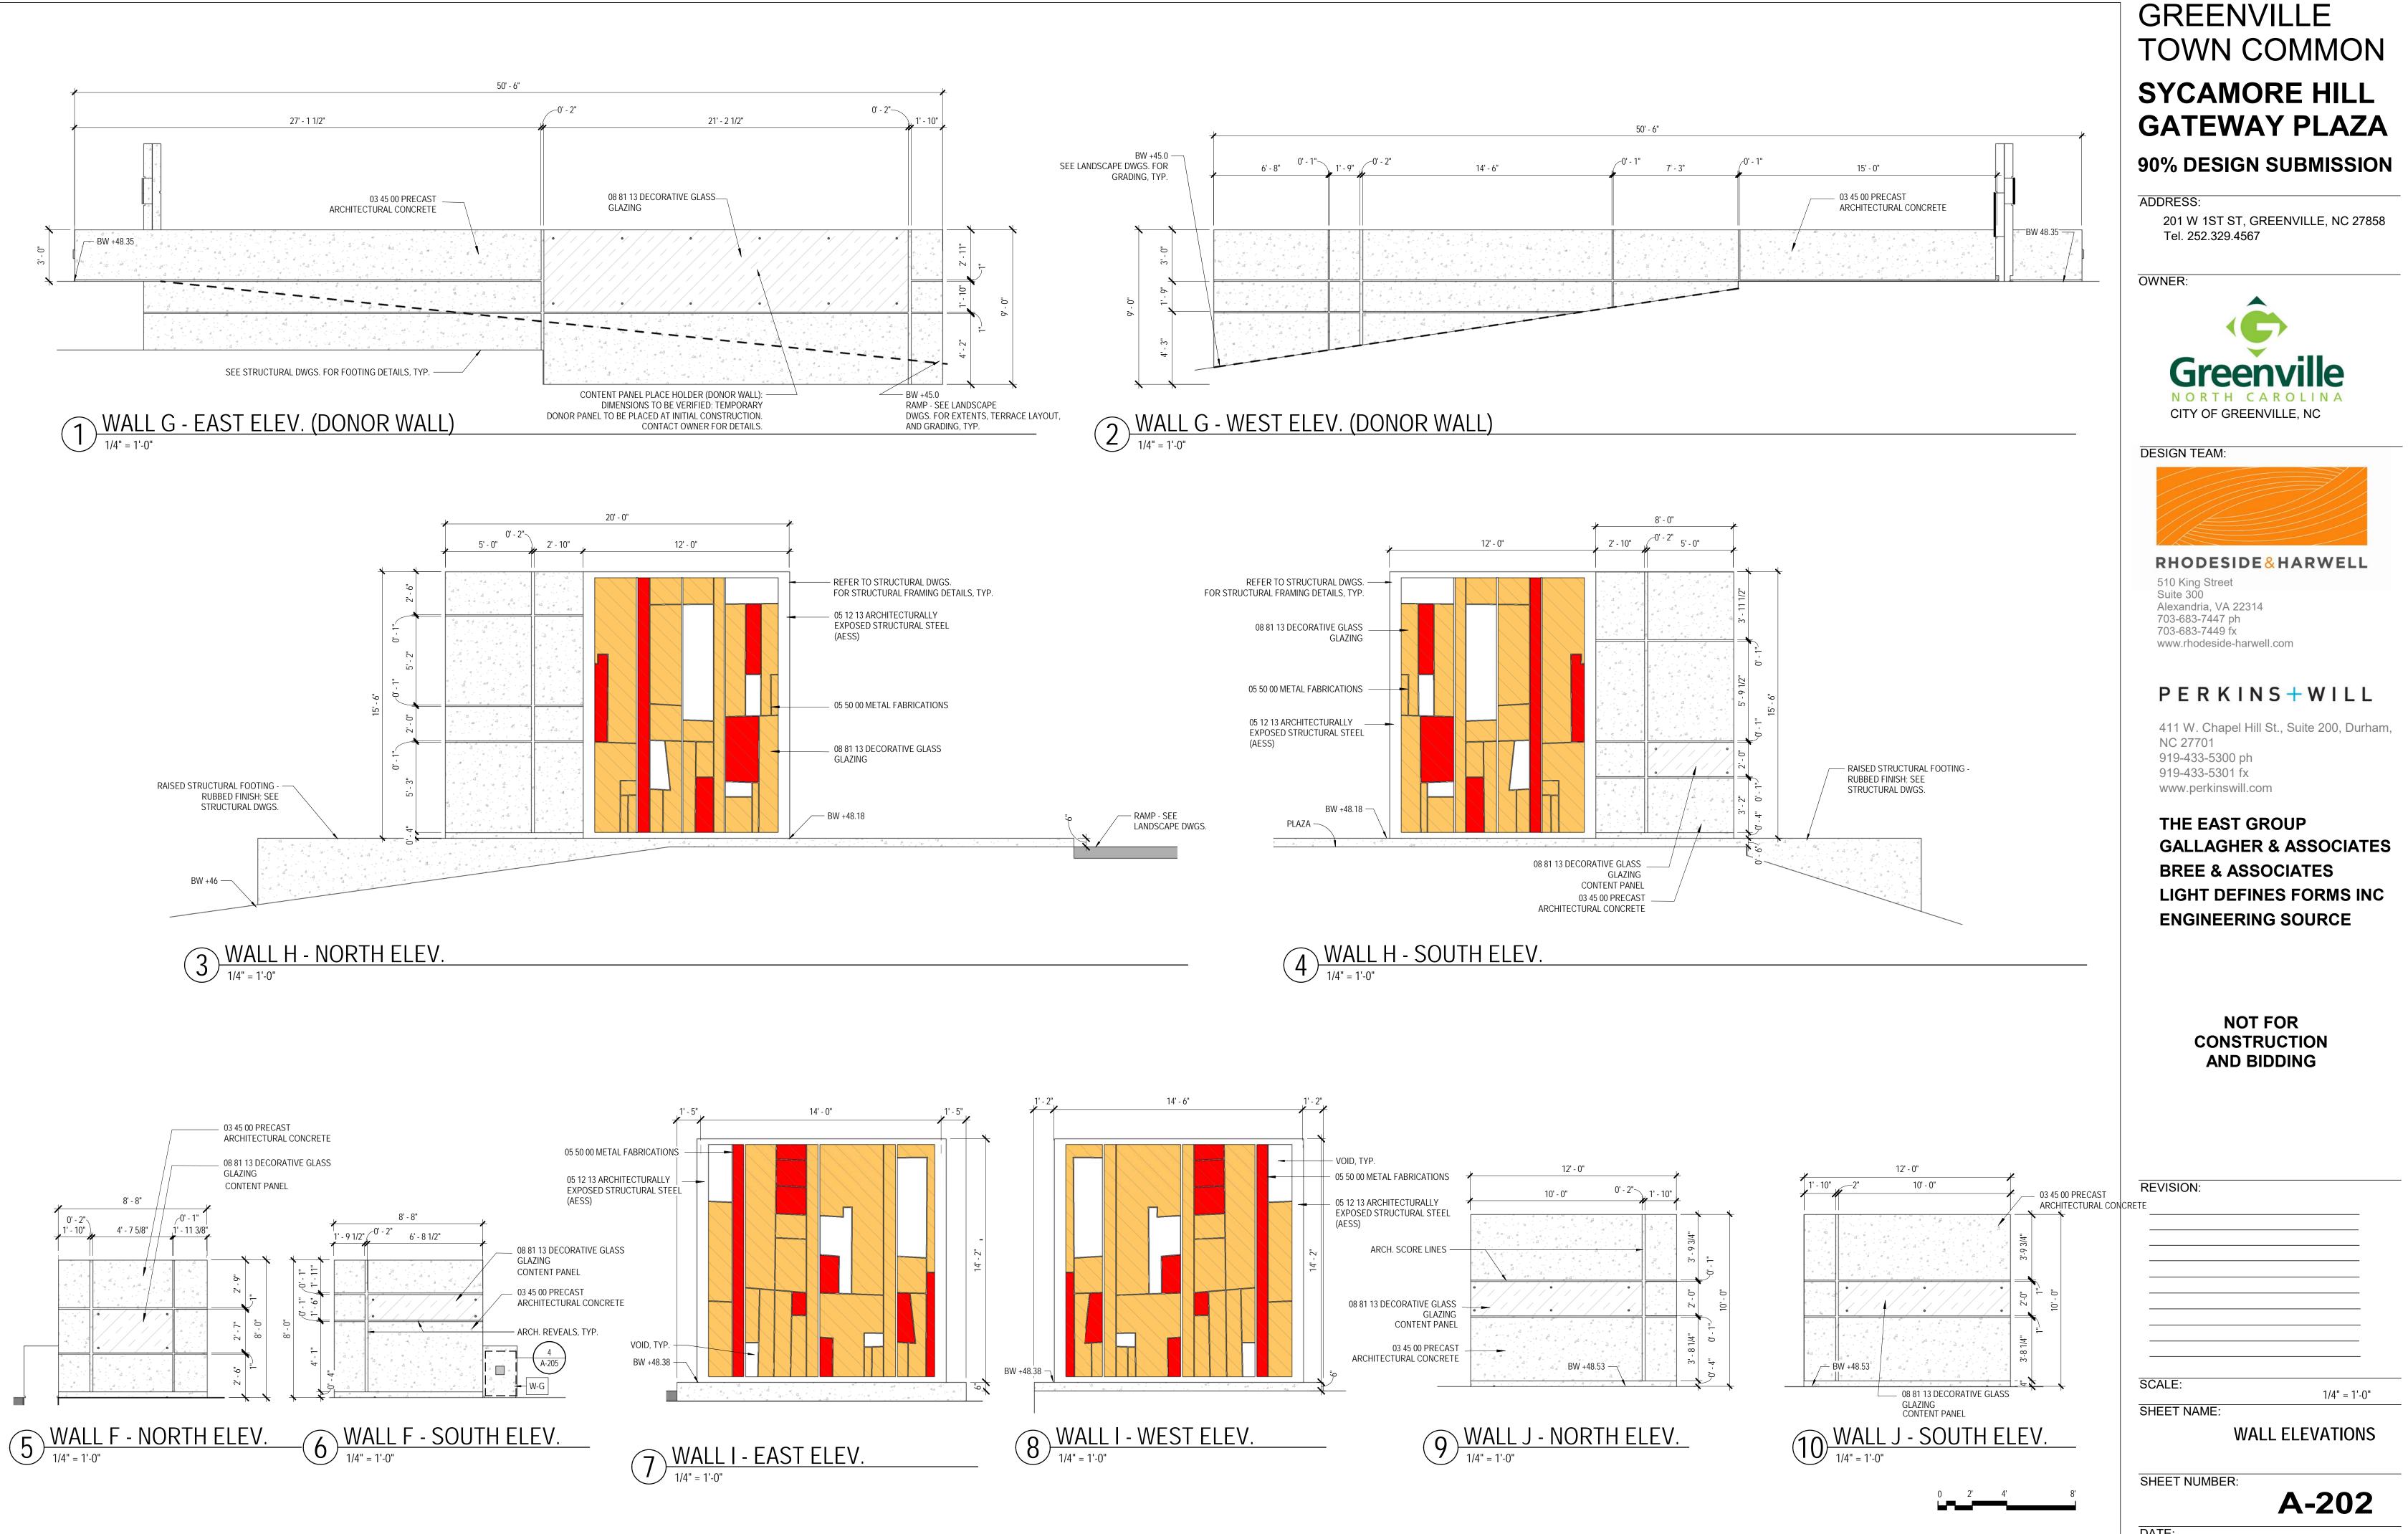
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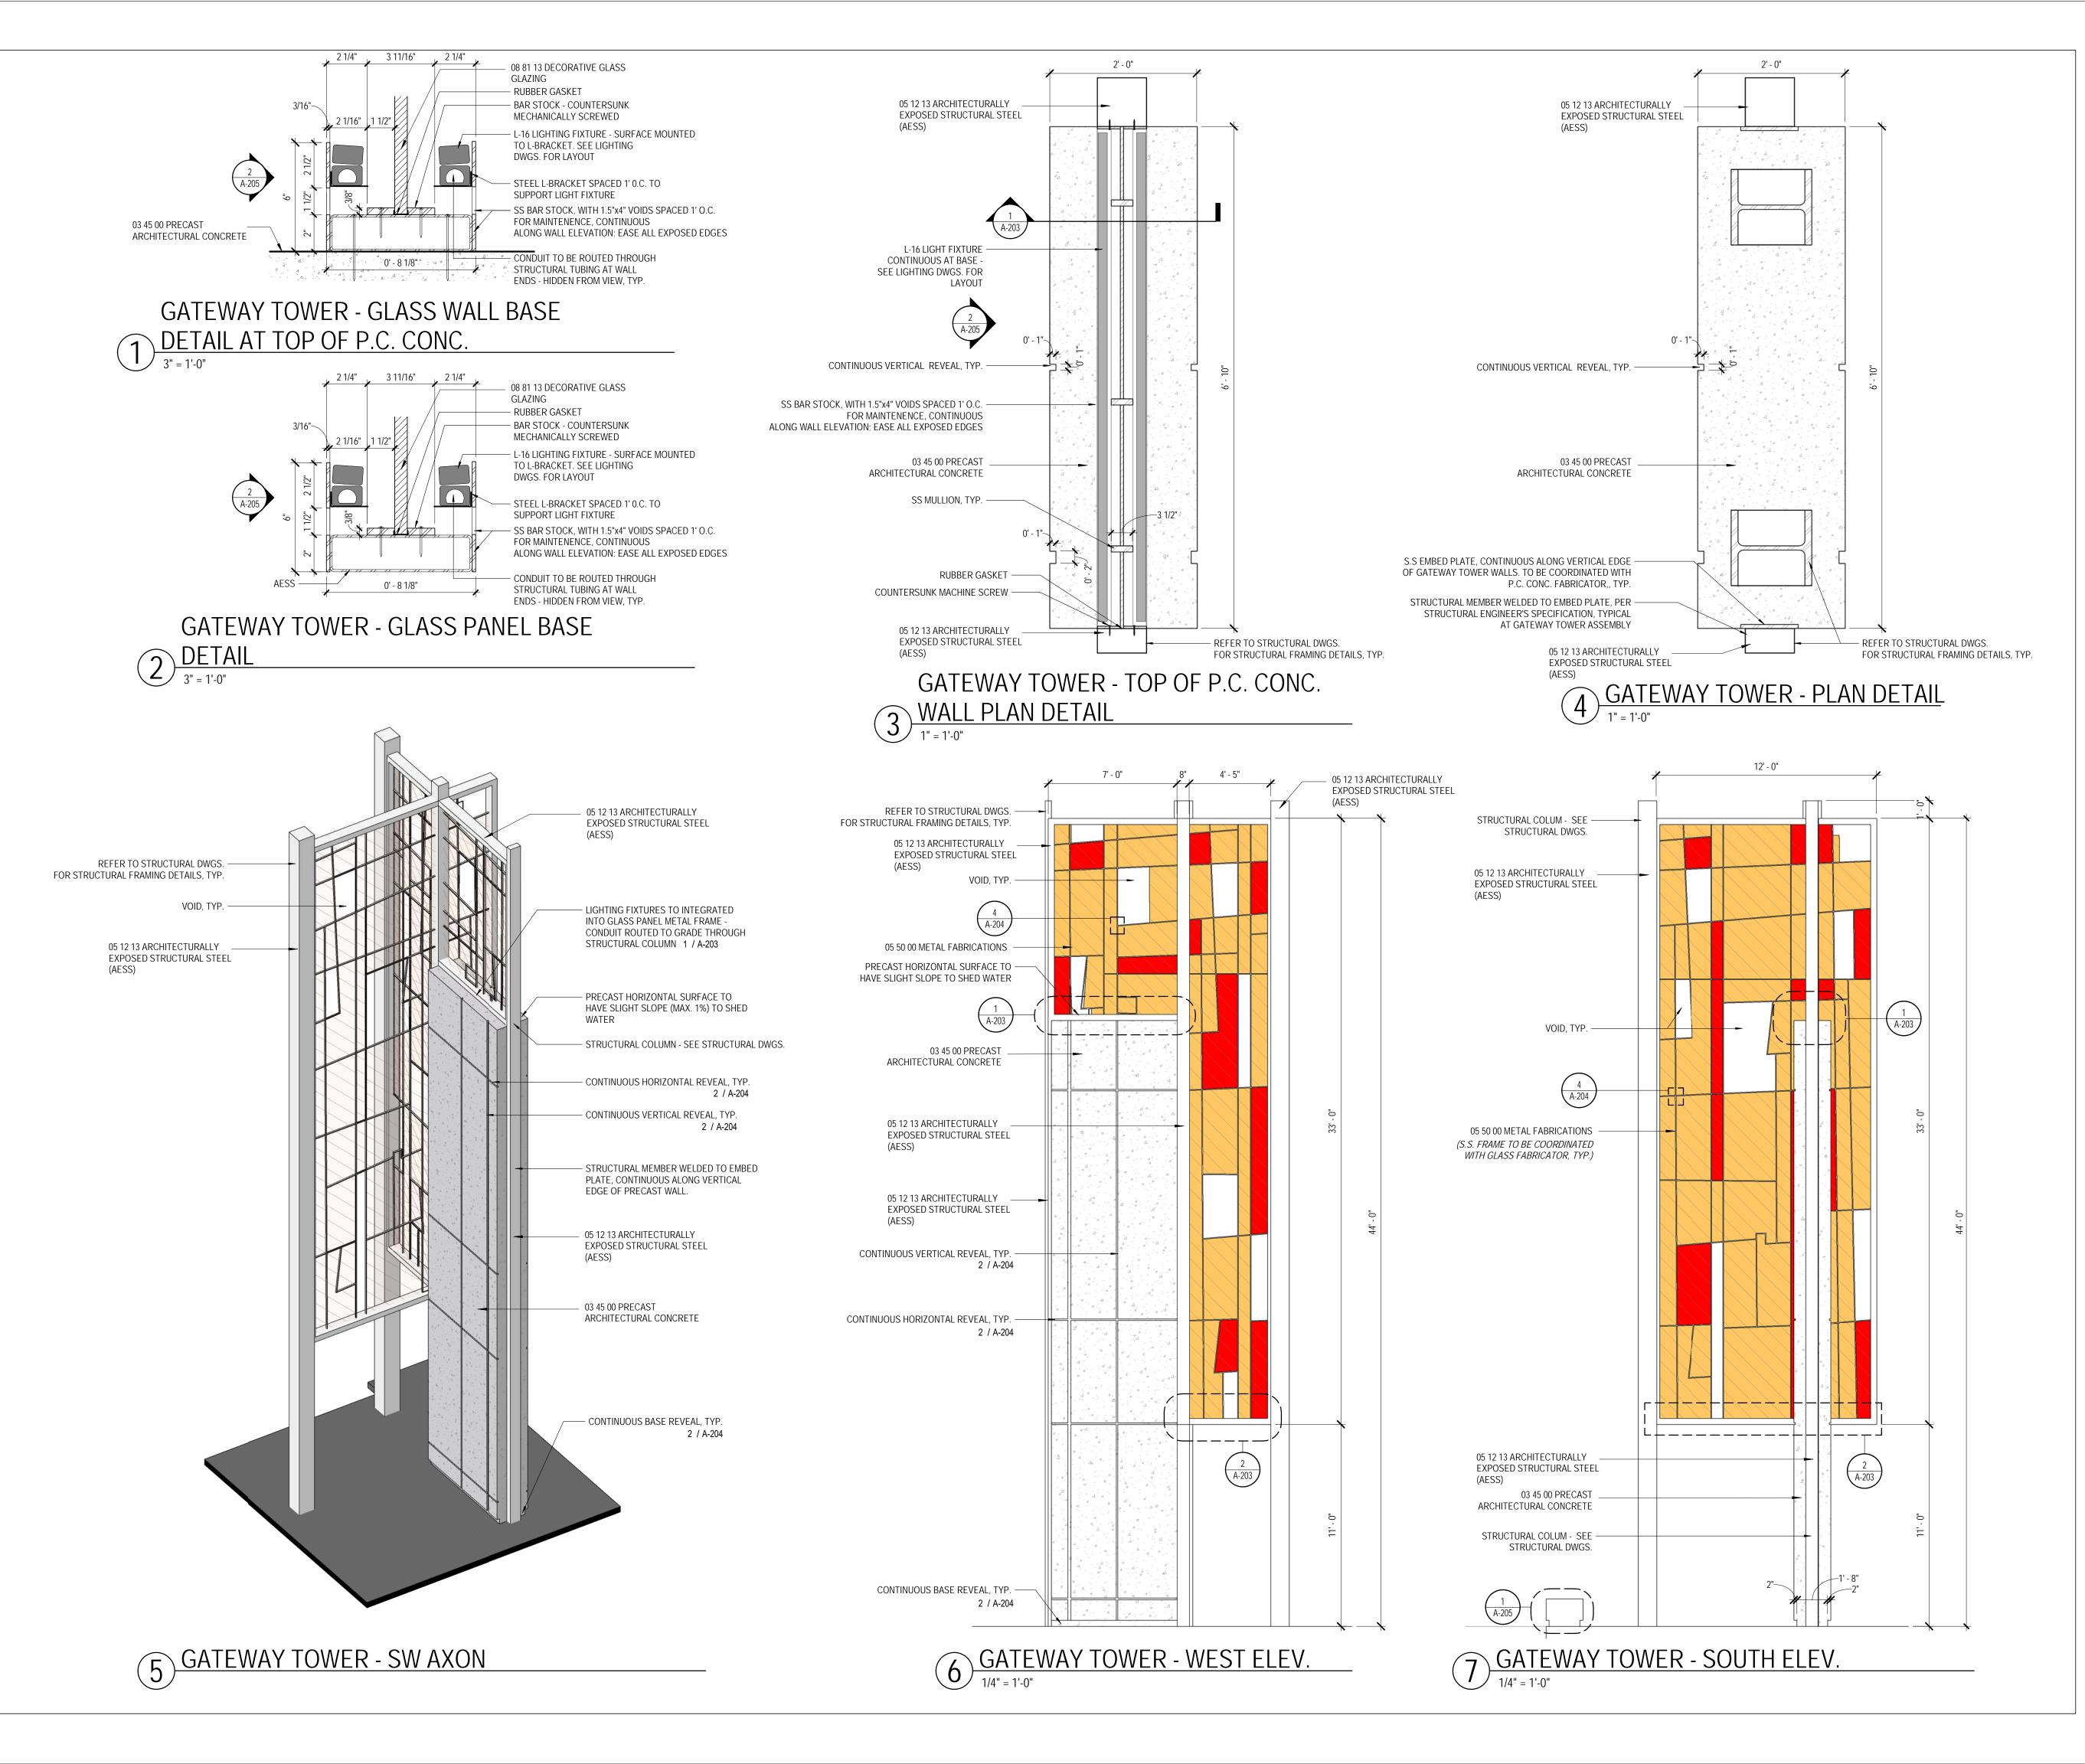
### NOT FOR CONSTRUCTION AND BIDDING

REVISION:		
		-
		-
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		-
		-
		-
SCALE:	1/4" = 7	1'-0"
SHEET NAME:		
	WALL ELEVATION	VS
SHEET NUMBE	R:	-
	<b>A-20</b> <sup>-</sup>	1

DATE:



DATE:

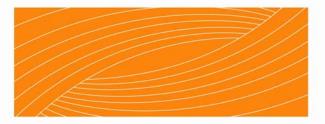

## GREENVILLE TOWN COMMON SYCAMORE HILL

# GATEWAY PLAZA

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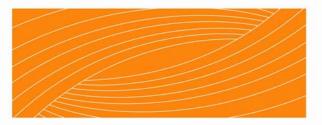
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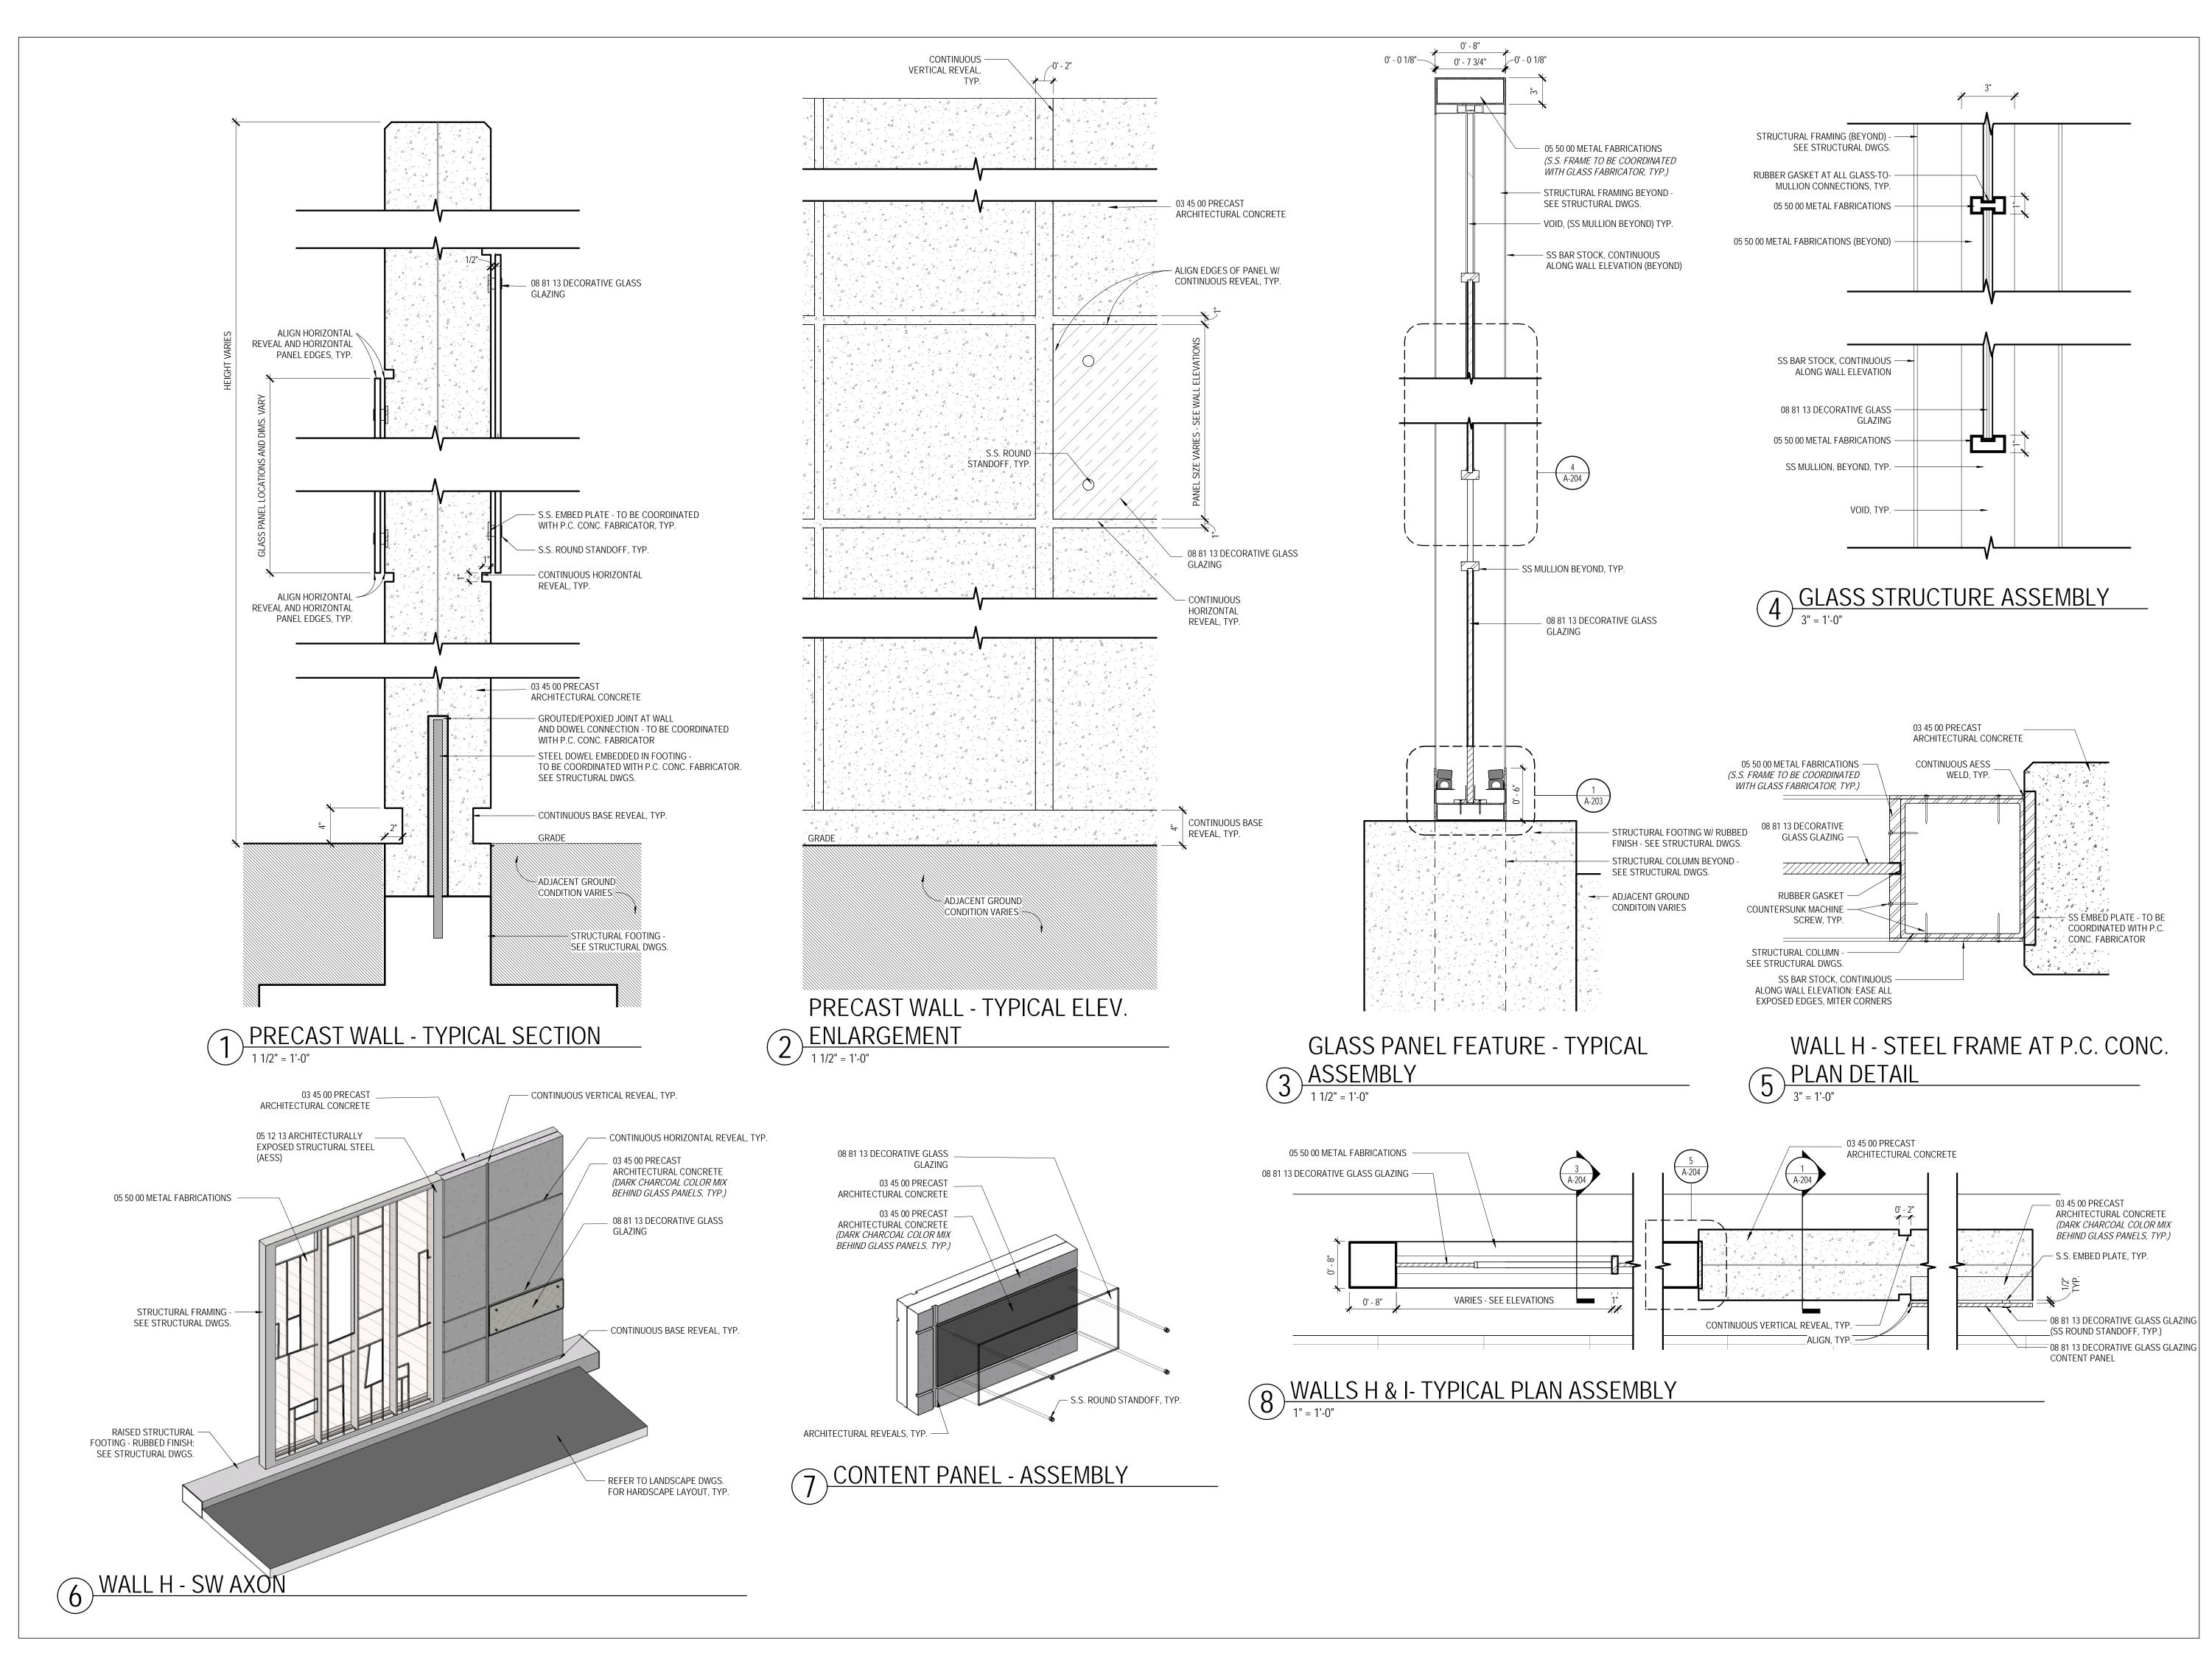
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<b>REVISION</b> :	
SCALE:	
SHEET NAME:	
	GATEWAY TOWER
	DETAILS
SHEET NUMBER	:
	<b>A-203</b>



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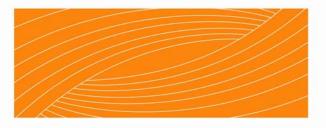
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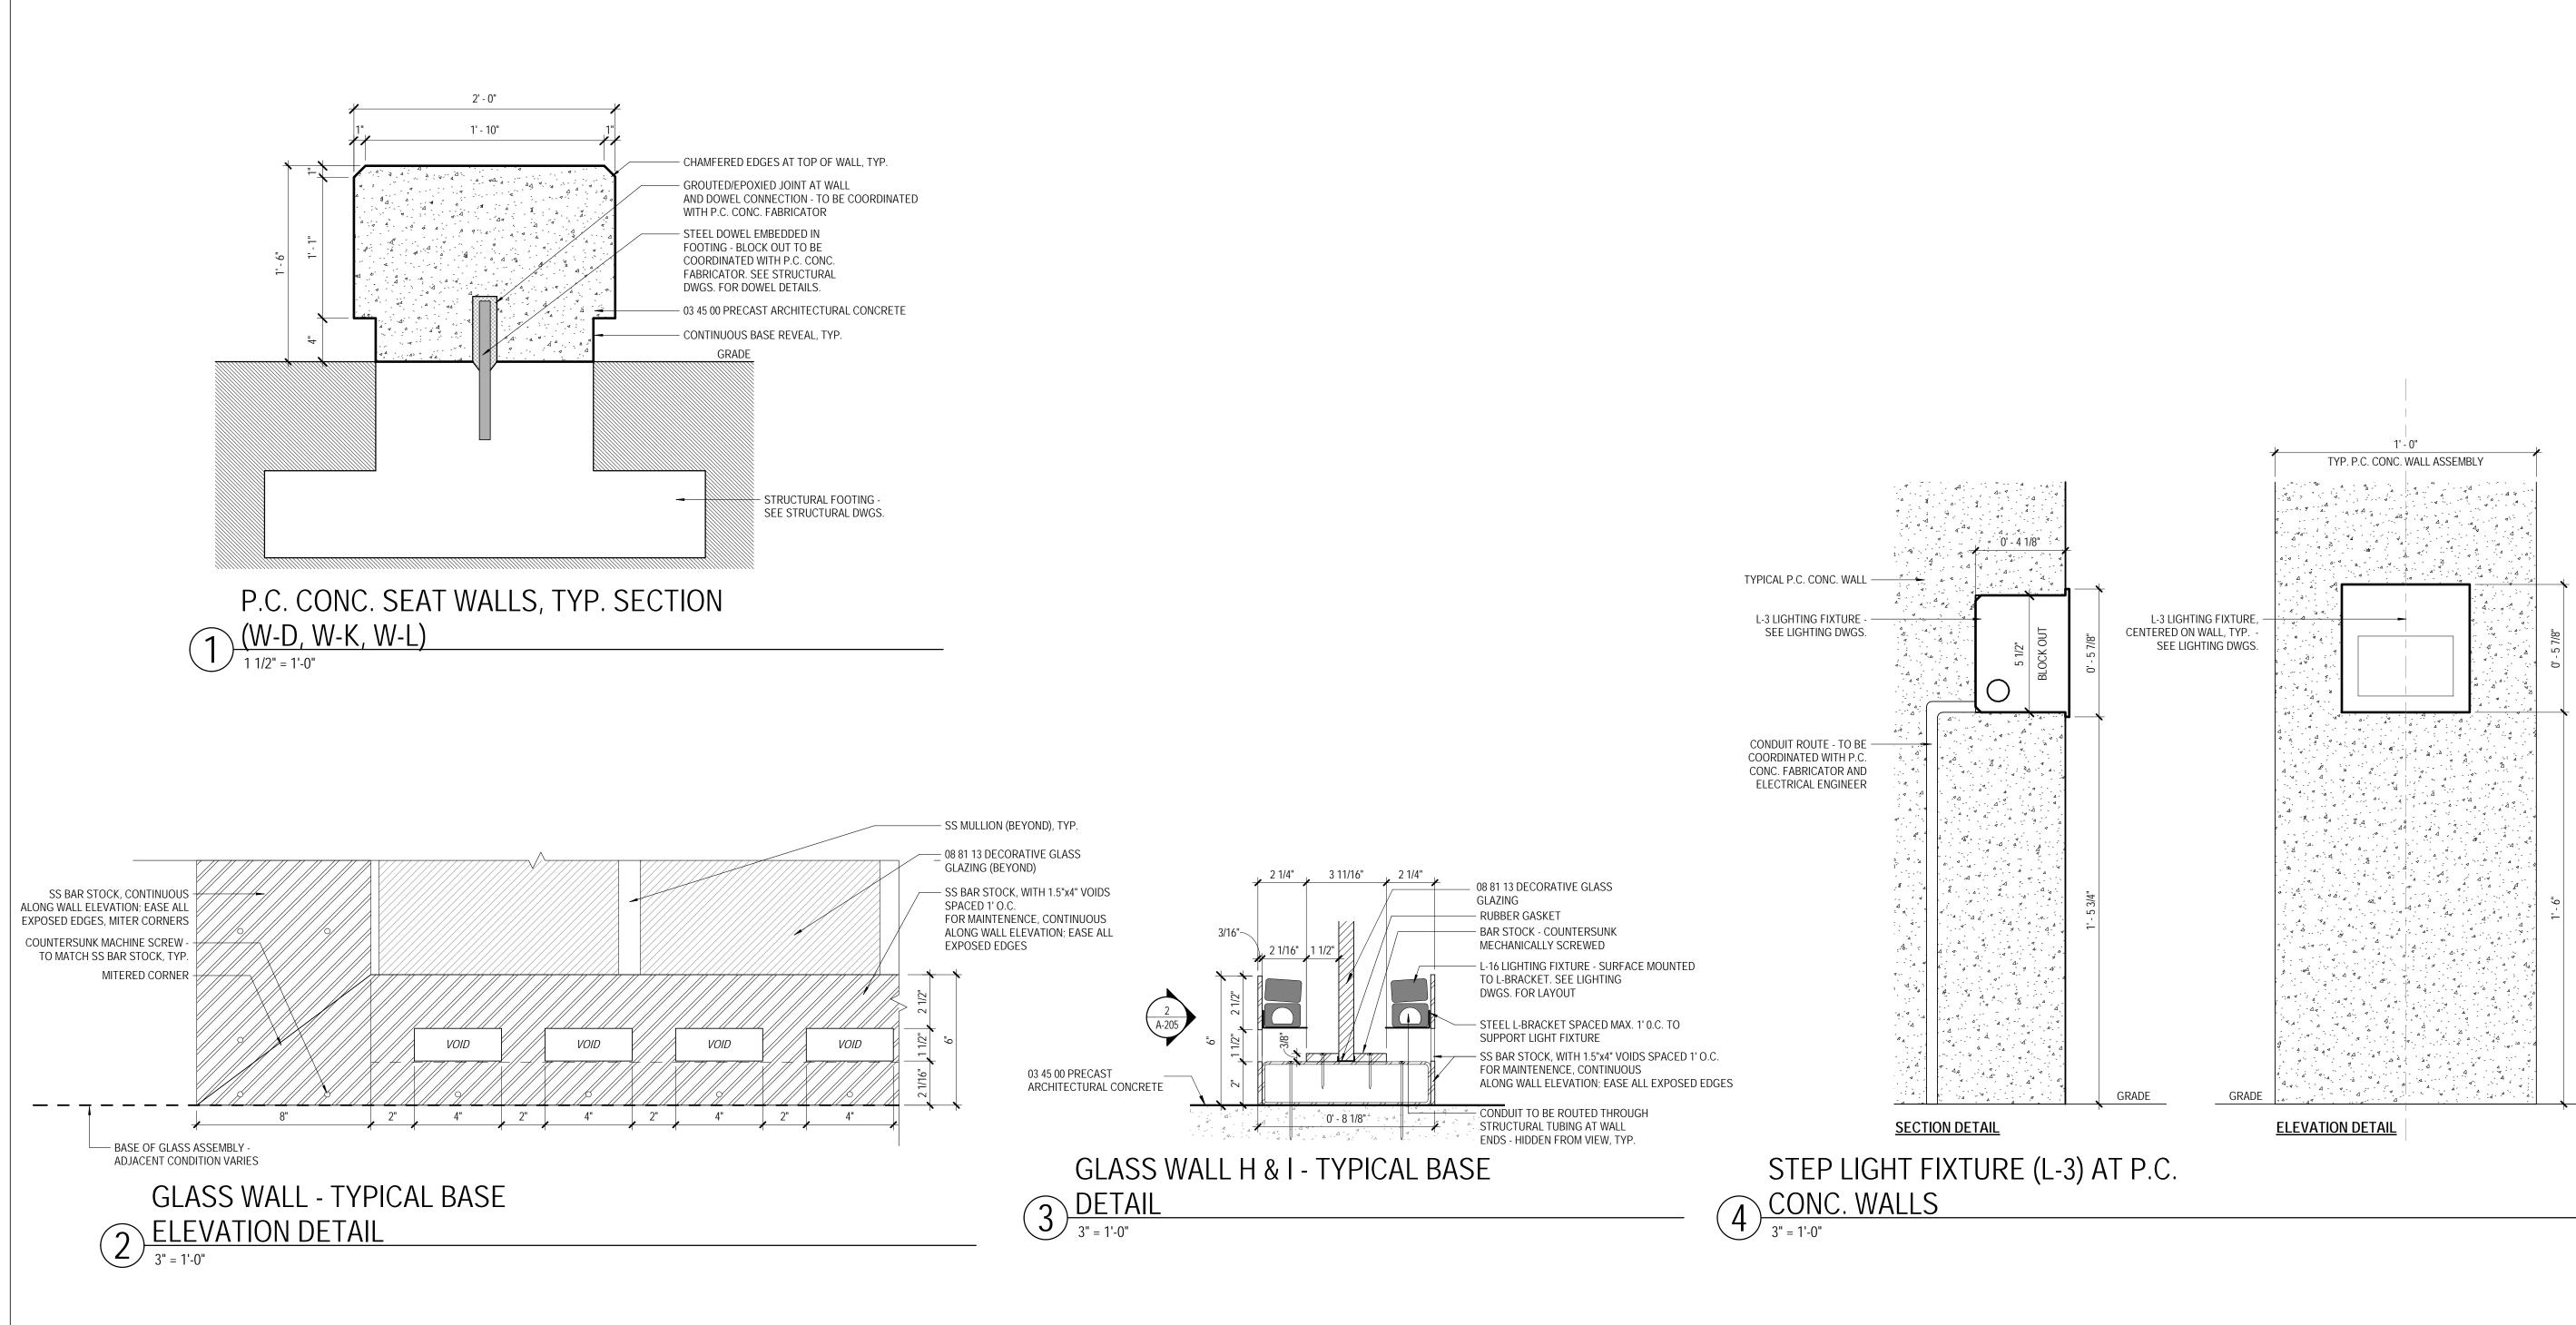
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### THE EAST GROUP GALLAGHER & ASSOCIATES BREE & ASSOCIATES LIGHT DEFINES FORMS INC ENGINEERING SOURCE

NOT FOR CONSTRUCTION AND BIDDING

<b>REVISION</b> :	
SCALE:	
SHEET NAME:	
OHEET NAME.	ARCHITECTURAL
	DETAILS
	DETAILS
SHEET NUMBER:	
	A-204



# GREENVILLE TOWN COMMON SYCAMORE HILL

# **GATEWAY PLAZA**

### 90% DESIGN SUBMISSION


#### ADDRESS:

201 W 1ST ST, GREENVILLE, NC 27858 Tel. 252.329.4567

OWNER:



#### DESIGN TEAM:

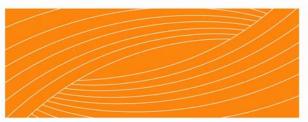

#### RHODESIDE & HARWELL 510 King Street Suite 300 Alexandria, VA 22314 703-683-7447 ph 703-683-7449 fx www.rhodeside-harwell.com


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REVISION:	
SCALE:	
SHEET NAME:	ARCHITECTURAL
	DETAILS
SHEET NUMBER:	A 205
	A-205



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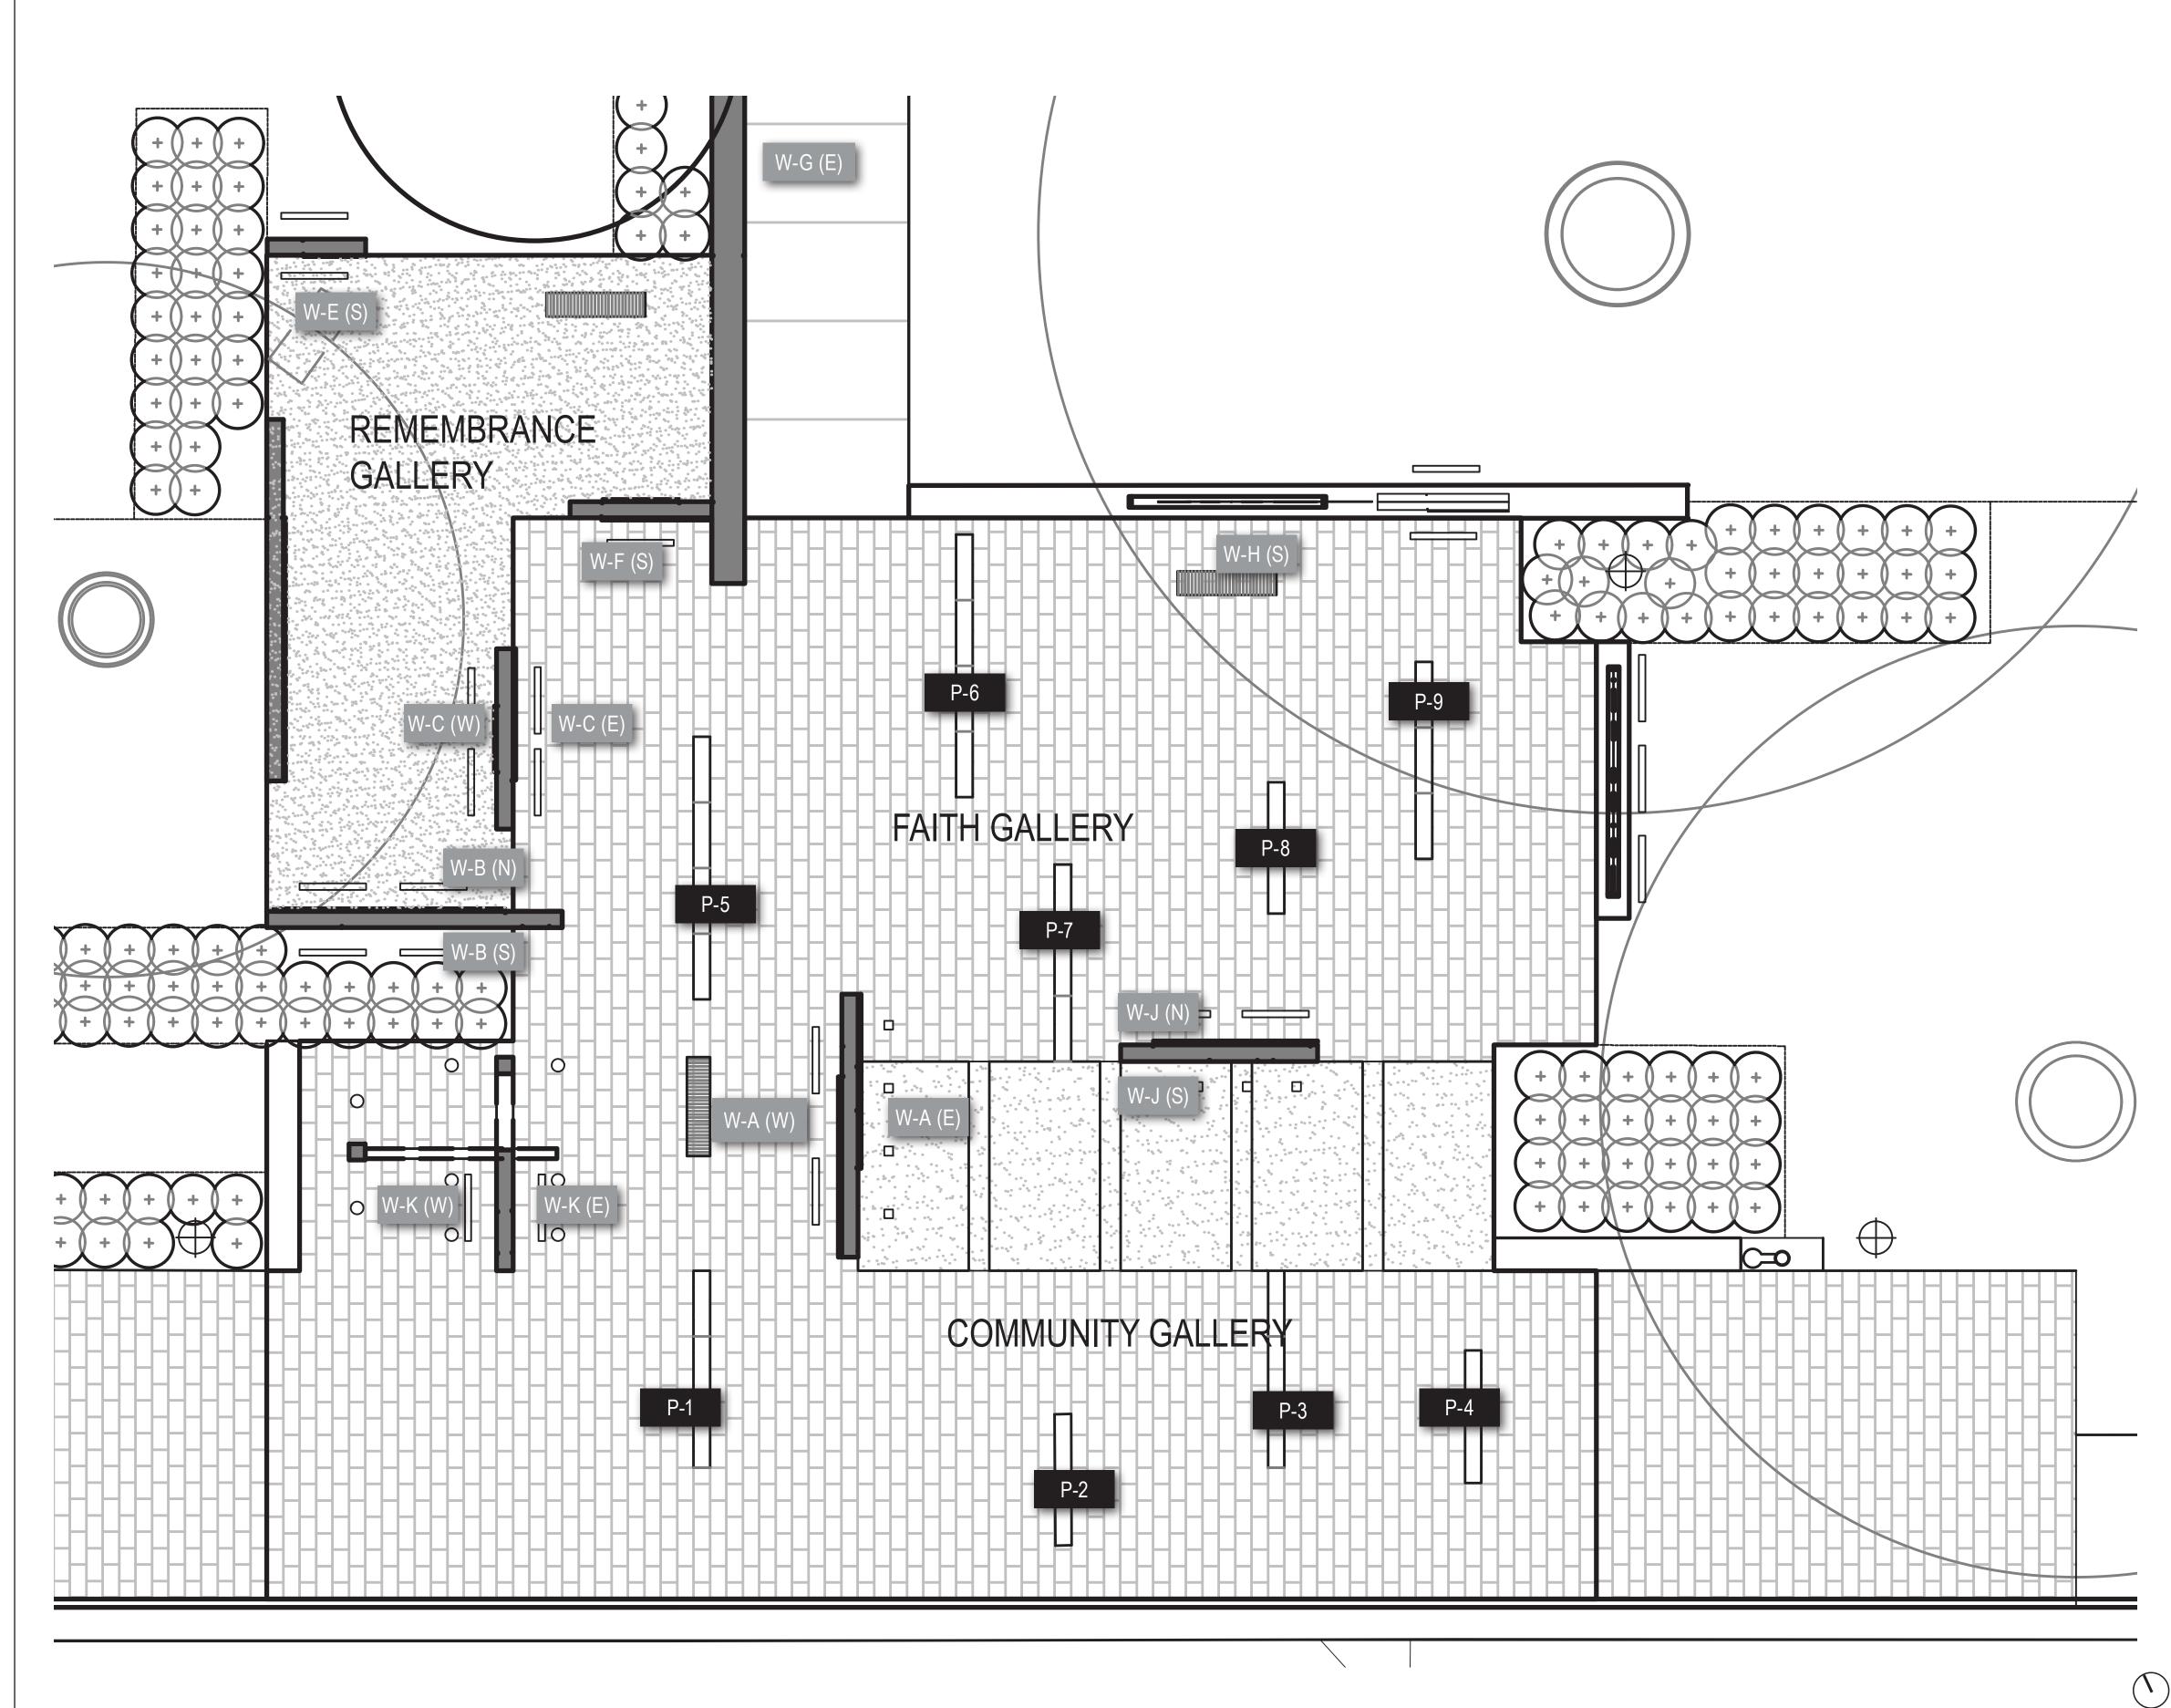
> NOT FOR CONSTRUCTION AND BIDDING

**REVISION:** SCALE: SHEET NAME: ILLUSTRATIVE AXON

SHEET NUMBER:

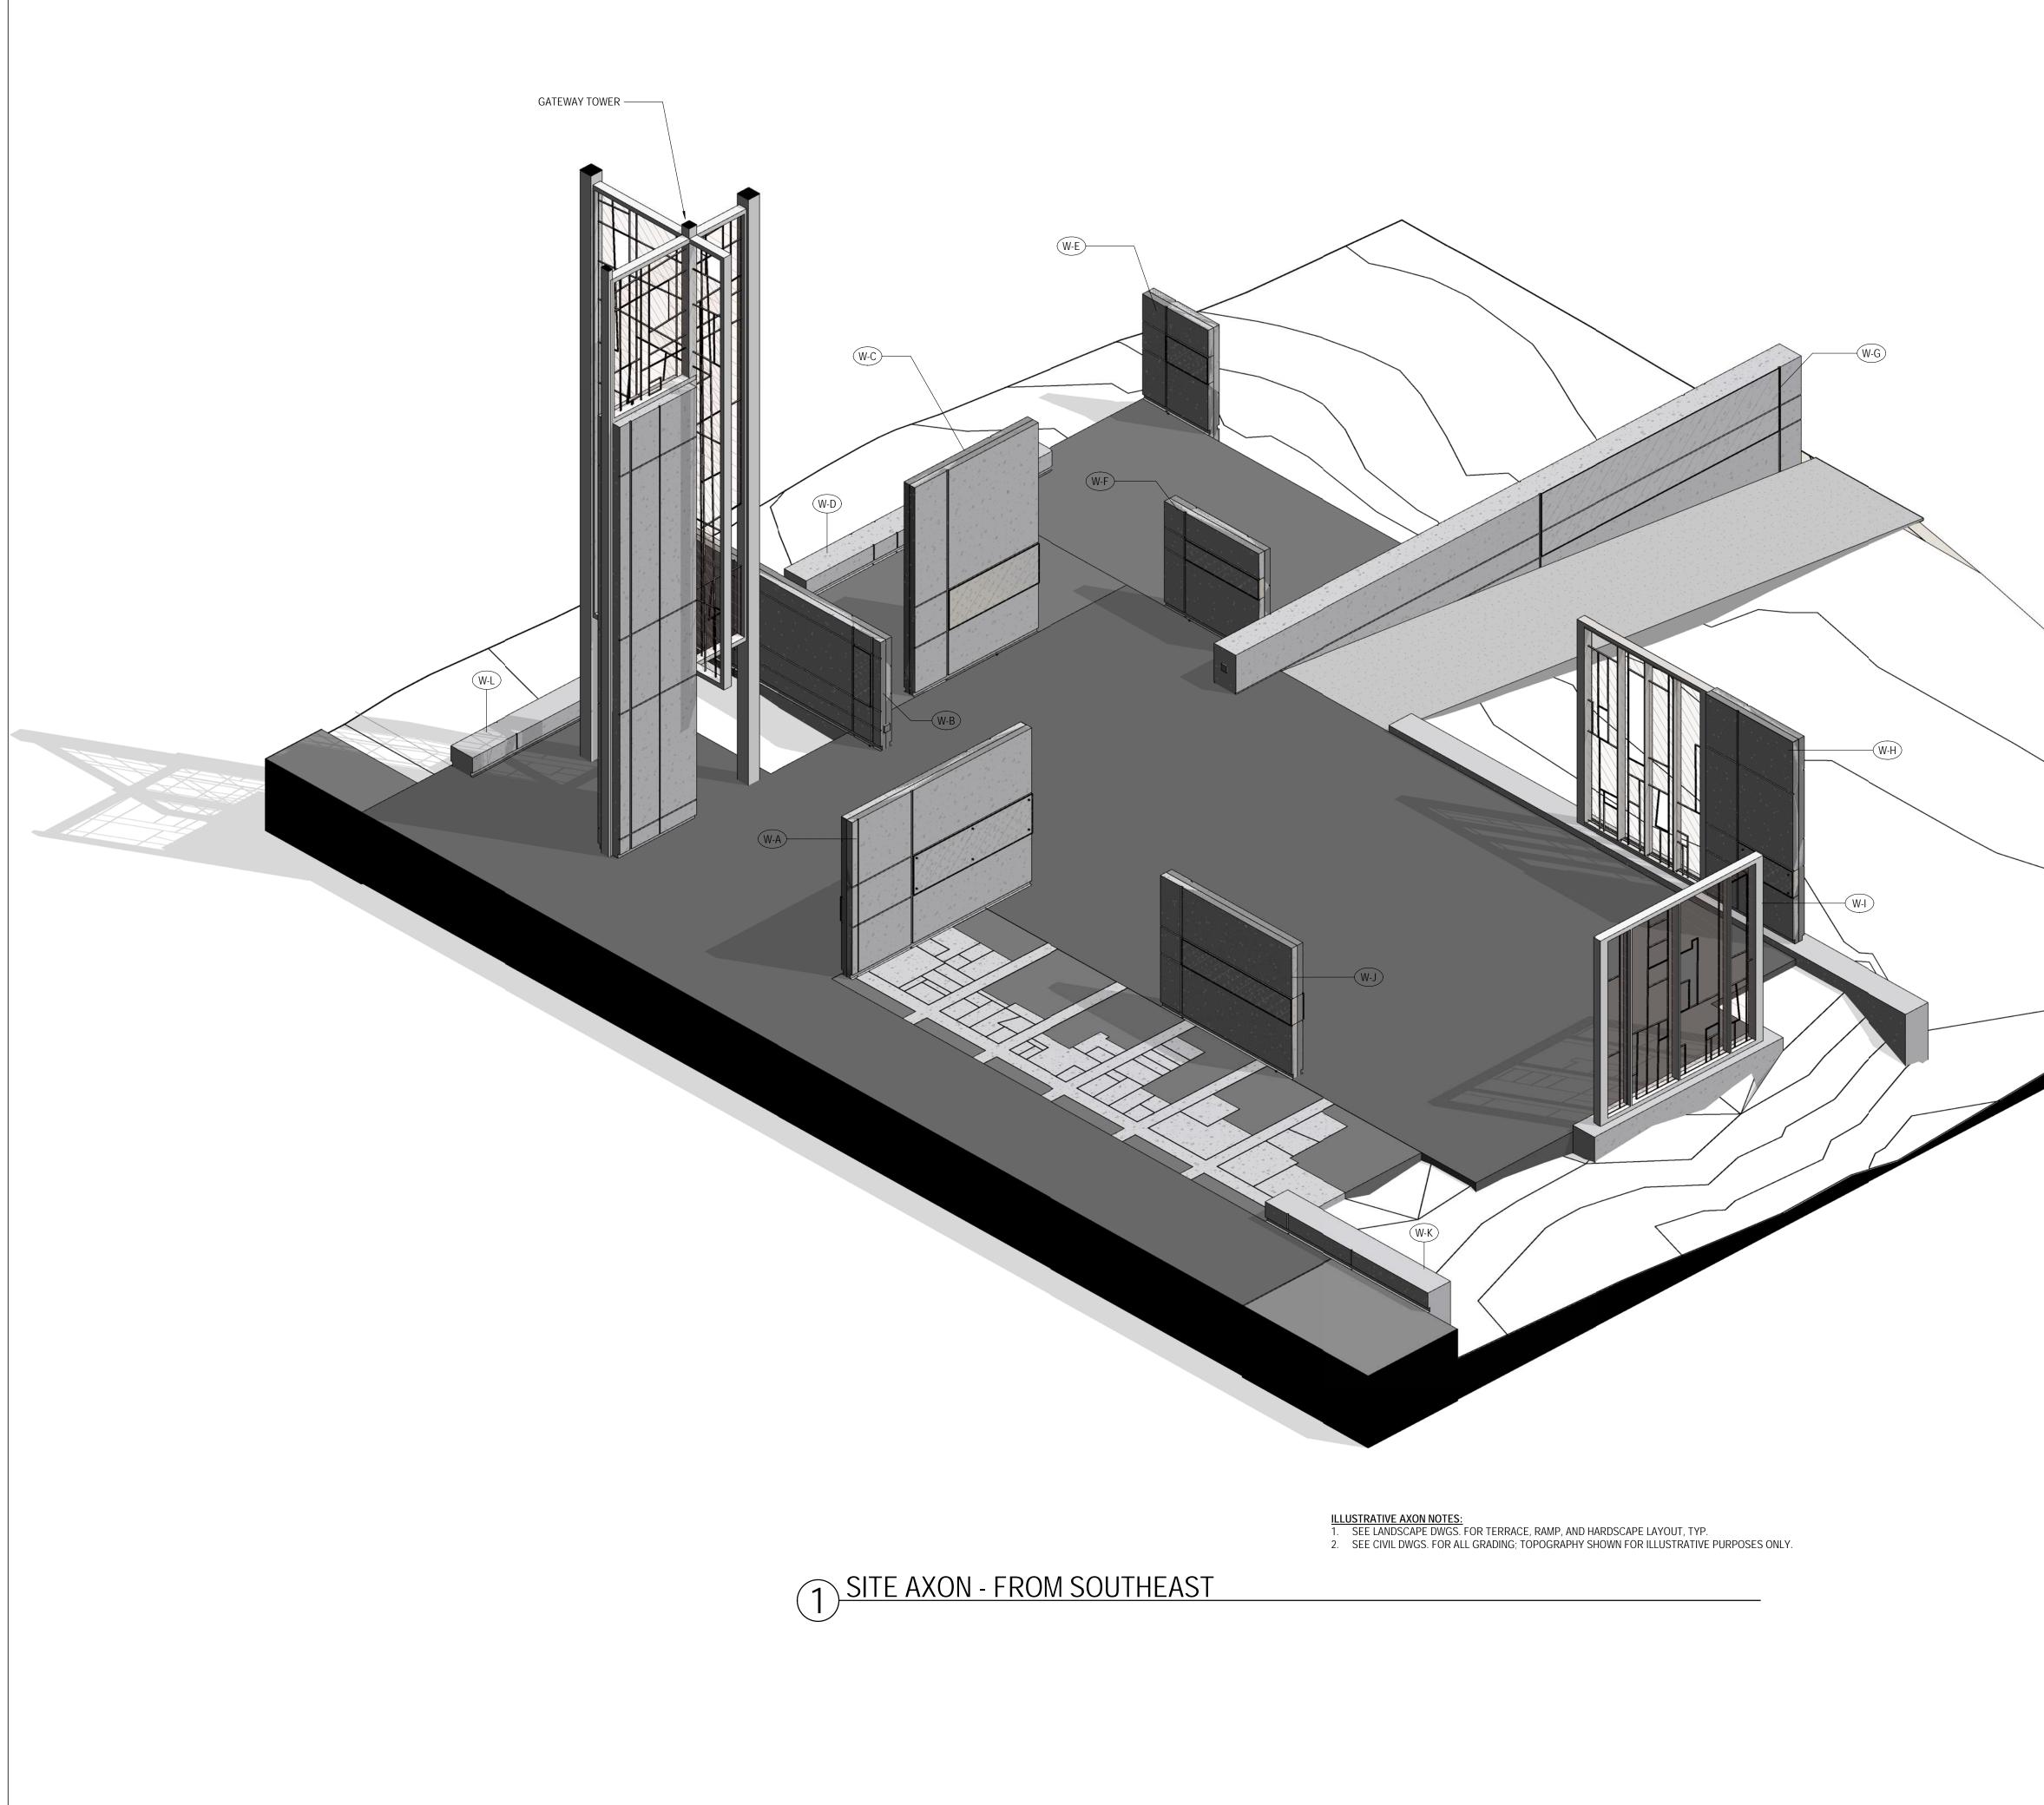

DATE:



1 KEY PLAN 3/16"=1'-0"

## **GRAPHIC TYPE KEY**

Α	=
	=

= Graphic on Laminated Glass в = Etched and infilled SS Graphic

#### CONTENT LEGEND

#### **COMMUNITY GALLERY**

w-н (s) = Main Text: United in Faith
W-J(N) = Image and Quote Panel
w-F (S) = Image and Quote Panel (Congregation)
P-5 = Paver Key Words
P-6 = Paver Key Words
P-7 = Paver Key Words
P-8 = Paver Key Words
P-9 = Paver Key Words
REMEMBRANCE GALLERY
w-c (E) = Main Text: Remembering a Church and a Congregation
w-c (w) = Subtext: Roots and Remembrance
w-в (N) = Subtext: Urban Displacement: A Neighborhood Lost
$W_{\rm e}E(S) = Ouote$

w-e (s) = Quote

w-g (E) = Donor Wall

10'

20'

# GREENVILLE TOWN COMMON SYCAMORE HILL **GATEWAY PLAZA**

90% DESIGN SUBMISSION


#### ADDRESS:

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CLIENT:



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#### THE EAST GROUP GALLAGHER & ASSOCIATES BREE & ASSOCIATES LIGHT DEFINES FORMS INC ENGINEERING SOURCE

#### NOT FOR CONSTRUCTION AND BIDDING

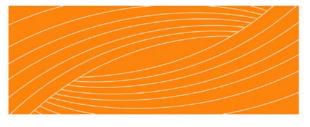**REVISION:** 

SCALE:

40'

AS NOTED

SHEET NAME: INTERPRETIVE SITE PLAN

#### SHEET NUMBER:



#### MATERIALS



EG.1: INSET STAINLESS STEEL LETTERFORMS IN GRANITE



EG.2 FORMS + SURFACES VIVIGRAPHIX SPECTRA LAMINATED GRAPHIC OR APPROVED EQUAL

#### TYPOGRAPHY


# ABCDEFGHIJKLMNOPQRSTUVWXYZ abcdefghijklmopqrstuvwxyz

1234567890 PRIMARY FONT ACUMIN PRO-CONDENSED MEDIUM

## ABCDEFGHIJKLMNOPQRSTUVWXYZ abcdefghijklmopqrstuvwxyz

#### 1234567890

PRIMARY FONT ADOBE CASLON SEMIBOLD ITALIC

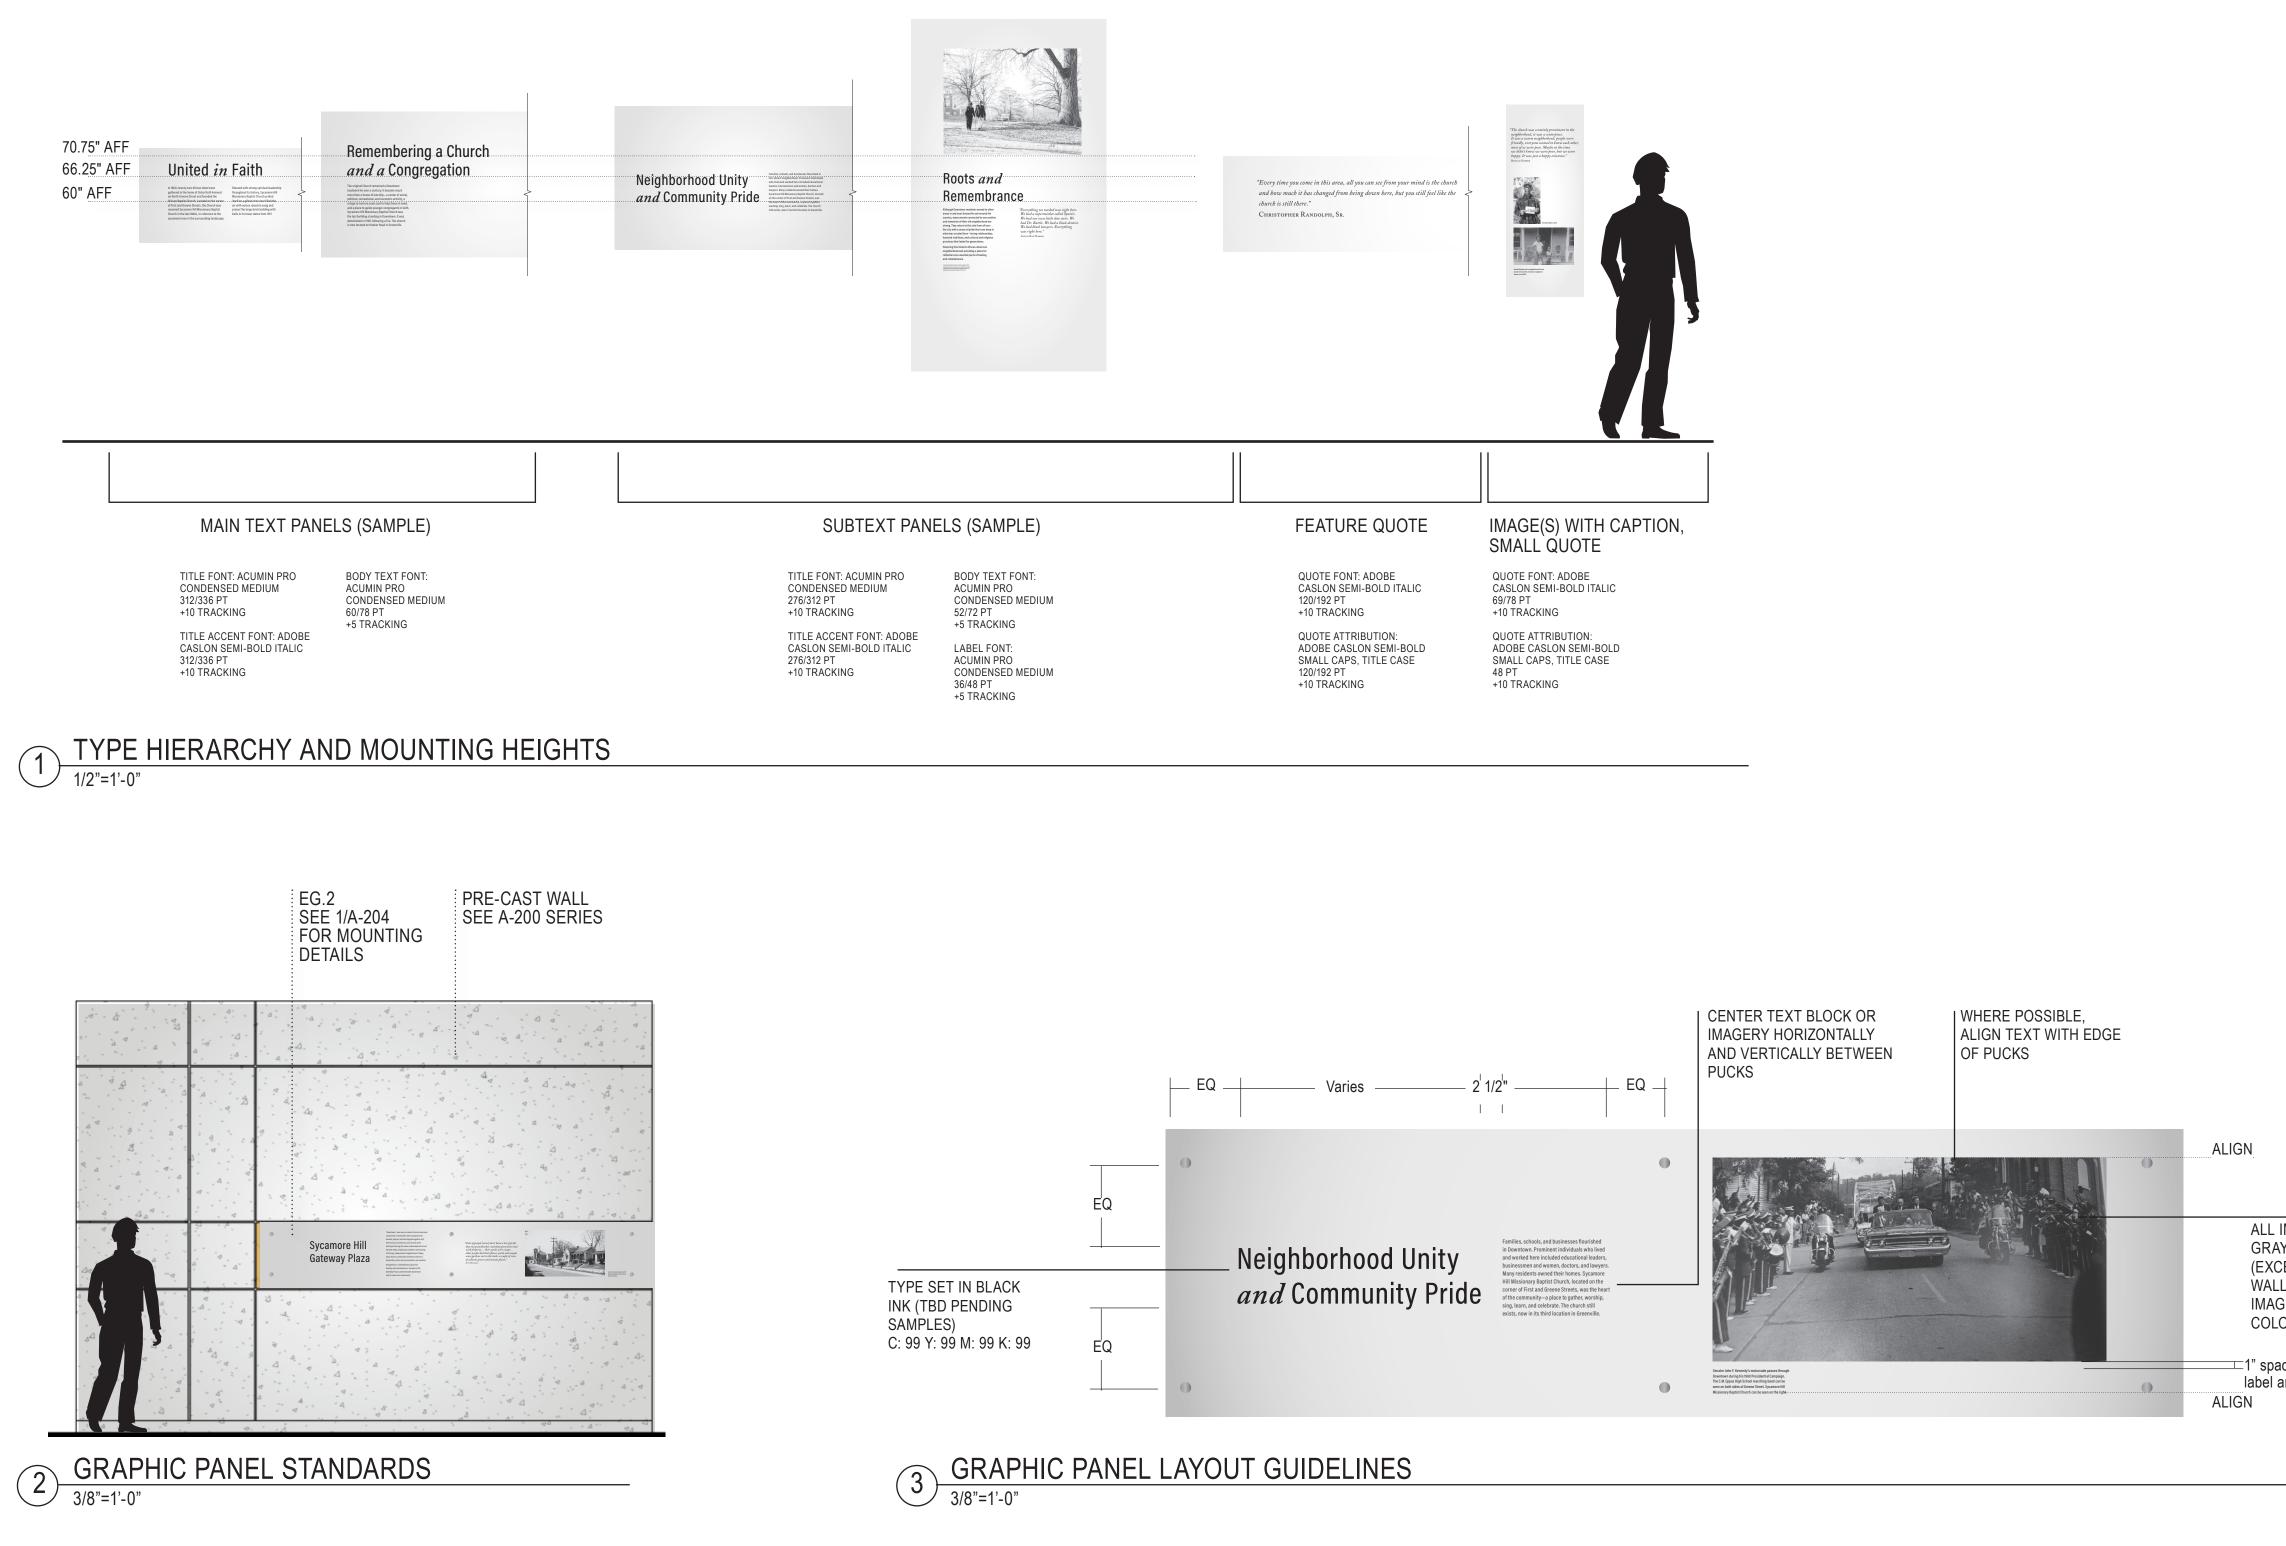

# GREENVILLE TOWN COMMON SYCAMORE HILL **GATEWAY PLAZA**

90% DESIGN SUBMISSION


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CLIENT:



DESIGN TEAM:



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#### NOT FOR CONSTRUCTION AND BIDDING
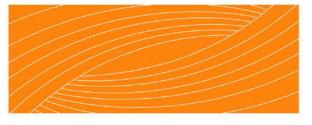
#### **REVISION:**

SCALE:

SHEET NAME:

AS NOTED

**INTERPRETIVE SYSTEM** 


SHEET NUMBER:



DATE:

ALL IMAGERY GRAYSCALE (EXCEPTION: WALL J SOUTH IMAGES FULL COLOR CMYK)

label and images.

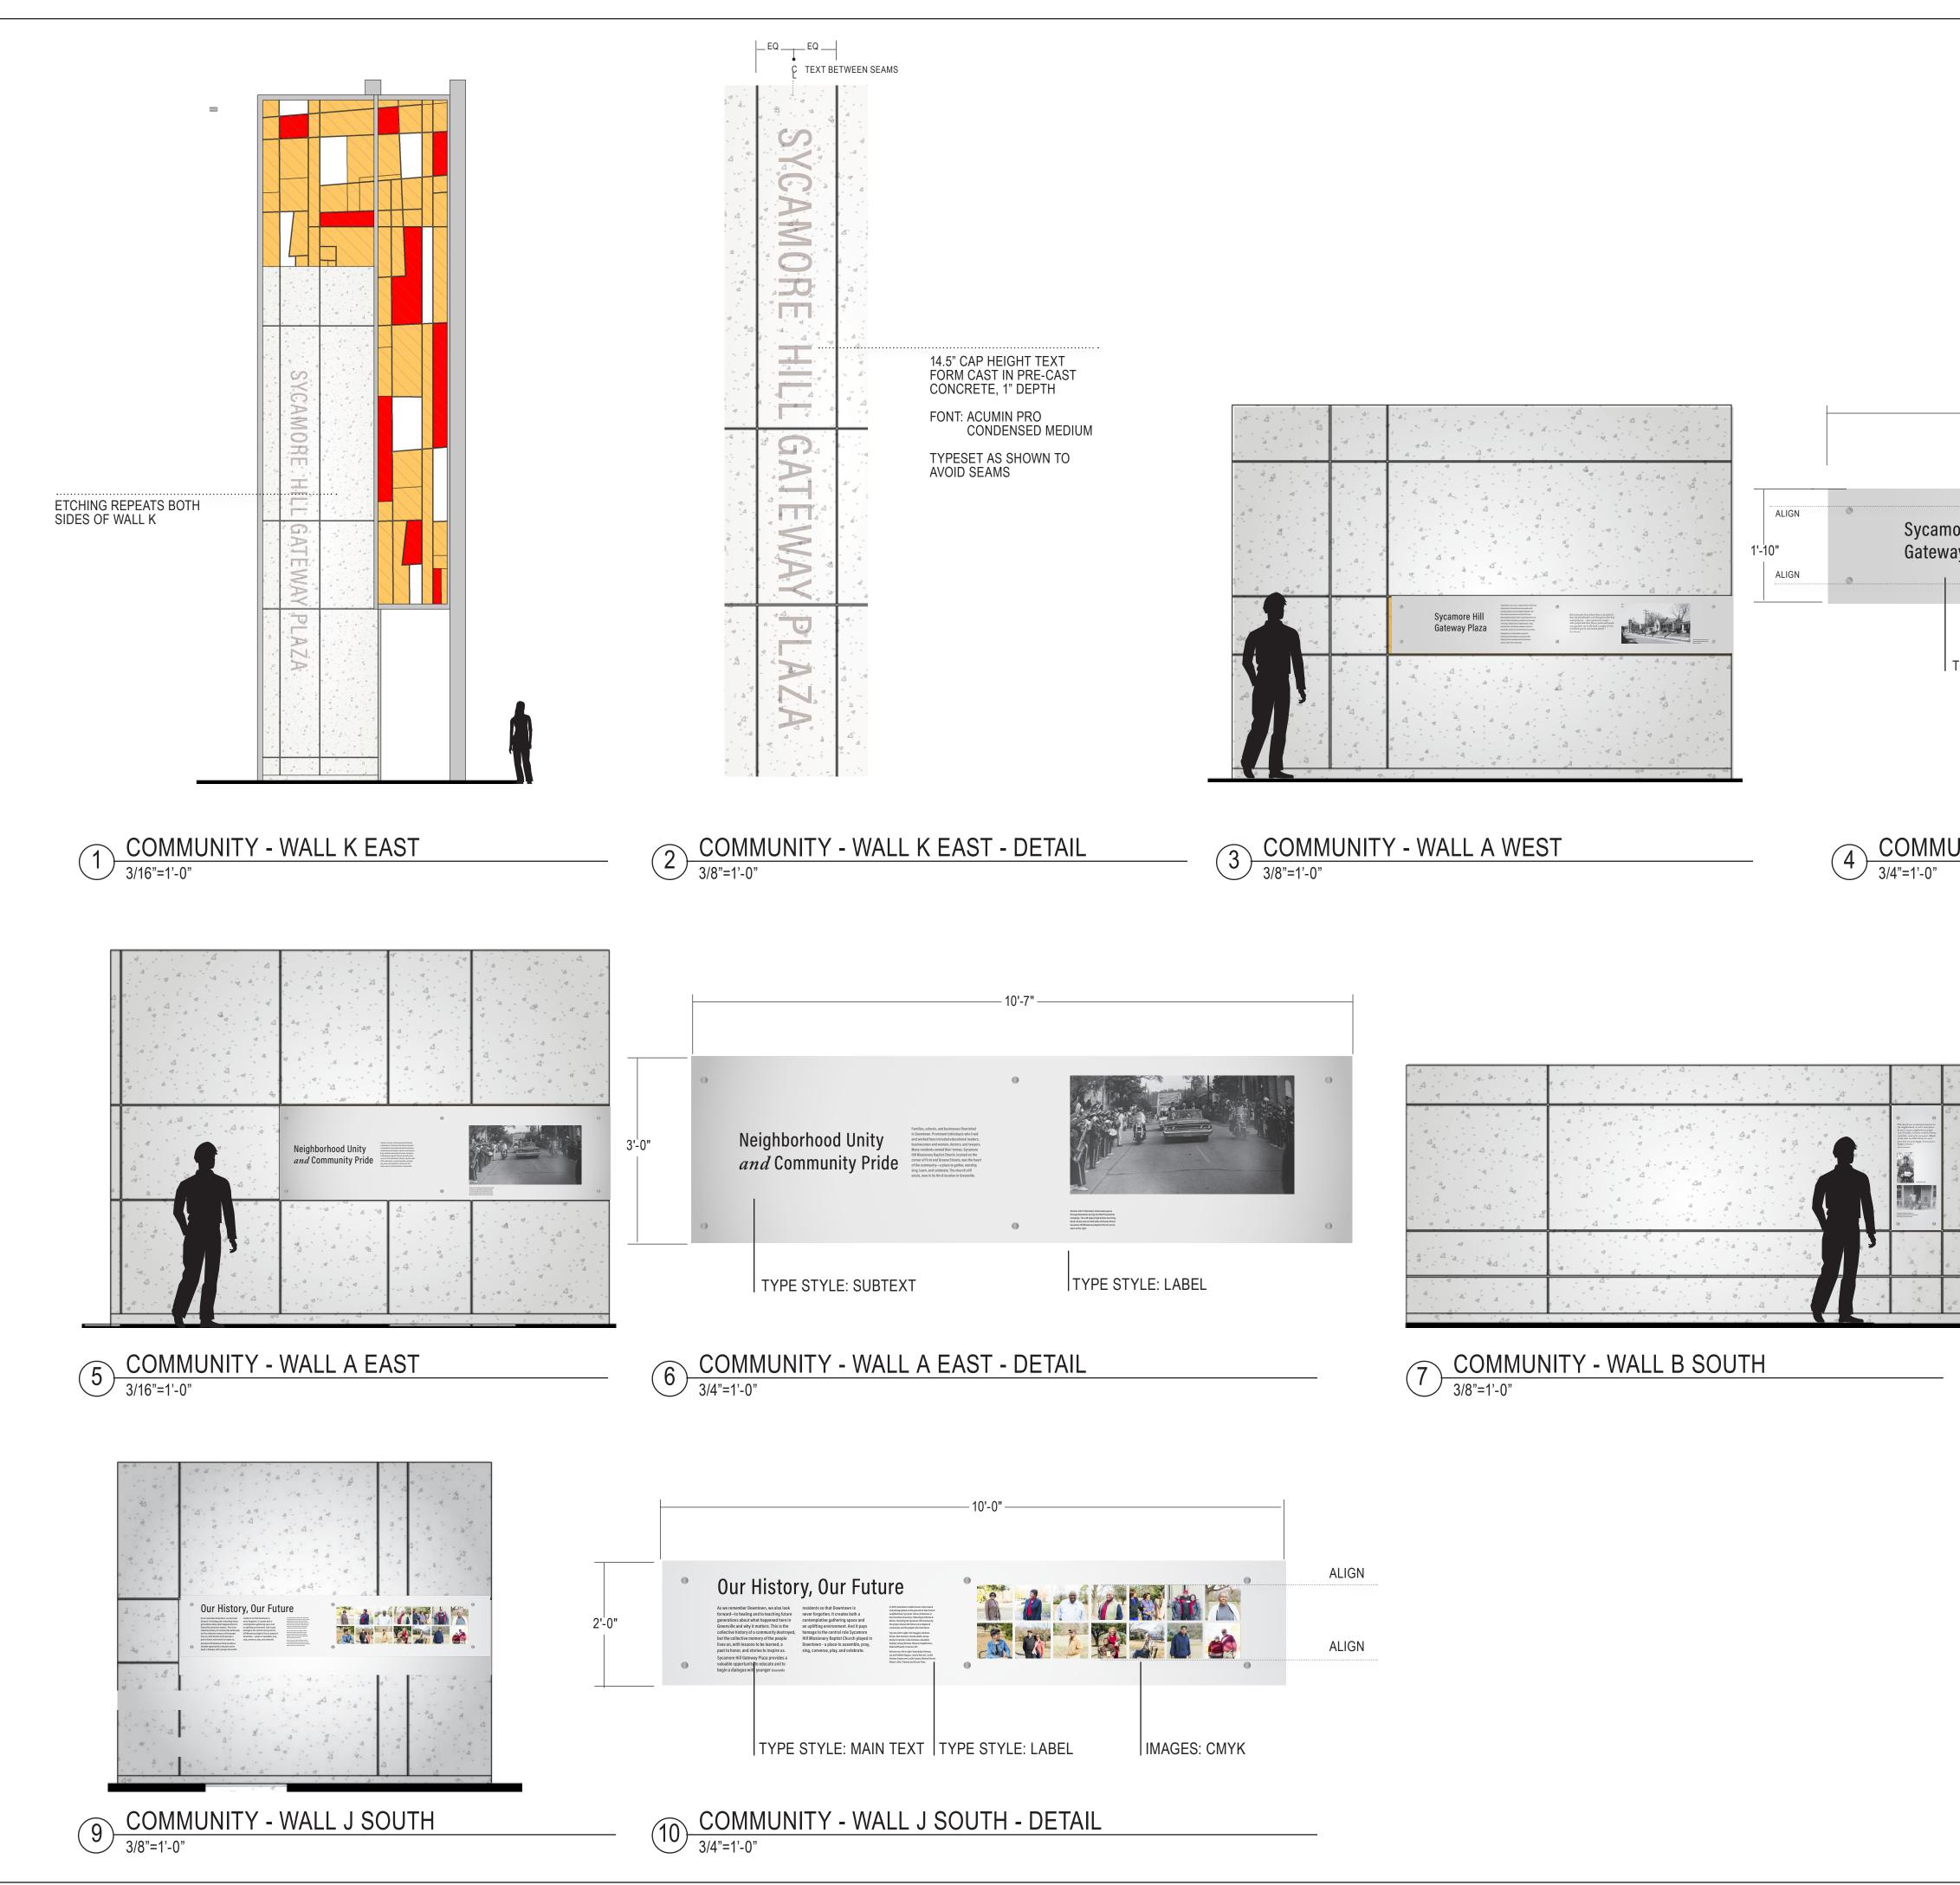


Sycamore Hill Gateway Plaza TYPE STYLE: SUB TEXT



TYPE STYLE: LABEL

### COMMUNITY - WALL A WEST - DETAIL

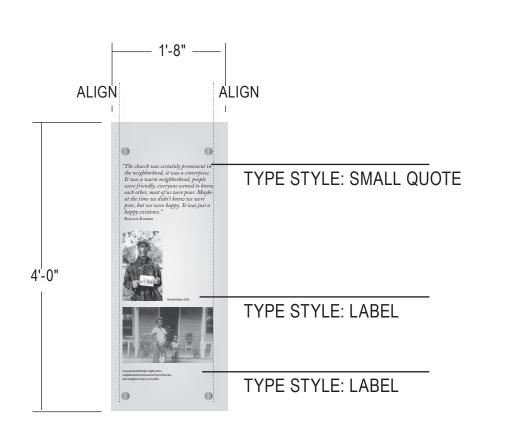

# 8 COMMUNITY - WALL B SOUTH - DETAIL 3/4"=1'-0"

# GREENVILLE TOWN COMMON SYCAMORE HILL **GATEWAY PLAZA**

90% DESIGN SUBMISSION


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Tel. 252.329.4567

CLIENT:



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#### **NOT FOR** CONSTRUCTION AND BIDDING

**REVISION:** 

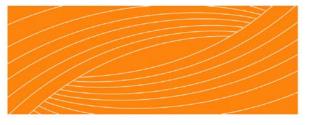SCALE:


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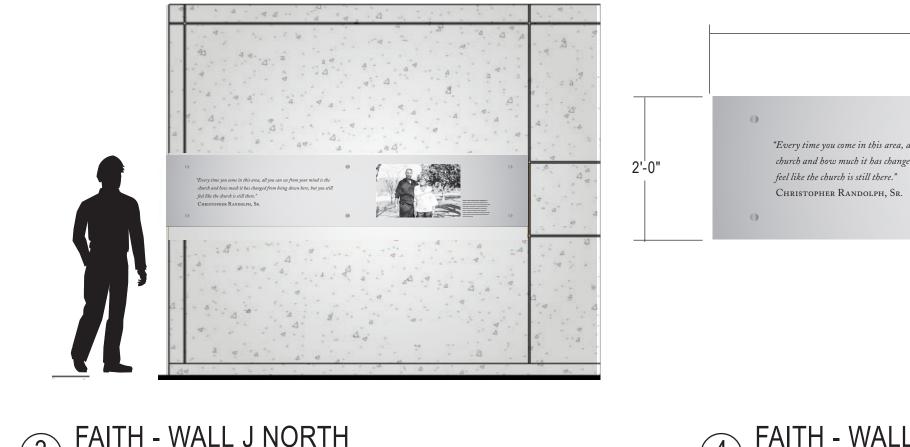
**COMMUNITY GALLERY** INTERPRETIVE PANEL ELEVATIONS

SHEET NUMBER:



AS NOTED



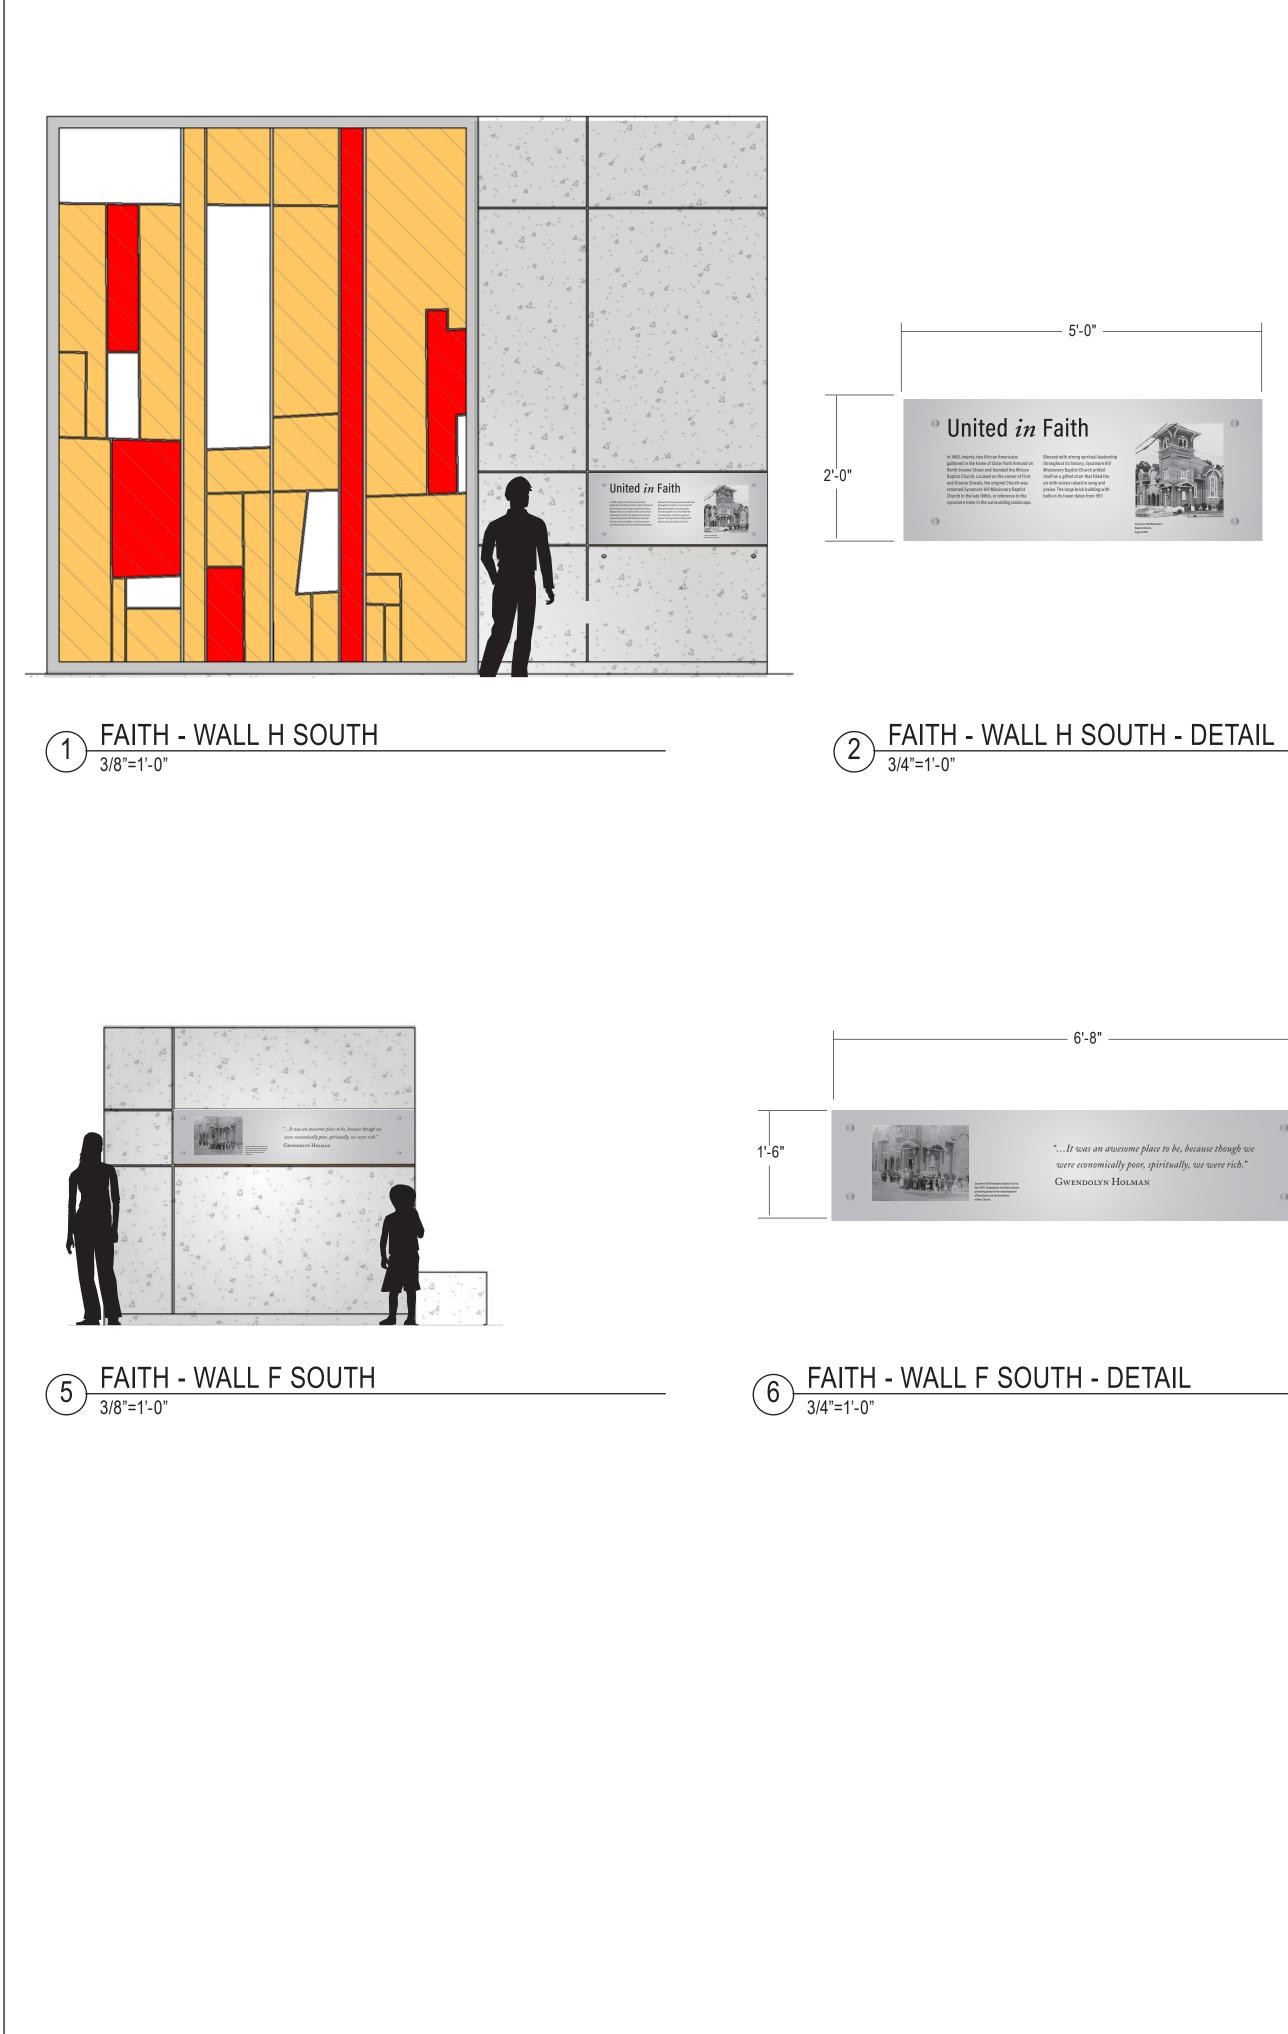

3 FAITH - WALL J NORTH 3/8"=1'-0"

- 10'-0" -

"Every time you come in this area, all you can see from your mind is the church and how much it has changed from being down here, but you still



4 FAITH - WALL J NORTH - DETAIL 3/4"=1'-0"

# GREENVILLE TOWN COMMON SYCAMORE HILL **GATEWAY PLAZA**

90% DESIGN SUBMISSION


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CLIENT:



DESIGN TEAM:



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#### NOT FOR CONSTRUCTION AND BIDDING

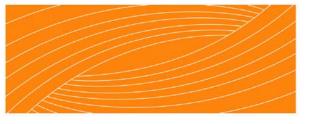**REVISION:** 

SCALE:

SHEET NAME:

FAITH GALLERY INTERPRETIVE PANEL ELEVATIONS

SHEET NUMBER:



AS NOTED



90% DESIGN SUBMISSION


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CLIENT:



DESIGN TEAM:



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**REVISION:** 

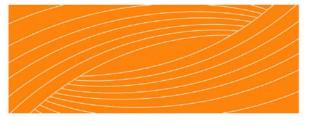SCALE:

SHEET NAME:


REMEMBRANCE GALLERY INTERPRETIVE PANEL ELEVATIONS

SHEET NUMBER:



AS NOTED

### REMEMBRANCE - WALL E SOUTH - DETAIL

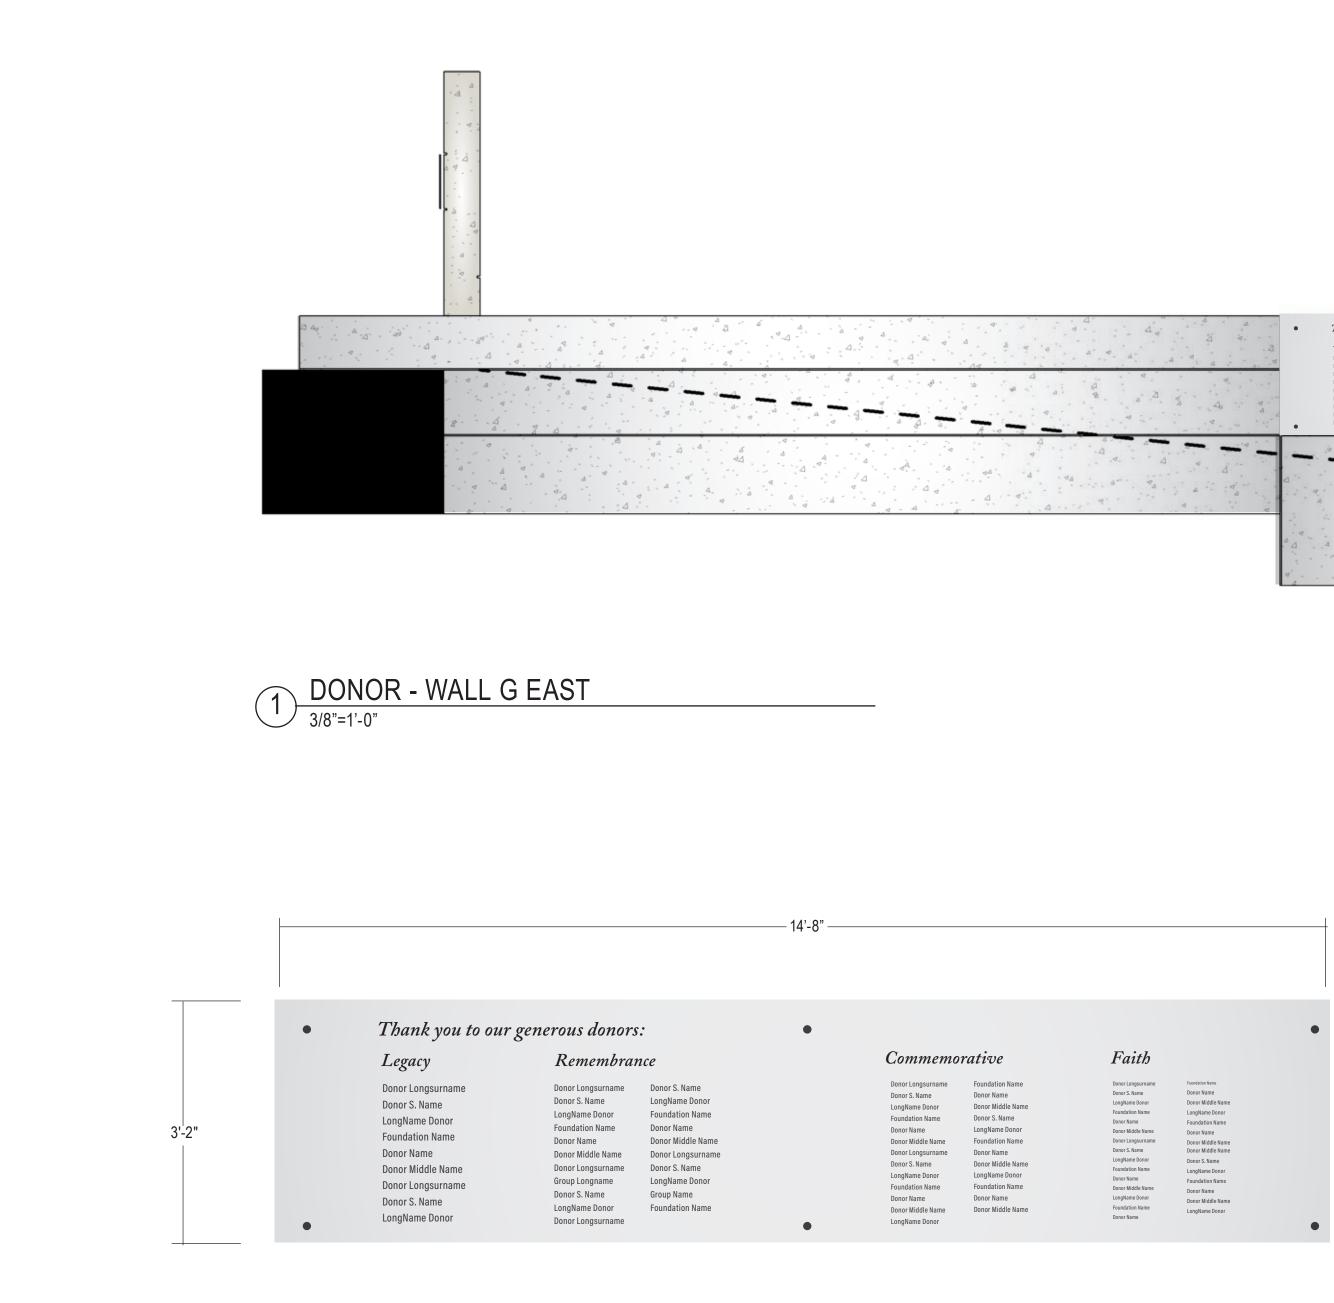



Thank you to our go     Legacy     Door Logsurname     Door S. Name     LongName Donor     Foundation Name     Door Windle Name     Door Windle Name     Door Windle Name     Door Windle Name     Door Kane     LongName Donor	encerous donors: Remembrace Borr Share Longtane Donor Pondation Vane Donor Mare Donor Mare Donor Mare Donor Mare Donor Mare Donor Mare Donor Mare Donor Mare Donor Share Longtane Donor Longtane Donor Donor Share Longtane Donor Donor Share Longtane Donor Donor Share Longtane Donor Donor Share	And a state of the st	Казана К	
	A			

90% DESIGN SUBMISSION


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**REVISION:** 

SCALE:


AS NOTED

REMEMBRANCE GALLERY DONOR WALL ELEVATION

SHEET NUMBER:

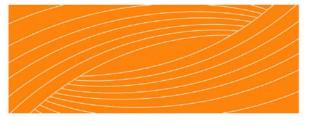SHEET NAME:



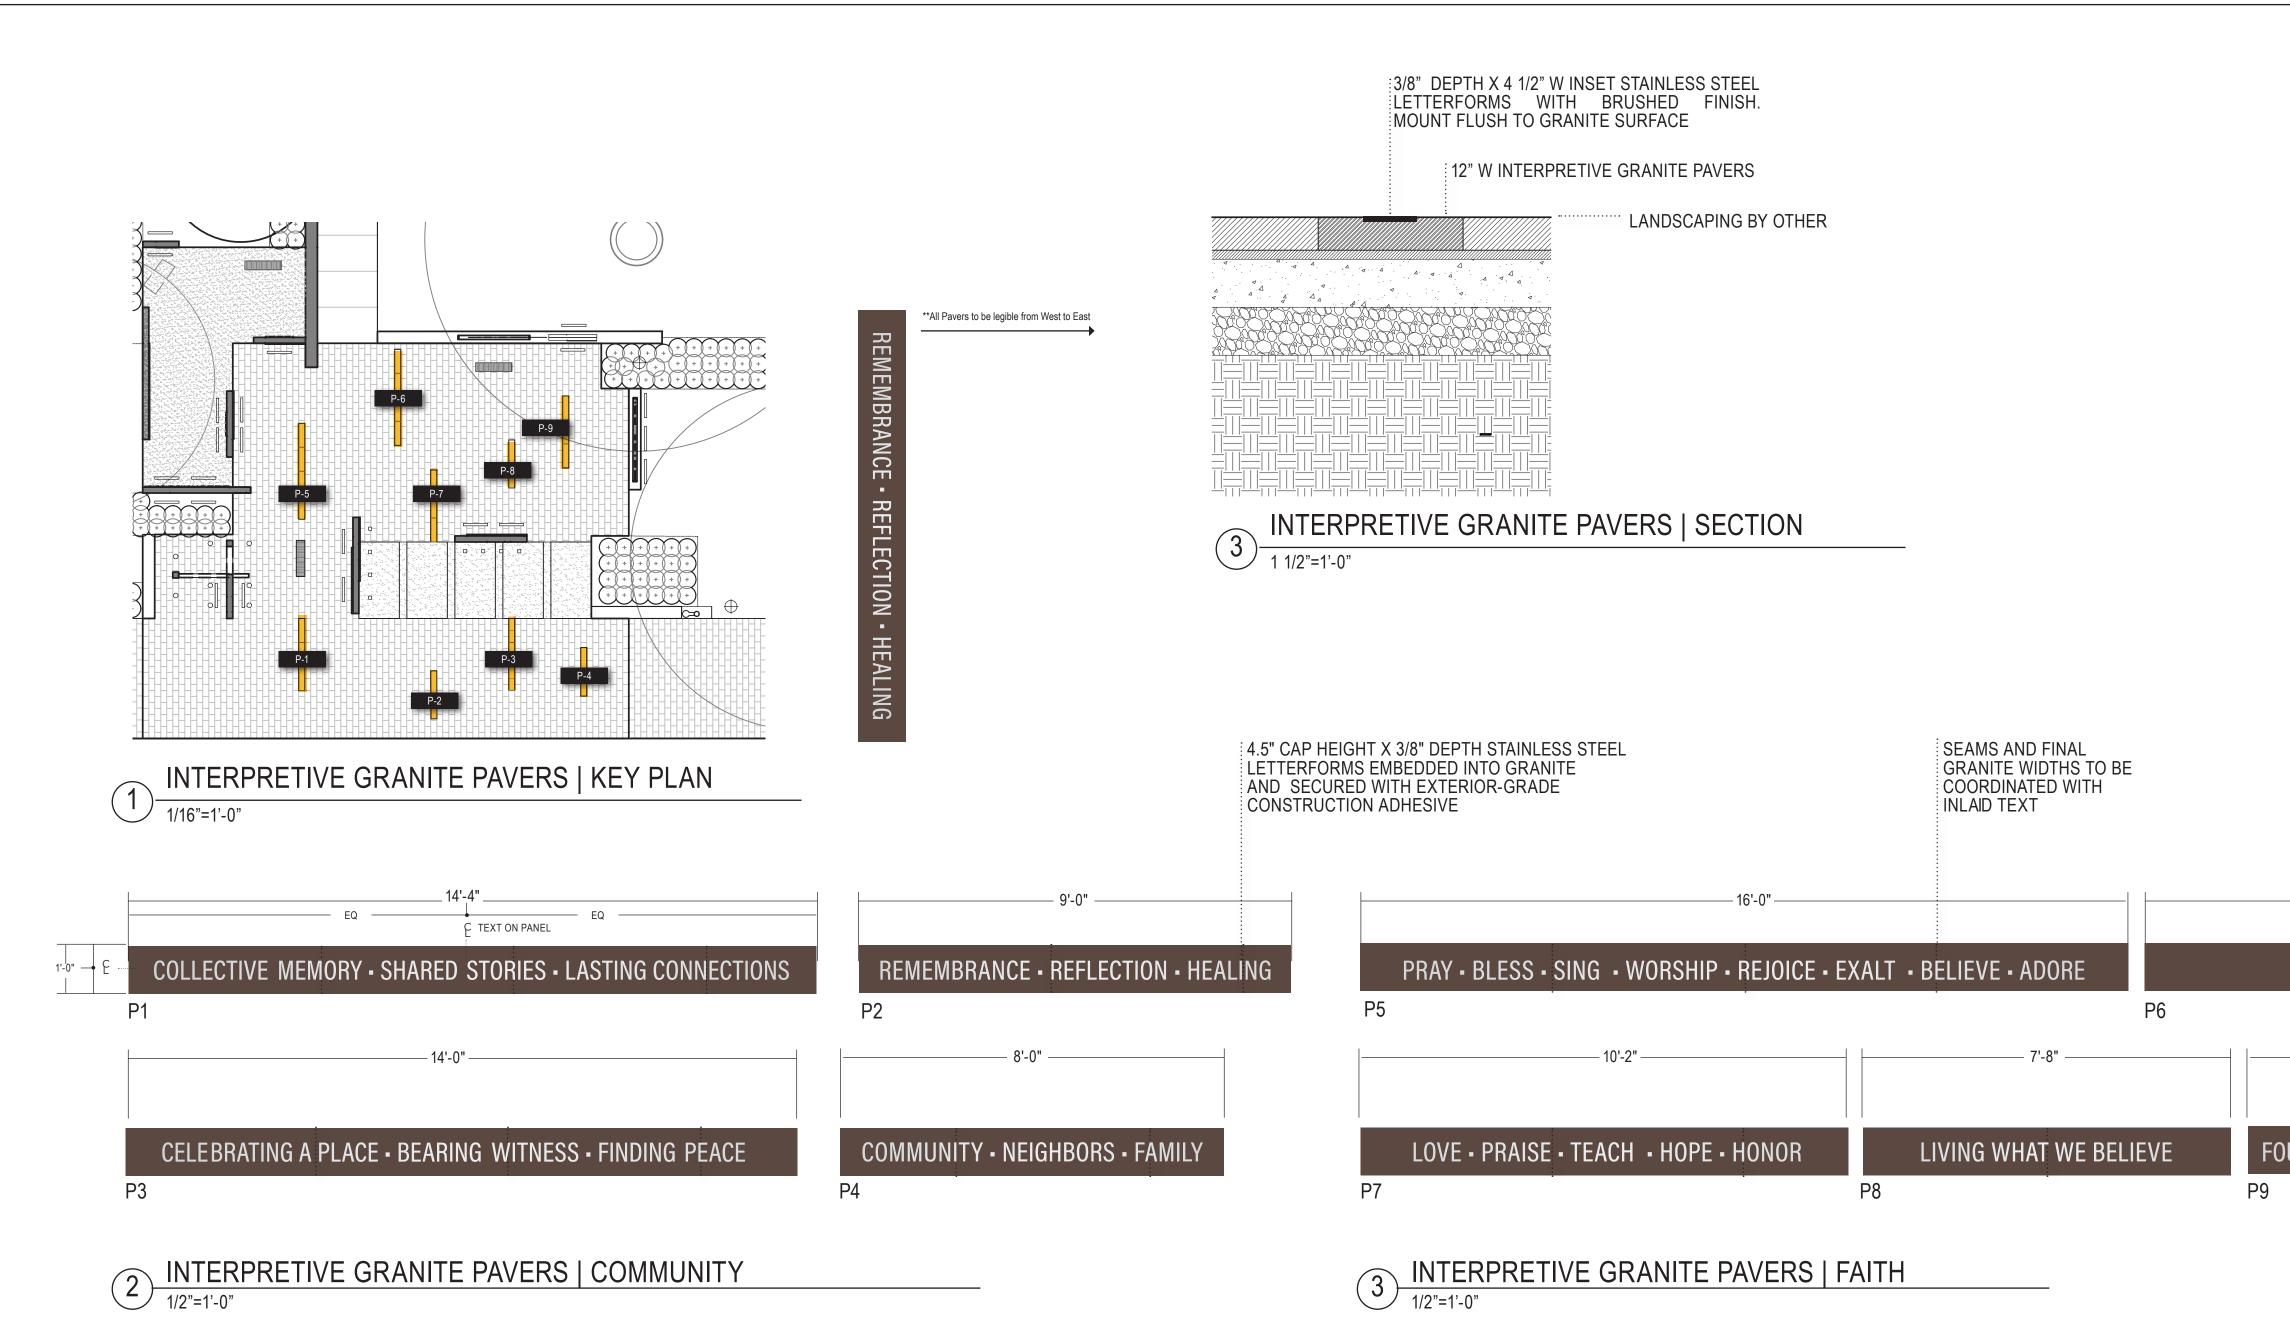

15'-0" —

#### THE SPIRITUAL HEART OF THE COMMUNITY

10'-7"

FOUNDATIONS OF FAITH - FAMILY AND COMMUNITY

# GREENVILLE TOWN COMMON SYCAMORE HILL GATEWAY PLAZA

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#### NOT FOR CONSTRUCTION AND BIDDING

REVISION:

\_\_\_\_\_

SCALE:

SHEET NAME:

AS NOTED

INTERPRETIVE PAVERS

SHEET NUMBER:



## **GENERAL NOTES:**

THE STRUCTURAL DRAWINGS SHALL BE USED IN CONJUNCTION WITH THE ARCHITECTURAL, CIVIL, MECHANICAL, PLUMBING, AND ELECTRICAL DRAWINGS, AND THE SPECIFICATIONS. THE CONTRACTOR SHALL VERIFY THE REQUIREMENTS OF OTHER TRADES AS TO SLEEVES, CHASES, HANGERS, INSERTS, ANCHORS, HOLES, AND ADDITIONAL ITEMS TO BE PLACED OR SET IN THE STRUCTURAL WORK.

2. THIS STRUCTURE HAS BEEN DESIGNED IN ACCORDANCE WITH THE PROVISIONS OF THE NORTH CAROLINA STATE BUILDING CODE, 2012 EDITION.

3. THE CONTRACTOR SHALL PROVIDE TEMPORARY SHORING AND BRACING REQUIRED TO ERECT AND HOLD THE STRUCTURE IN PROPER ALIGNMENT UNTIL PERMANENT SUPPORTS AND LATERAL BRACING ARE IN PLACE.

DESIGN CRITERIA:	
CLASSIFICATION OF BUILDING	
OCCUPANCY CATEGORY II	
LIVE LOADS - UNIFORM:	
SLAB ON GRADE	
SNOW LOADS:	
GROUND SNOW LOAD 15 PSF	
WIND LOADS:	
BASIC WIND SPEED	
EXPOSURE CATEGORY C IMPORTANCE FACTOR (Iw) 1.0	
COMPONENT AND CLADDING PRESSURES:	
FREESTANDING WALLS 30 PSF	
SEISMIC LOADS:	
SITE CLASSIFICATION.	
SEISMIC DESIGN CATEGORY.	
IMPORTANCE FACTOR (I <sub>E</sub> )	
SPECTRAL RESPONSE ACCELERATIONS:	
$S_{S_{}}$ 15.4%g $S_{1}$ 6.5%g $S_{DS_{}}$ 17.0%g $S_{D1_{}}$ 10.4%g	
0DS0/8g 0D110.4/8g	
ANALYSIS PROCEDURE: EQUIVALENT LATERAL FORCE	
BASIC STRUCTURAL SYSTEM: CONCRETE SHEAR WALLS,	
STEEL SYSTEMS NOT SPECIFICALLY DETAILED FOR	
SPECIFICALLY DETAILED FOR SEISMIC RESISTANCE	
RESPONSE MODIFICATION COEFFICIENT (R)4,3	
SEISMIC RESPONSE COEFFICIENT (Cs)	

## FOUNDATION NOTES:

1. FOUNDATIONS HAVE BEEN DESIGNED IN ACCORDANCE WITH THE RECOMMENDATIONS IN THE [SUBSURFACE EXPLORATION AND GEOTECHNICAL ENGINEERING REPORT PREPARED BY TENICON, DATED MAY 13, 2018.

2. FOUNDATIONS HAVE BEEN DESIGNED FOR A NET ALLOWABLE SOIL BEARING PRESSURE OF 2000 PSF.

3. PRIOR TO PLACING FOUNDATION CONCRETE, ALL FOUNDATION EXCAVATIONS SHALL BE INSPECTED BY THE SPECIAL INSPECTOR TO EXPLORE THE EXTENT OF LOOSE, SOFT, EXPANSIVE, OR OTHERWISE UNSATISFACTORY SOIL MATERIAL AND TO VERIFY DESIGN BEARING PRESSURE. DIRECTION FOR CORRECTIVE ACTION WILL BE PROVIDED WHERE REQUIRED.

4. NO UNBALANCED BACKFILLING SHALL BE DONE AGAINST MASONRY OR CONCRETE WALLS UNLESS WALLS ARE SECURELY BRACED AGAINST OVERTURNING. EITHER BY TEMPORARY CONSTRUCTION BRACING OR BY PERMANENT CONSTRUCTION.

5. THE CONTRACTOR SHALL BE SOLELY RESPONSIBLE FOR CONTROL OF GROUNDWATER AND SURFACE RUNOFF THROUGHOUT THE CONSTRUCTION PROCESS. INUNDATION AND LONG TERM EXPOSURE OF BEARING SURFACES WHICH RESULT IN DETERIORATION OF BEARING SHALL BE PREVENTED.

## **CAST-IN-PLACE CONCRETE NOTES:**

1. CONCRETE SHALL BE IN ACCORDANCE WITH AMERICAN CONCRETE INSTITUTE (ACI) 301 AND 318.

2. CONCRETE SHALL BE NORMAL WEIGHT JUNLESS OTHERWISE DENOTED AS LW (LIGHTWEIGHT)] AND SHALL OBTAIN 28 DAY COMPRESSIVE STRENGTHS AS FOLLOWS:

- A. SLAB-ON-GRADE
- B. WALLS.
- REINFORCING MATERIALS SHALL BE AS FOLLOWS:
- A. REINFORCING BARS ASTM A 615, GRADE 60, DEFORMED.
- B. WELDED REINFORCING BARS ASTM A 706, GRADE 60.

C. WELDED WIRE REINFORCEMENT - ASTM A 185, WELDED STEEL WIRE REINFORCEMENT: PROVIDE SHEET TYPE. ROLL TYPE IS NOT ACCEPTABLE.

4. ALL REINFORCING STEEL AND EMBEDDED ITEMS SUCH AS ANCHOR RODS AND WELD PLATES SHALL BE ACCURATELY PLACED AND ADEQUATELY TIED AND SUPPORTED BEFORE CONCRETE IS PLACED TO PREVENT DISPLACEMENT BEYOND PERMITTED TOLERANCES.

5. CONCRETE COVER TO REINFORCING STEEL SHALL CONFORM TO THE MINIMUM COVER RECOMMENDATIONS IN ACI 318, UNLESS THE DRAWINGS SHOW GREATER COVER REQUIREMENTS.

6. LAP CONTINUOUS REINFORCING STEEL 57 X BAR DIAMETER, TYPICAL UNLESS OTHERWISE NOTED.

### STRUCTURAL PRECAST CONCRETE NOTES:

1. STRUCTURAL PRECAST CONCRETE SHALL BE IN ACCORDANCE WITH THE AMERICAN CONCRETE INSTITUTE (ACI) 318.

2. SUBMIT SHOP DRAWINGS SIGNED AND SEALED BY THE PROFESSIONAL ENGINEER REGISTERED IN THE STATE OF NORTH CAROLINA RESPONSIBLE FOR THE DESIGN OF STRUCTURAL PRECAST CONCRETE, INCLUDING DESIGN LOADINGS AND REACTIONS APPLIED TO THE SUPPORTING STRUCTURE. INCLUDE A SUMMARY OF THE CONTROLLING LOAD CASES FOR EACH LOCATION.

3. IN ADDITION TO THEIR OWN DEAD WEIGHT AND THE DEAD LOADS SHOWN OR INDICATED IN THE DRAWINGS, PRECAST MEMBERS SHALL BE DESIGNED TO SUPPORT THE LOADS INDICATED IN THE GENERAL NOTES.

4. CONCRETE SHALL BE NORMAL WEIGHT AND SHALL OBTAIN A MINIMUM 28 DAY COMPRESSIVE STRENGTH OF 5,000 PSI.

- 5. REINFORCING MATERIALS SHALL BE AS FOLLOWS:
- A) REINFORCING BARS: ASTM A 615, GRADE 60, DEFORMED.
- B) WELDED REINFORCING BARS ASTM A706, GRADE 60.
- C) WELDED WIRE FABRIC: ASTM A 185
- D) PRESTRESSING TENDONS SHALL COMPLY WITH ASTM A 416 GRADE 250 OR 270. UNCOATED. 7-WIRE STRESS-RELIEVED STRAND.

CONNECTION DETAILS SHOWN ARE SCHEMATIC ONLY. ALL CONNECTIONS SHALL BE DEVELOPED BY THE PRECAST MANUFACTURER TO SUIT THE SPECIFIED LOADS. CONNECTIONS SHALL ACCOUNT FOR THERMAL MOVEMENT AND CREEP OF PRECAST MEMBERS. DETAIL ALL CONNECTIONS ON SHOP DRAWINGS.

..3,500 PSI

..4,000 PSI

## STRUCTURAL STEEL NOTES:

1. STRUCTURAL STEEL SHALL BE IN ACCORDANCE WITH THE AMERICAN INSTITUTE OF STEEL CONSTRUCTION (AISC) 360.

- 2. STRUCTURAL STEEL SHALL COMPLY WITH THE FOLLOWING SPECIFICATIONS:
- A. STRUCTURAL STEEL SHAPES, PLATES AND BARS ULESS OTHERWISE NOTED ASTM A 36, Fy = 36 KSI

B. HOLLOW STRUCTURAL SECTIONS (HSS): SQUARE AND RECTANGULAR - ASTM A 500, GRADE B, Fy = 46 KSI

- C. STEEL CASTINGS ASTM A 216, GRADE WCB, MEDIUM STRENGTH CARBON STEEL
- D. ANCHOR RODS ASTM F 1554, GRADE [36] [55]
- E. HIGH STRENGTH BOLTS ASTM A325 (TYPICAL UON)
- F. WASHERS ASTM F 436
- G. NUTS ASTM A 563

3. HIGH STRENGTH BOLTS MAY BE TIGHTENED TO THE "SNUG TIGHT" CONDITION IN LIEU OF FULL PRETENSIONING.

4. WELDING SHALL BE IN ACCORDANCE WITH AWS D1.1, "STRUCTURAL WELDING CODE - STEEL." WELD ELECTRODES SHALL BE E70XX LOW HYDROGEN. UNLESS OTHERWISE NOTED, PROVIDE CONTINUOUS FILLET WELDS WITH MINIMUM SIZE REQUIRED BY TABLE J2.4 AISC 360.

5. HOT DIP GALVANIZE AFTER FABRICATION THE FOLLOWING:

A. ALL STEEL EXPOSED TO WEATHER IN THE FINAL CONSTRUCTION.

6. ALL MEMBERS EXPOSED TO VIEW IN THE FINISHED CONSTRUCTION SHALL BE CONSIDERED ARCHITECTURALLY EXPOSED STRUCTURAL STEEL (AESS)

7. STEEL MEMBERS SHALL BE SPLICED ONLY WHERE INDICATED. CONTINUOUS MEMBERS SHALL BE SPLICED OVER SUPPORTS, UNLESS OTHERWISE NOTED



Structural Engineers 415 Hillsborough St., Ste 101 Raleigh, NC 27603 919.782.1833 - lynchmykins.com Corp No. C-4360

# GREENVILLE TOWN COMMON SYCAMORE HILL GATEWAY PLAZA

90% DESIGN SUBMISSION

#### ADDRESS:

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CLIENT:



DESIGN TEAM:




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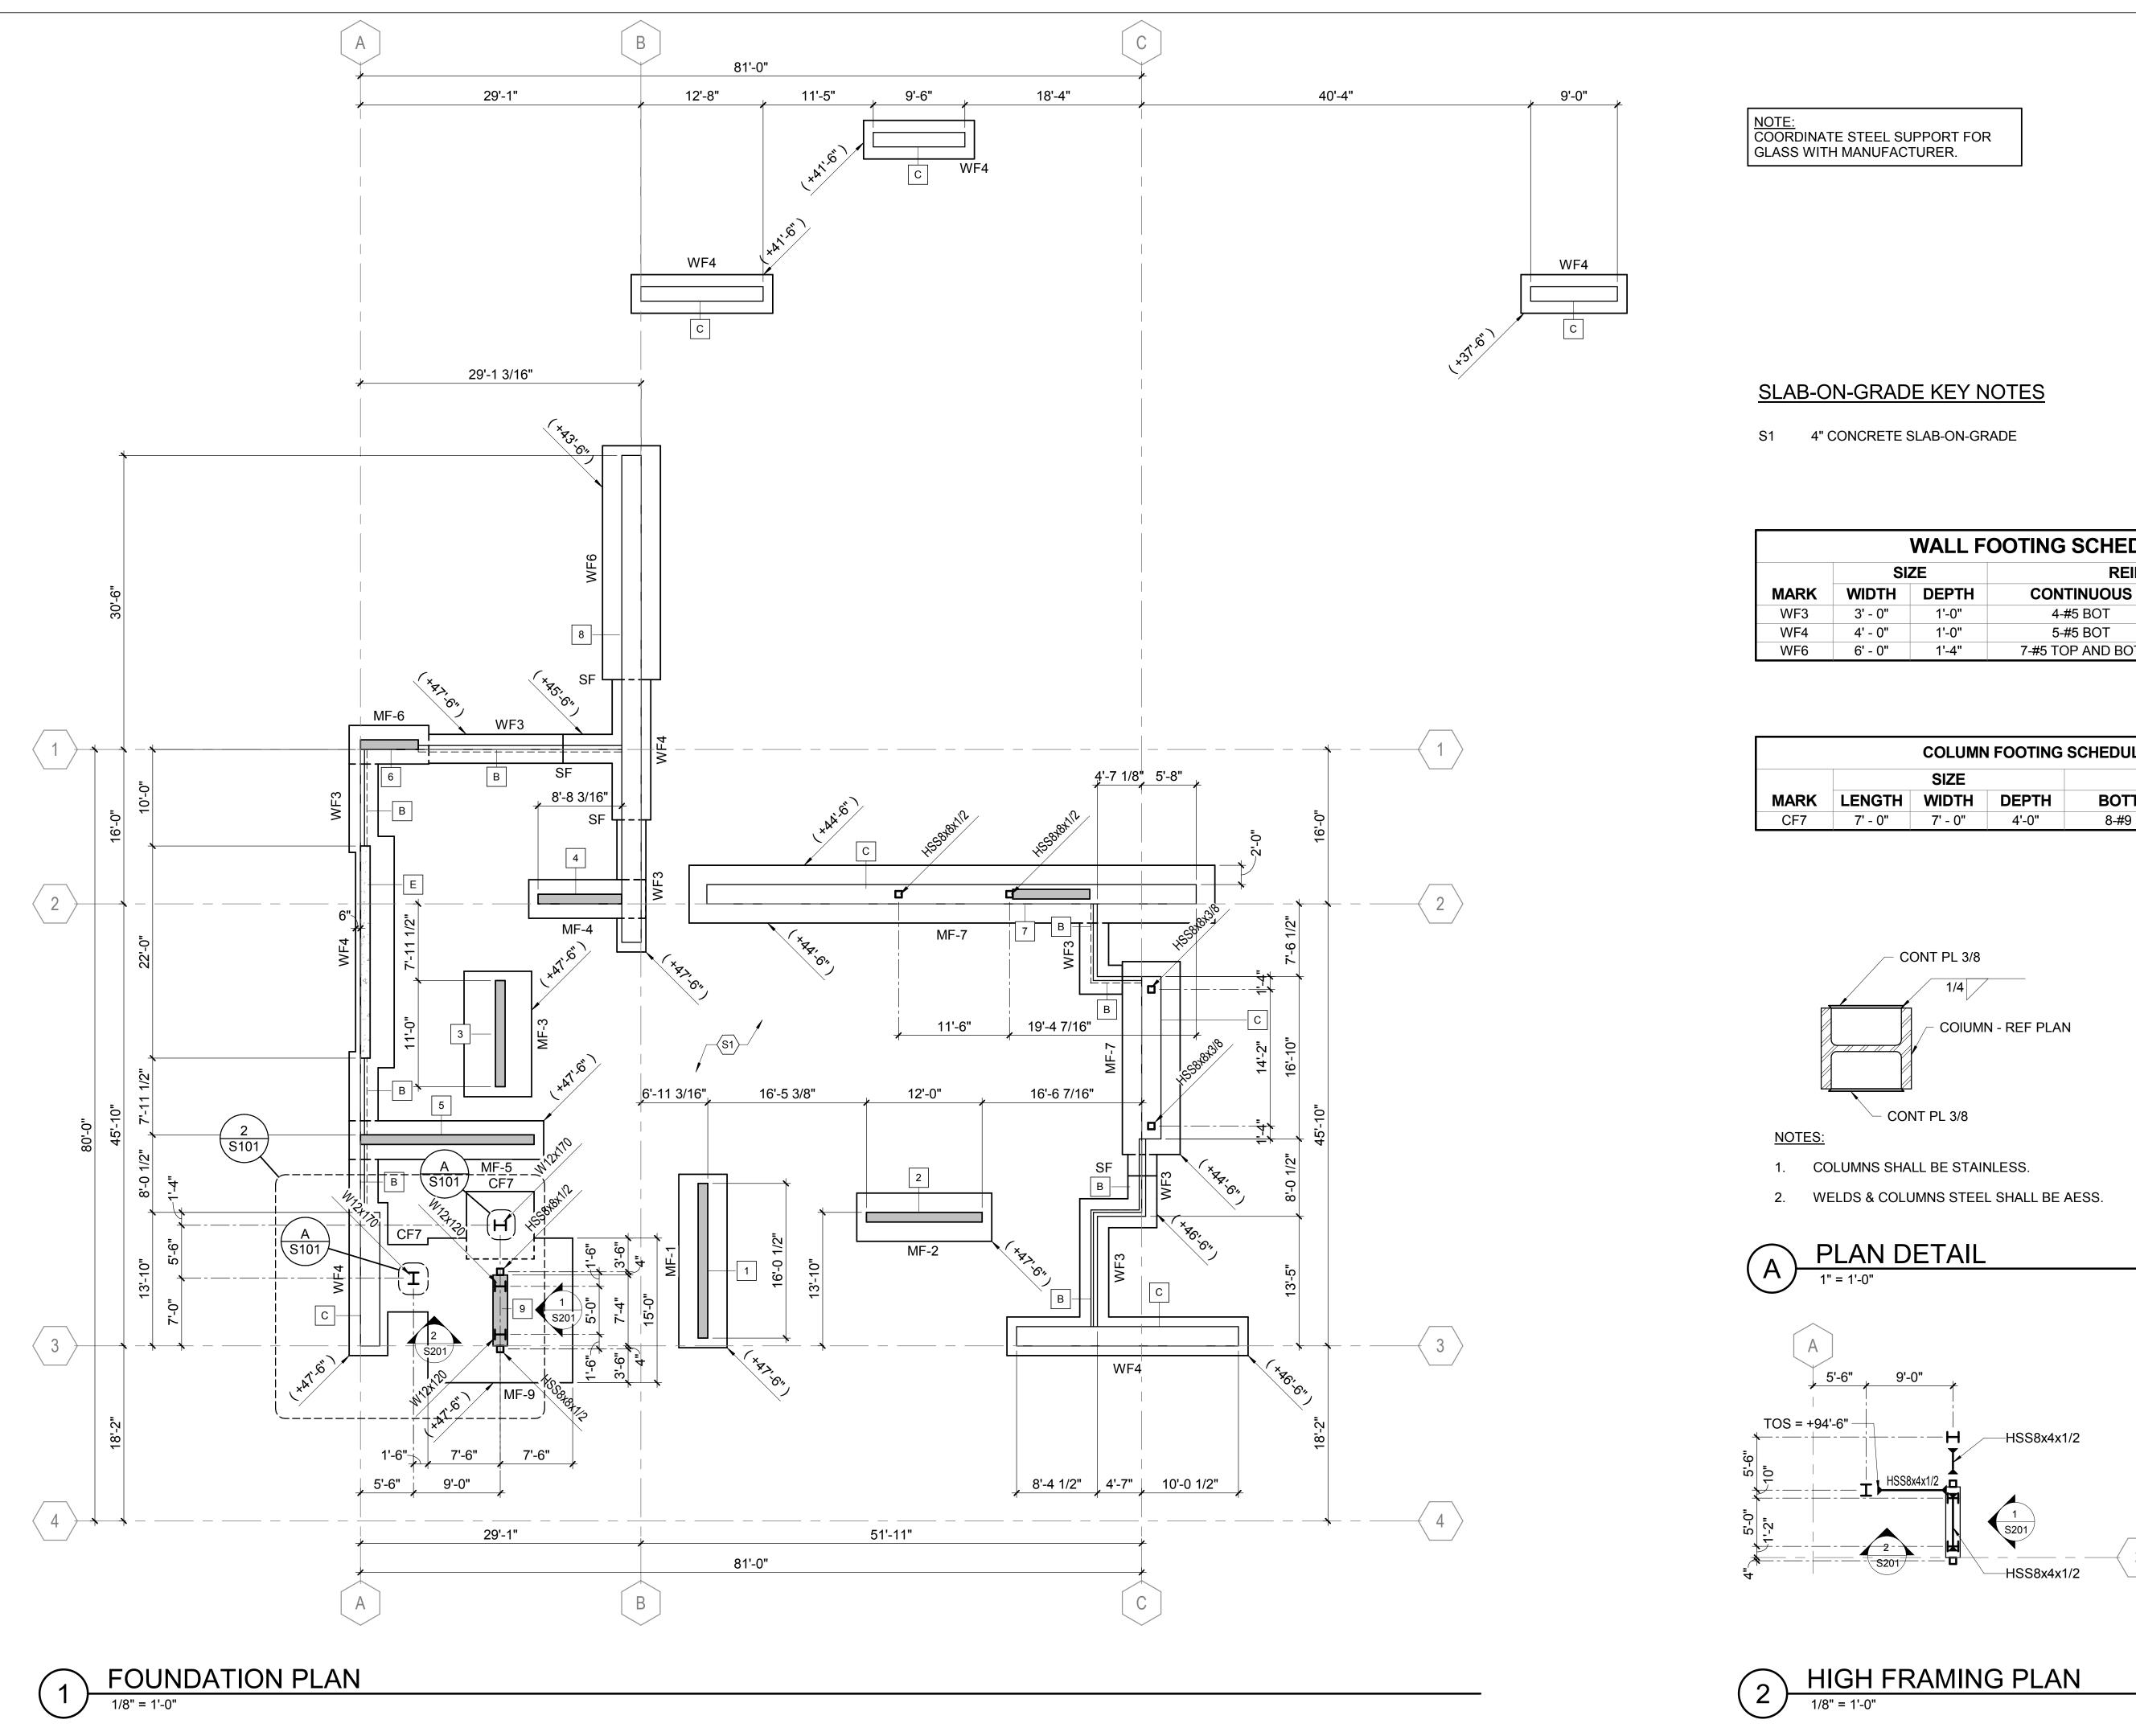


# **REVISION:** MARK ISSUE SCALE: SHEET NAME: **GENERAL NOTES**

SHEET NUMBER:

DATE:

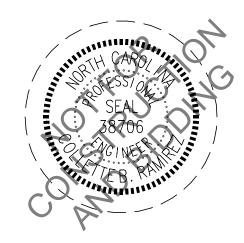





Structural Engineers 415 Hillsborough St., Ste 101 Raleigh, NC 27603 919.782.1833 - lynchmykins.com Corp No. C-4360

# GREENVILLE TOWN COMMON SYCAMORE HILL GATEWAY PLAZA

## 90% DESIGN SUBMISSION


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CLIENT:



DESIGN TEAM:




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# **REVISION:** MARK SCALE: SHEET NAME: FOUNDATION PLAN SHEET NUMBER:

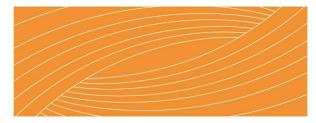


SEPTEMBER 26 2018

DATE:

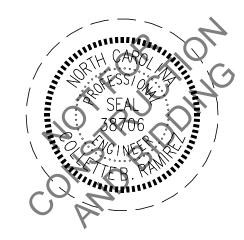WALL FOOTING SCHEDULE REINFORCING CONTINUOUS TRANSVERSE #5 AT 12" OC BOT

0"	1'-0"	5-#5 BOT	#5 AT 12" OC BOT
0"	1'-4"	7-#5 TOP AND BOT	#5 AT 12" OC BOT

COLUMN FOOTING SCHEDULE					
SIZE		REINFORCING			
WIDTH	DEPTH	BOTTOM	TOP		
7' - 0"	4'-0"	8-#9 EW	8-#9 EW		
	SIZE WIDTH	SIZE WIDTH DEPTH	SIZE REINFOR WIDTH DEPTH BOTTOM		

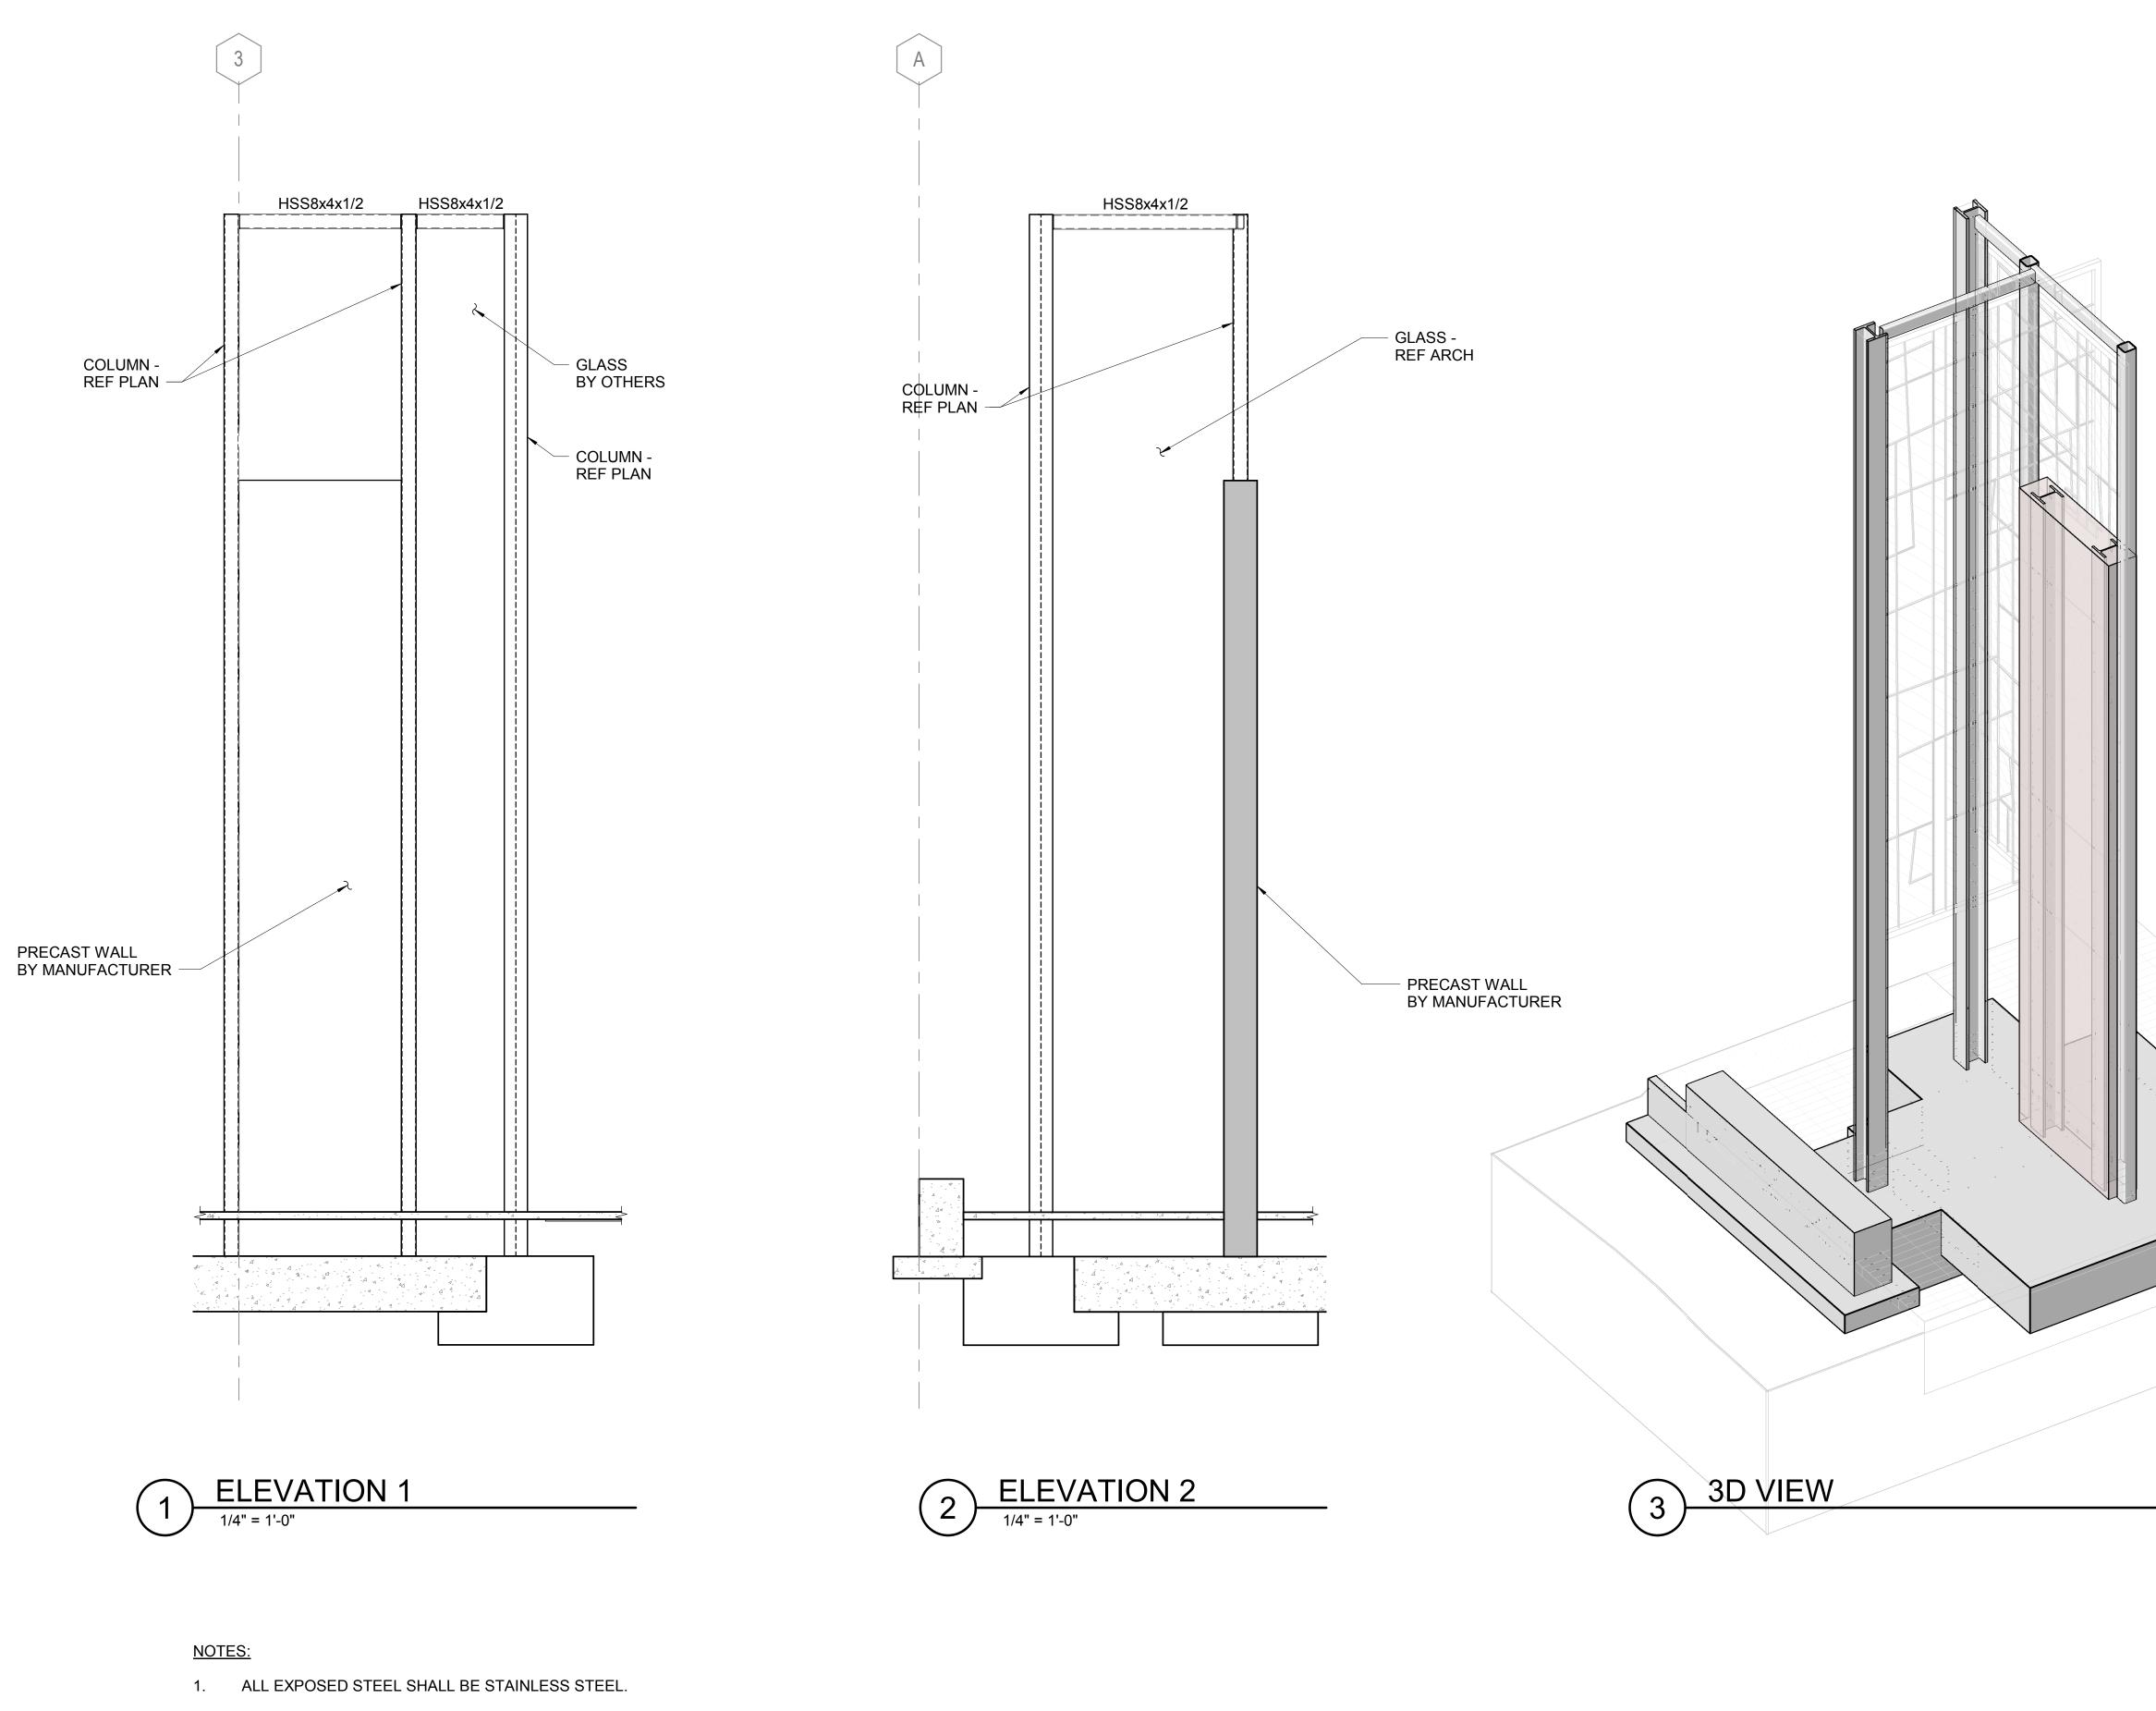

2. ALL WELDS SHALL BE AESS.



Structural Engineers 415 Hillsborough St., Ste 101 Raleigh, NC 27603 919.782.1833 - lynchmykins.com Corp No. C-4360

# GREENVILLE TOWN COMMON SYCAMORE HILL GATEWAY PLAZA

90% DESIGN SUBMISSION

#### ADDRESS:

201 W 1ST ST, GREENVILLE, NC 27858 Tel. 252.329.4567

CLIENT:



DESIGN TEAM:




RHODESIDE & HARWELL 510 King Street Suite 300 Alexandria, VA 22314 703-683-7447 ph 703-683-7449 fx www.rhodeside-harwell.com

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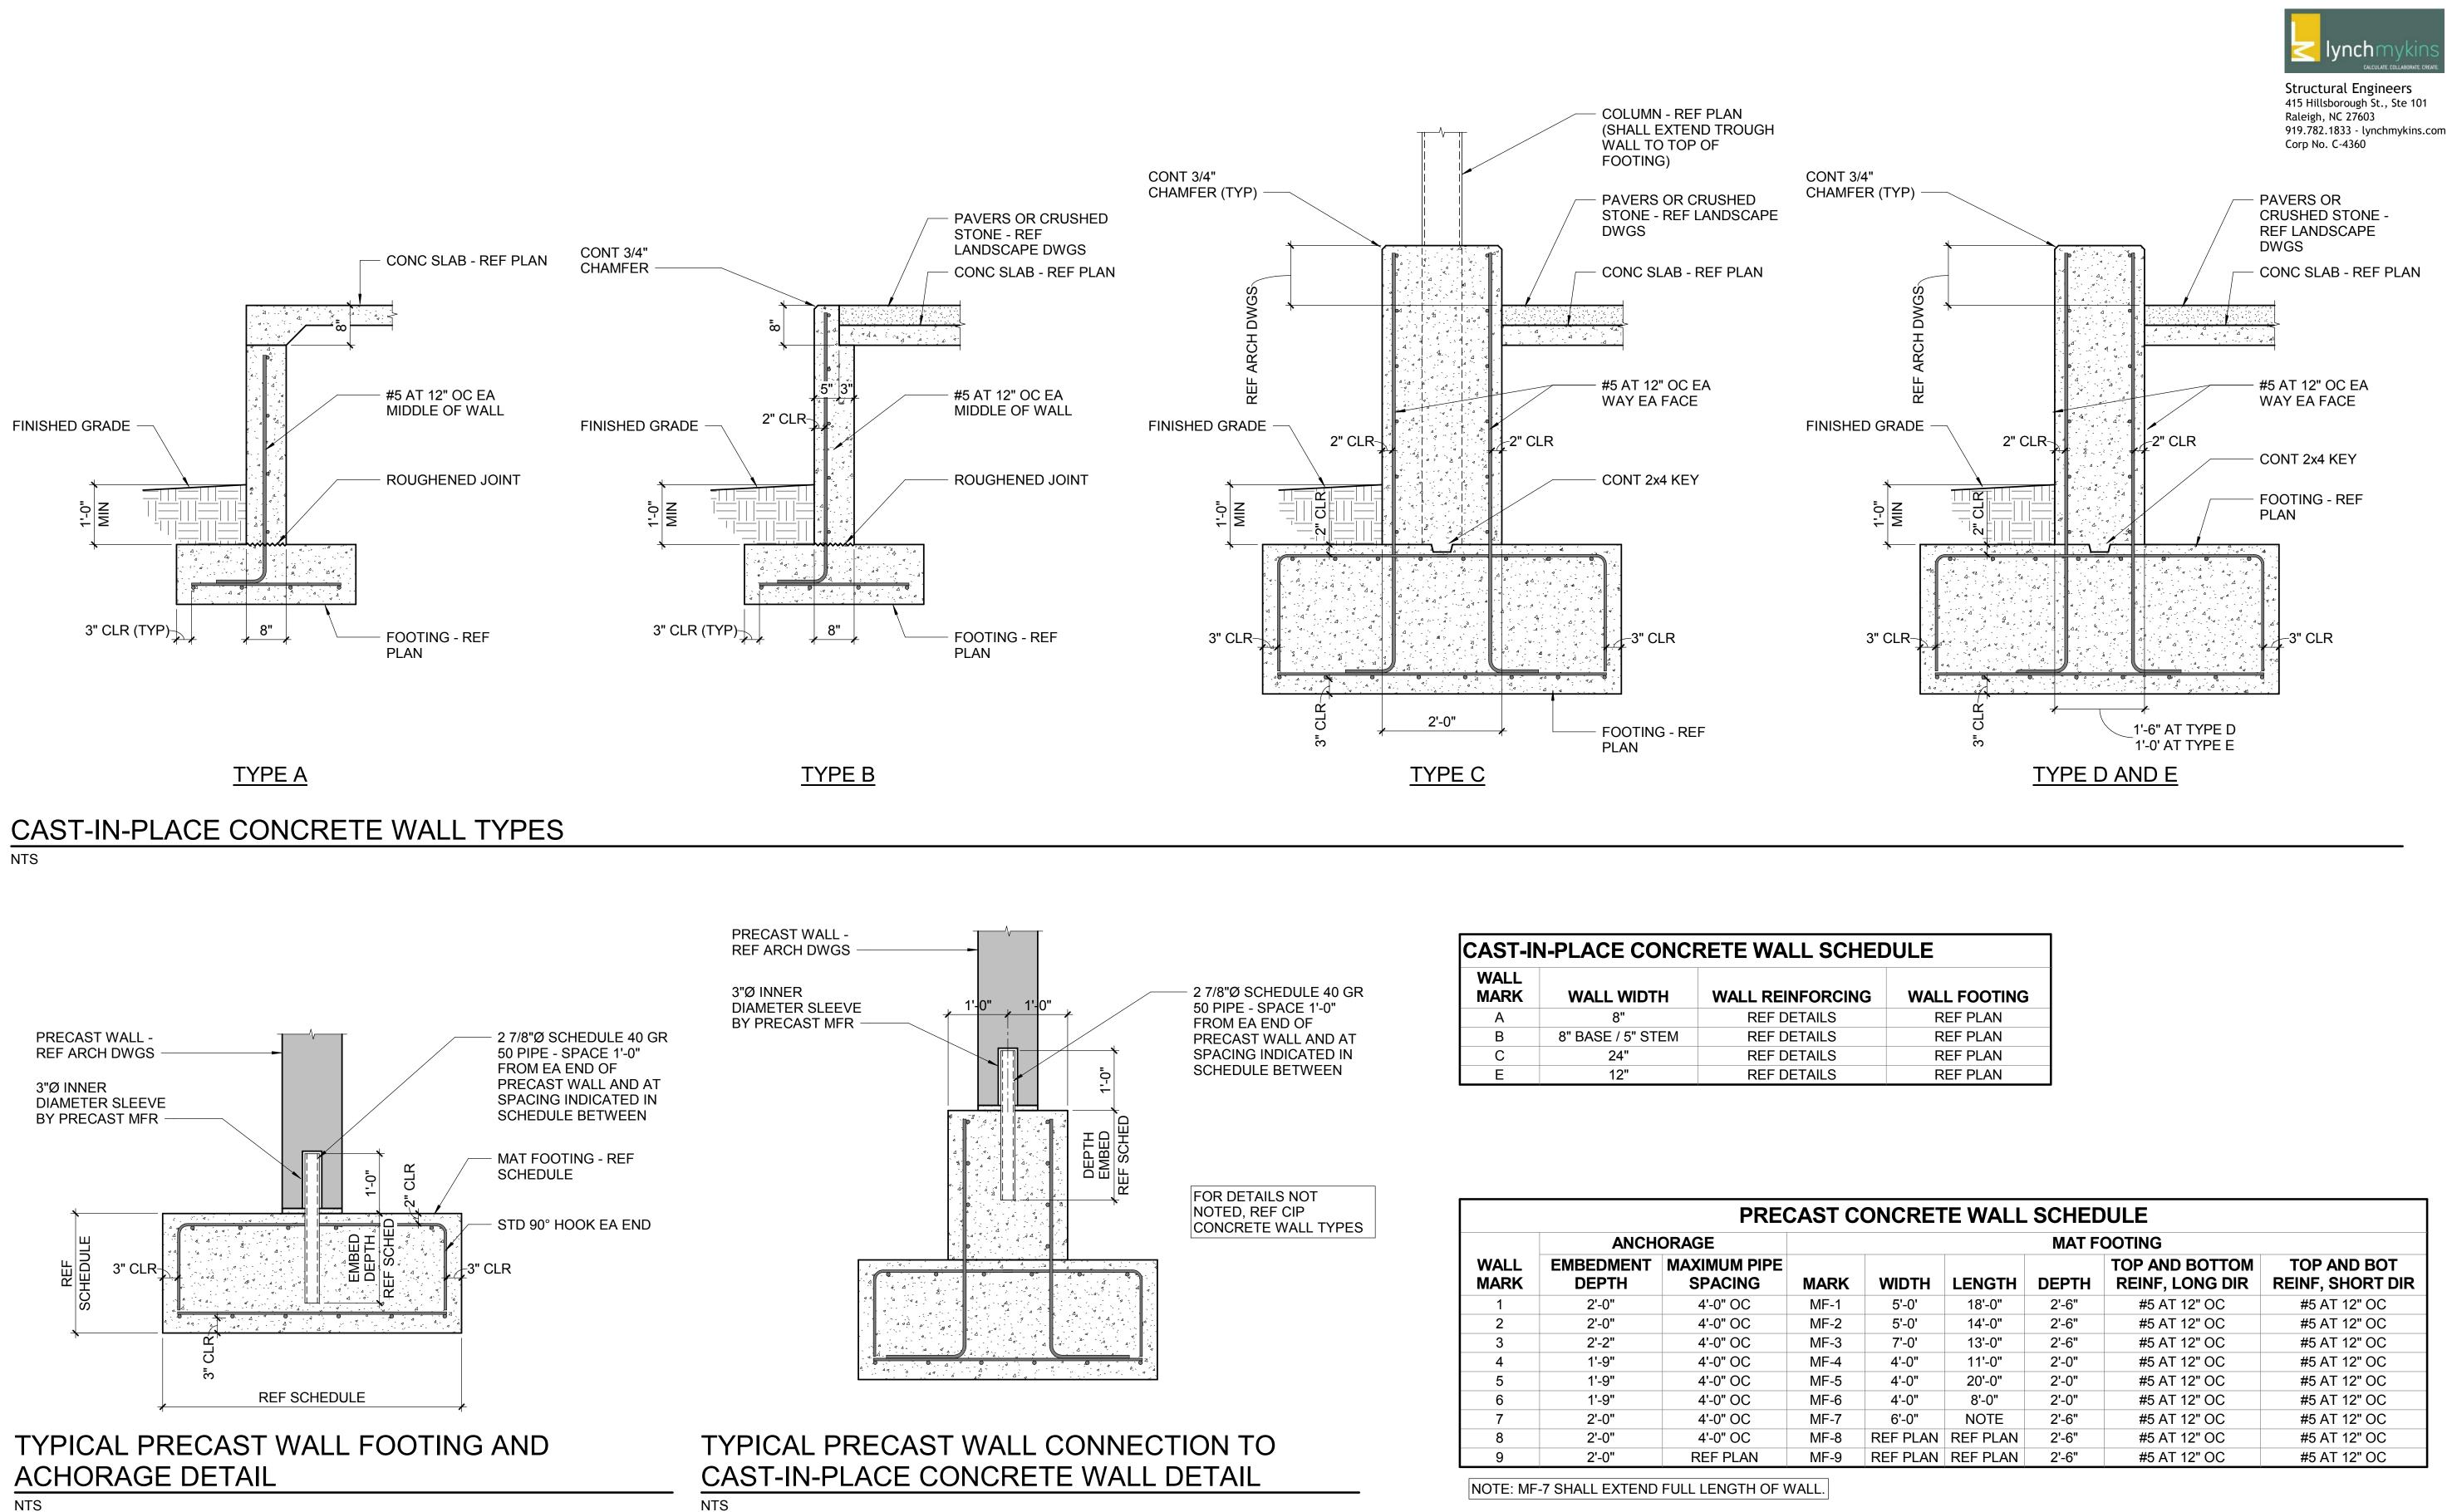
THE EAST GROUP GALLAGHER & ASSOCIATES BREE & ASSOCIATES LIGHT DEFINES FORMS INC ENGINEERING SOURCE



# 

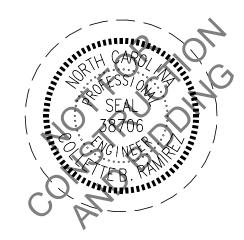DATE:





CAST-IN-PLACE CONCRETE WALL SCHEDULE						
WALL MARK	WALL WIDTH	WALL REINFORCING	WALL			
А	8"	REF DETAILS	RE			
В	8" BASE / 5" STEM	REF DETAILS	RE			
С	24"	REF DETAILS	RE			
E	12"	REF DETAILS	RE			

	PRECAST CONCRETE WALL SCHEDULE							
	ANCHORAGE			MAT FOOTING				
WALL MARK	EMBEDMENT DEPTH	MAXIMUM PIPE SPACING	MARKWIDTHLENGTHDEPTHTOP AND BOTTOMTOP AND BOTMARKWIDTHLENGTHDEPTHREINF, LONG DIRREINF, SHORT DI					
1	2'-0"	4'-0" OC	MF-1	5'-0'	18'-0"	2'-6"	#5 AT 12" OC	#5 AT 12" OC
2	2'-0"	4'-0" OC	MF-2	5'-0'	14'-0"	2'-6"	#5 AT 12" OC	#5 AT 12" OC
3	2'-2"	4'-0" OC	MF-3	7'-0'	13'-0"	2'-6"	#5 AT 12" OC	#5 AT 12" OC
4	1'-9"	4'-0" OC	MF-4	4'-0"	11'-0"	2'-0"	#5 AT 12" OC	#5 AT 12" OC
5	1'-9"	4'-0" OC	MF-5	4'-0"	20'-0"	2'-0"	#5 AT 12" OC	#5 AT 12" OC
6	1'-9"	4'-0" OC	MF-6	4'-0"	8'-0"	2'-0"	#5 AT 12" OC	#5 AT 12" OC
7	2'-0"	4'-0" OC	MF-7	6'-0"	NOTE	2'-6"	#5 AT 12" OC	#5 AT 12" OC
8	2'-0"	4'-0" OC	MF-8	REF PLAN	REF PLAN	2'-6"	#5 AT 12" OC	#5 AT 12" OC
9	2'-0"	REF PLAN	MF-9	REF PLAN	REF PLAN	2'-6"	#5 AT 12" OC	#5 AT 12" OC

90% DESIGN SUBMISSION


#### ADDRESS:

201 W 1ST ST, GREENVILLE, NC 27858 Tel. 252.329.4567

CLIENT:



DESIGN TEAM:

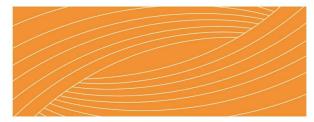


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#### THE EAST GROUP **GALLAGHER & ASSOCIATES** BREE & ASSOCIATES LIGHT DEFINES FORMS INC ENGINEERING SOURCE




# **REVISION:** MARK ISSUE SCALE: SHEET NSTRUCTURAL WALL /


PRECAST WALL DETAILS

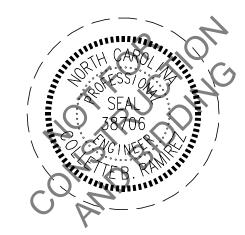SHEET NUMBER:

DATE:



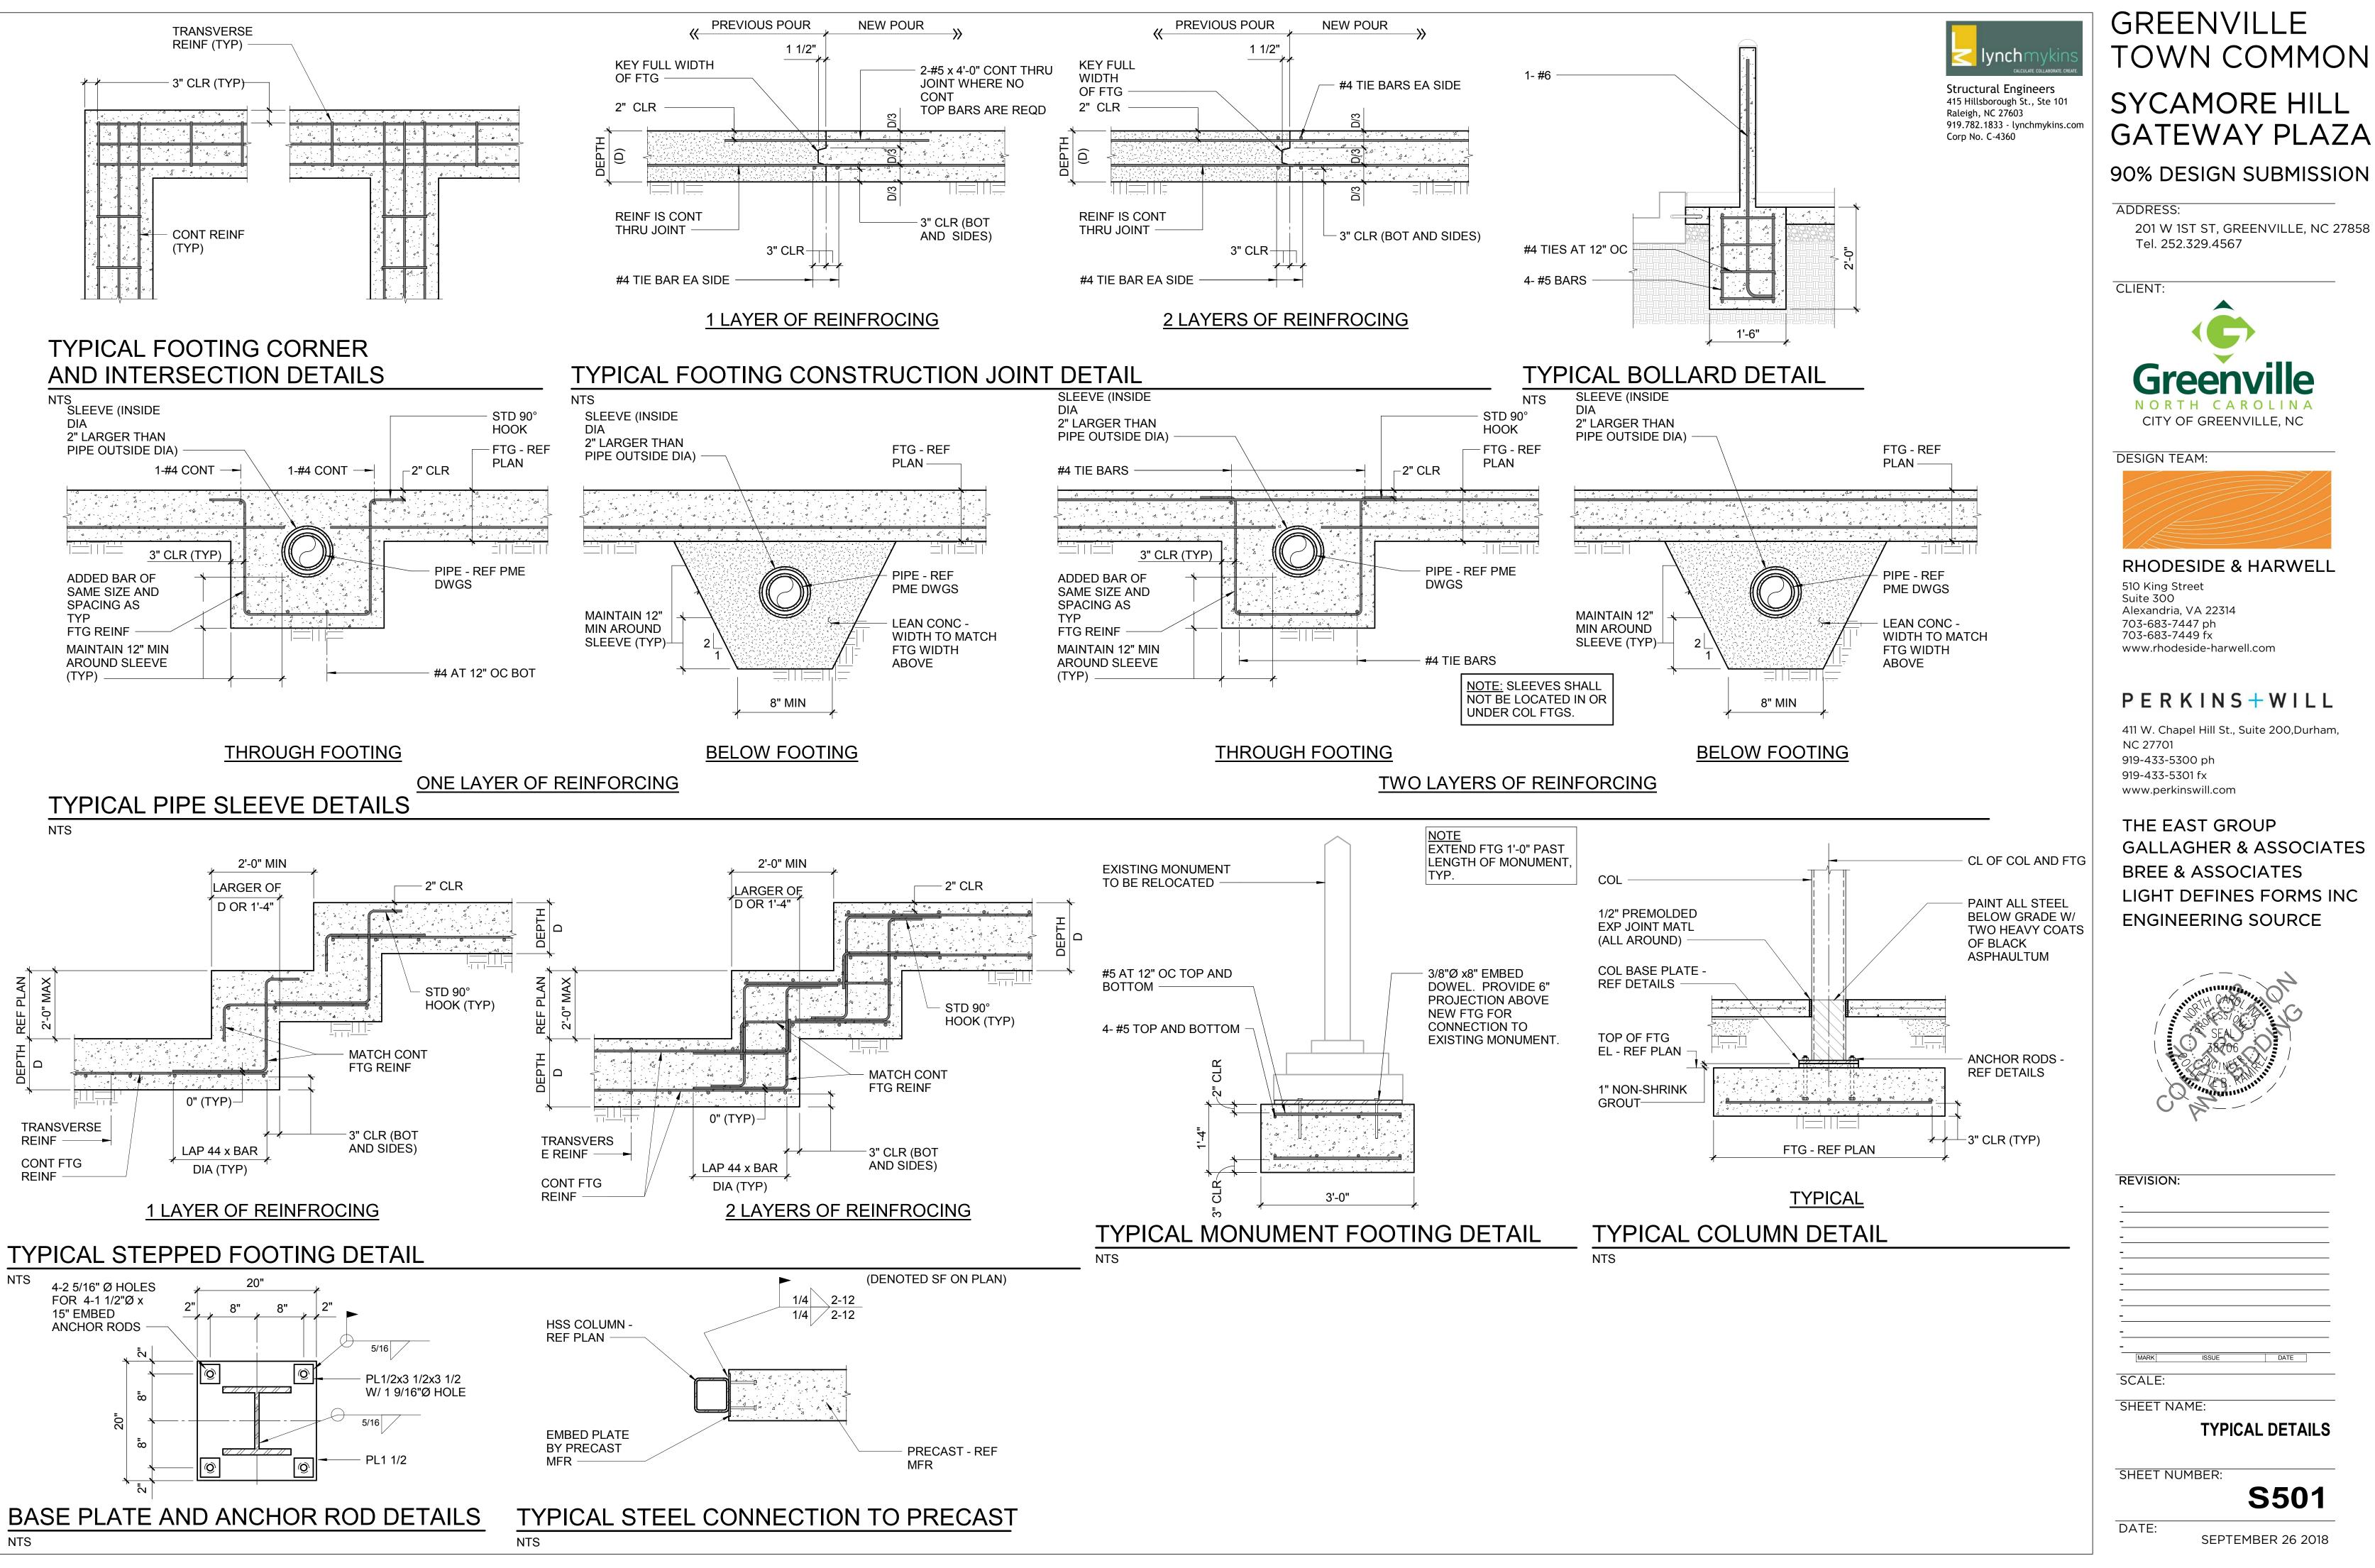

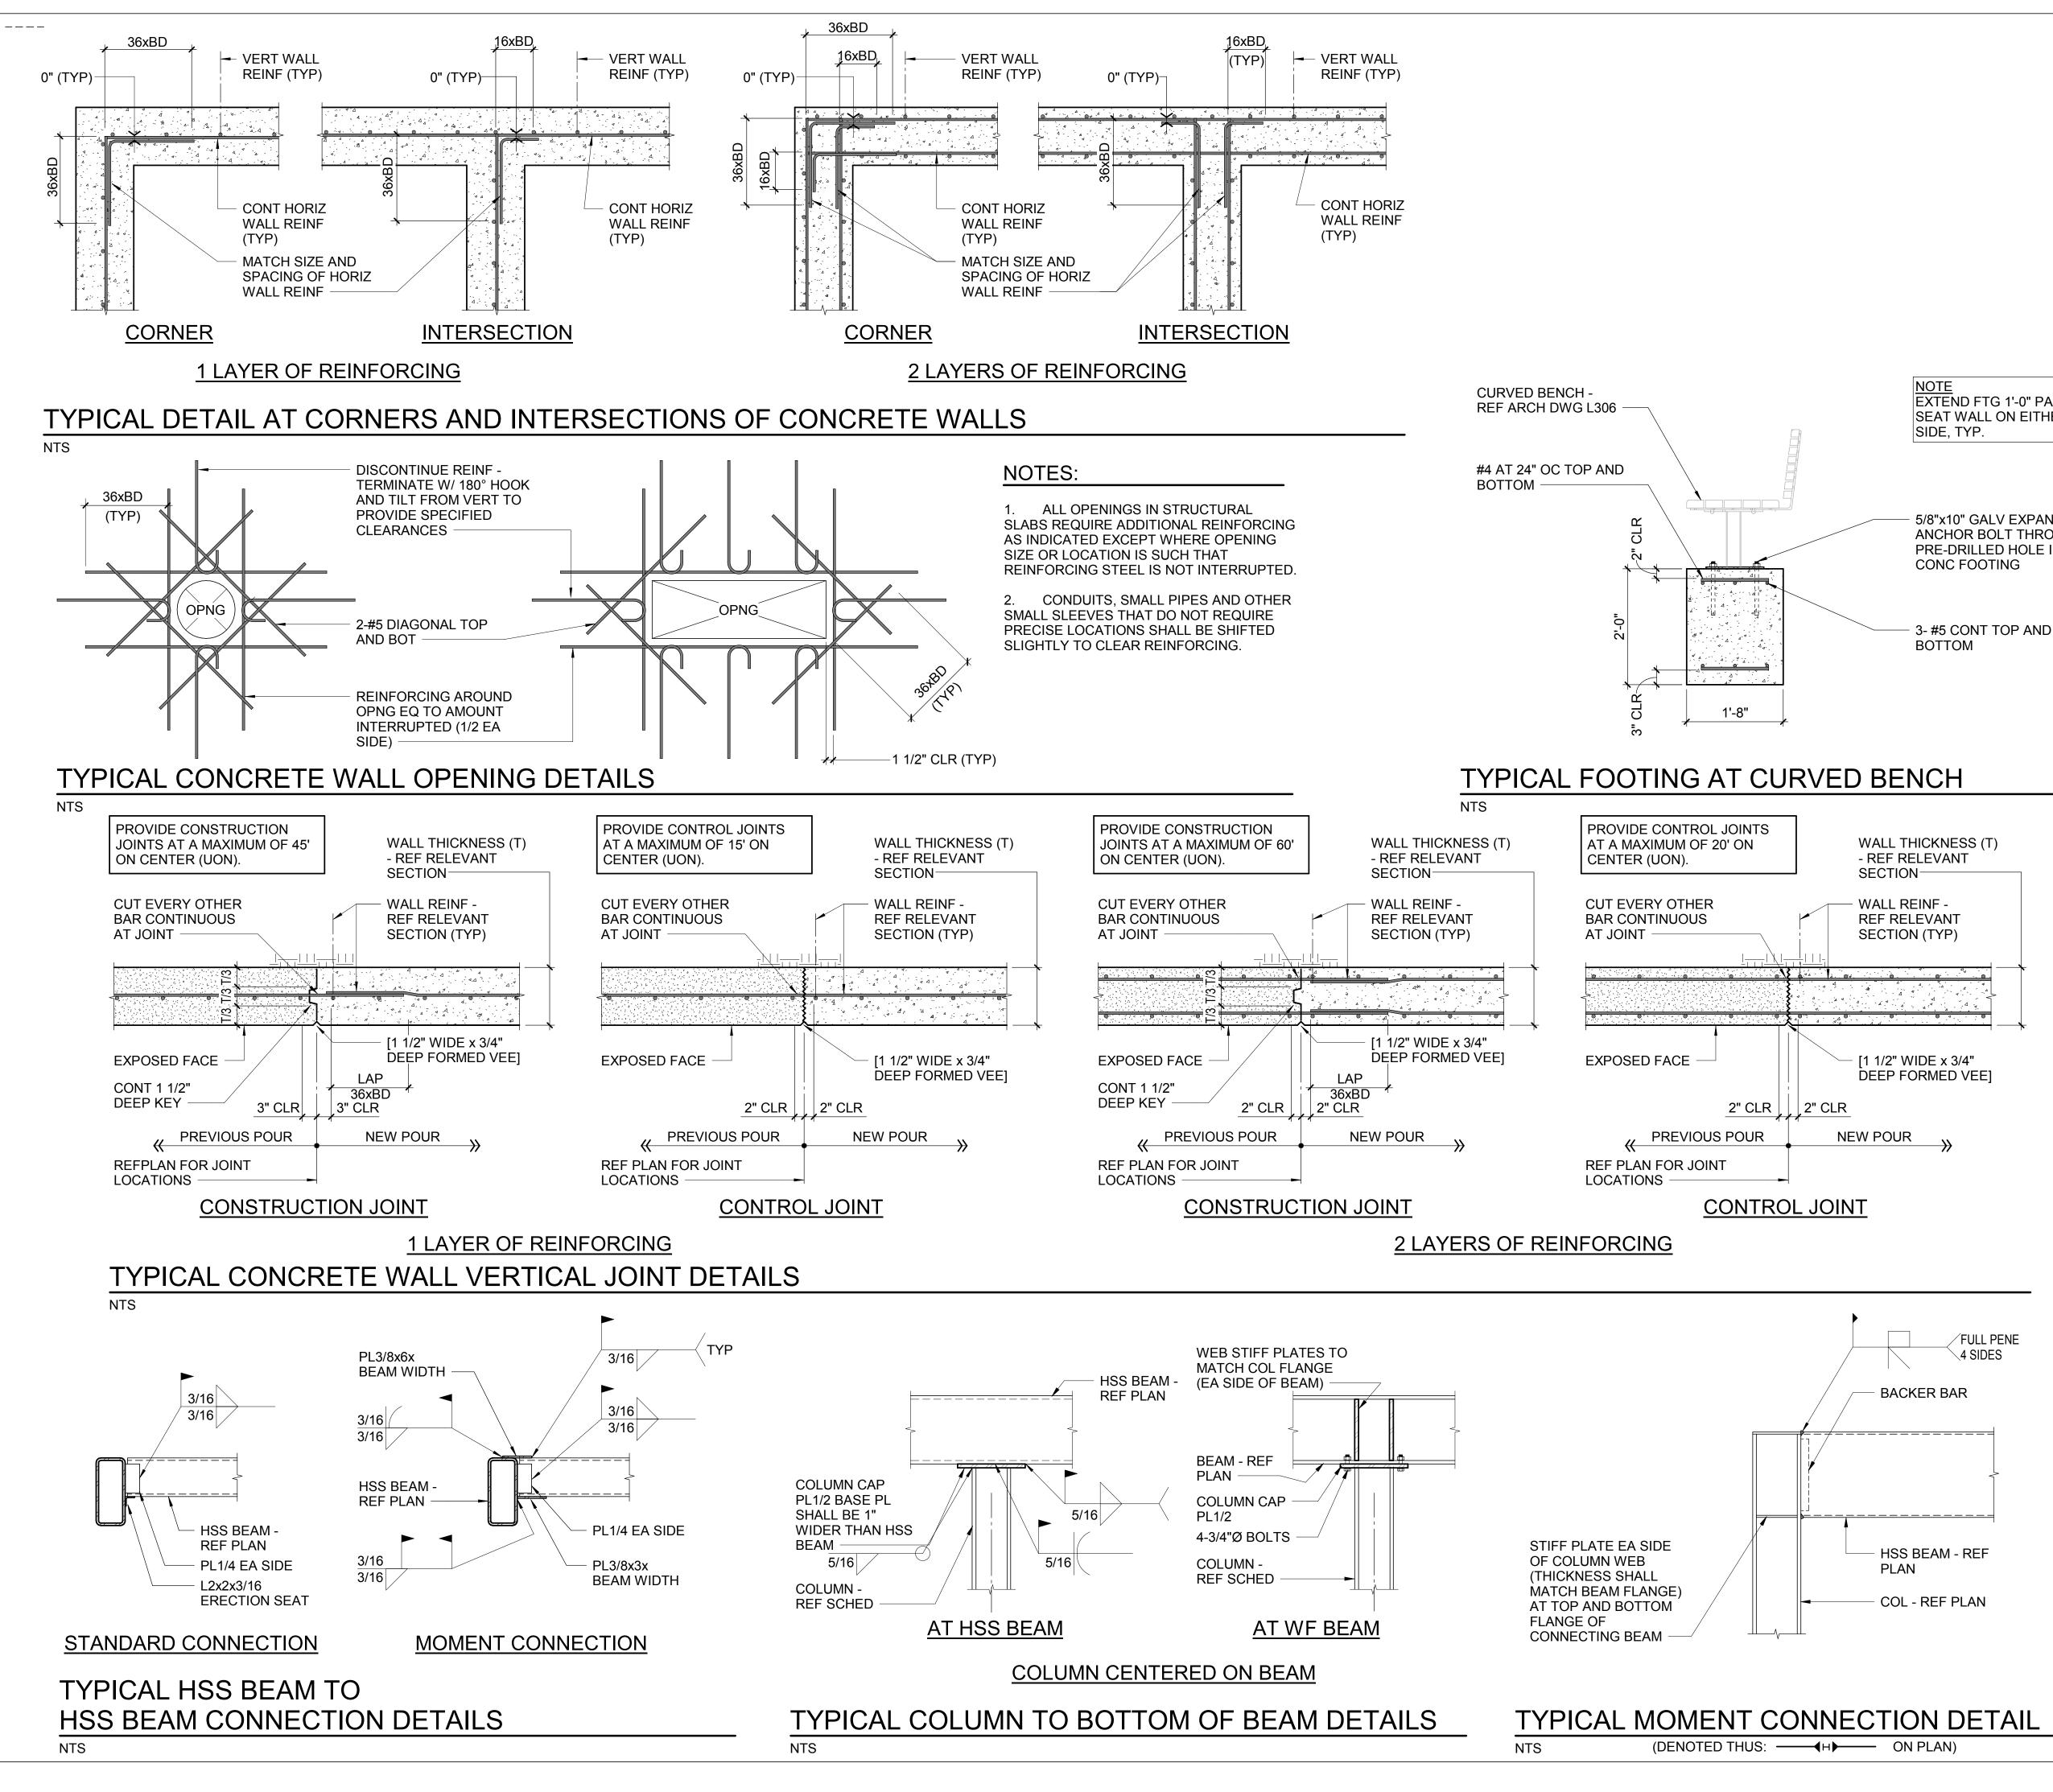



Structural Engineers 415 Hillsborough St., Ste 101 Raleigh, NC 27603 919.782.1833 - lynchmykins.com Corp No. C-4360

## GREENVILLE TOWN COMMON SYCAMORE HILL GATEWAY PLAZA

## 90% DESIGN SUBMISSION


#### ADDRESS:

201 W 1ST ST, GREENVILLE, NC 27858 Tel. 252.329.4567

CLIENT:



#### **DESIGN TEAM:**

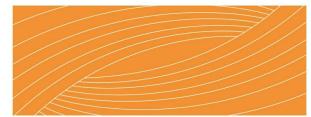


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# **REVISION:** SCALE: SHEET NAME: **TYPICAL DETAILS**

SHEET NUMBER:

DATE:

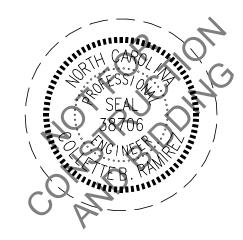

SEPTEMBER 26 2018

EXTEND FTG 1'-0" PAST SEAT WALL ON EITHER

5/8"x10" GALV EXPANSION ANCHOR BOLT THROUGH PRE-DRILLED HOLE IN

#### ELECTRICAL NOTES:

1. DO NOT SCALE THESE DRAWINGS; REFER TO LARGEST SCALE ARCHITECTURAL PLANS.

2. THESE DRAWINGS ARE DIAGRAMMATIC ONLY AND ARE NOT INTENDED TO SHOW MINOR DETAILS AND EXACT LOCATIONS. DESIGN ADJUSTMENTS SHALL BE ANTICIPATED BY THE CONTRACTOR TO PROVIDE A COMPLETE AND OPERATIONAL SYSTEM.

3. ALL WORK SHALL BE PERFORMED IN STRICT ACCORDANCE WITH CURRENT NEC/NFPA 70. CONTRACTOR SHALL NOTIFY ENGINEER REGARDING ANY CODE DISCREPANCIES SHOWN ON PLAN. ANY PERMIT OR INSPECTION FEES ARE THE RESPONSIBILITY OF THE ELECTRICAL CONTRACTOR.

4. CONTRACTOR SHALL INSTALL, GROUND AND BOND SYSTEM PER THE CURRENT NEC.

5. E.C. IS RESPONSIBLE FOR FIELD VERIFYING EXACT CONDUIT ROUTING WITH EXISTING SITE CONDITIONS. AVOID EXISTING TREES AND BUSHES. KEEP TRENCHING FAR ENOUGH AWAY FROM EXISTING TREES TO PREVENT CUTTING MAJOR ROOT SYSTEMS.

6. MINIMUM WIRE SIZE SHALL BE #12 AWG., MINIMUM CONDUIT SIZE SHALL BE 1".

7. CONDUCTORS SHALL BE TYPE THHN, THWN, OR THW. BRANCH CIRCUIT CONDUCTOR SHALL NOT BE SMALLER THAN No. 12 AWG., EXCEPT WHERE SPECIFICALLY NOTED OTHERWISE. HOME RUNS ORIGINATING MORE THAN 80' AT 120V FROM PANEL LOCATION SHALL BE No. 10 AWG MINIMUM SIZE. WIRES No. 10 AWG AND SMALLER SHALL BE SOLID; WIRES No. 8 AWG AND LARGER SHALL BE STRANDED. PROVISIONS OF SECTION 210-5 COLOR CODE, NEC, SHALL BE STRICTLY COMPLIED WITH AND BE CONSISTENT THROUGHOUT ENTIRE SYSTEM.

8. ALL CIRCUITS SHALL BE PROVIDED WITH AN INSULATED EQUIPMENT GROUND CONDUCTOR SIZED IN ACCORDANCE WITH CURRENT NEC TABLE 250-122. HASHMARK FOR GROUNDING CONDUCTOR IS NOT INDICATED ON THESE DRAWINGS. RACEWAY SHALL NOT BE USED AS EQUIPMENT GROUND.

9. ALL EMPTY CONDUIT SHALL HAVE A PULL STRING/WIRE.

10. SERVICE ENTRANCE CONDUCTORS SHALL BE IN CONDUIT (RIGID OR PVC). EXTERIOR CONDUIT EXPOSED ABOVE SLAB SHALL BE RIGID. ALL UNDERGROUND CONDUIT SHALL BE UL LISTED SCHD 40 PVC CONFORMING TO ARTICLES 352 & 300 OF THE NEC. WHERE SCHD 40 PVC IS INSTALLED BELOW GRADE OR UNDER CONC SLABS, THE ELBOWS REQUIRED TO TURN THE RACEWAY UP INTO CABINETS, EQUIPMENT, ETC., SHALL BE OF RIGID STEEL AND SHALL CONTINUE AS RIGID STEEL TO THE CABINET, EQUIPMENT, ETC. ALL BRANCH AND FEEDER CIRCUITS SHALL BE IN CONDUIT.

11. ALL JUNCTION OR DEVICE BOXES SHALL HAVE A COVER.

12. ALL 1P-20A CIRCUITS SHALL BE IN 1" CONDUIT U.N.O. USE SCH. 40 PVC BELOW GRADE.

13. ALL ELECTRICAL WORK SHALL BE IN ACCORDANCE WITH ALL VOLUMES OF THE NCSBC, INSPECTORS HAVING JURISDICTION, AND ALL OTHER APPLICABLE CODES AND ORDINANCES.

14. EACH PIECE OF ELECTRICAL GEAR, EQUIPMENT, ETC., SHALL BEAR A "UL" LABEL.

15. INSTALL ENGRAVED PHENOLIC LABELS ON ALL ELECTRICAL GEAR, DISCONNECTS, ETC. FASTEN WITH SCREW FASTENERS.


16. E.C. SHALL INSTALL NEMA-3R PROTECTED EQUIPMENT/DEVICES AT ALL EXTERIOR LOCATIONS INDICATED ON THESE DRAWINGS.

17. VERIFY LOCATION/TYPE OF ALL FIXTURES, PANEL BOXES, OUTLET PLACEMENT, ETC. BY HOLDING AN ELECTRICAL WALK THROUGH ON THE SITE ONCE GRADING IS COMPLETE.

18. E.C. SHALL INSTALL COMPLY WITH ANSI A117.1 FOR OUTLET AND CONTROL SWITCH MOUNTING HEIGHTS FOR ADA ACCESSIBILITY.

19. ELECTRICIAN SHALL VERIFY VOLTAGE DROP WITH ACTUAL CONDUIT ROUTING LENGTHS PRIOR TO PULLING CONDUCTORS. FOR 1P-20A CIRCUITS (1,000W MAX. LOAD) USE #12 WIRE UP TO 100'-0", #10 WIRE UP TO 200'-0" AND #8 WIRE UP TO 300'-0.

<ul> <li>ELECTRICAL RISER NOTES:</li> <li> <ol> <li>NEW U/G SERVICE ENTRANCE. SEE PLAN FOR MORE INFORMATION.         </li> </ol> </li> <li>SET PANEL STAND AND GROUND SERVICE ENTRANCE PER GROUNDING DETAIL THIS SHEET. VERIFY TRANSFORMER AND PANEL LOCATION WITH ARCHITECTURAL AND CIVIL SITE PLANS         <ol> <li>2-#3 &amp; 1#8G in 1.25"C</li> </ol> </li> </ul>		SET ANCHOR BOLTS AS PER MFR'S TEMPLATE BOND GROUND TO POLE GROUT
NEW TRANSFORMER AND METER BASE BY E.C.     WEATHERPROOF/GFI DUPLEX OUTLET. SEE PANEL     SCHEDULE AND PANEL STAND DETAIL.      NEW SERVICE     TRANSFORMER AND     METER      O     O	"S" 100A ECB NEMA-3R (2) 240V 1ø, 3W	(6) NO. 4 BARS VERTICAL AND NO. 3 BARS HORIZ @ 12" O.C SCHD 40 PVC CONDUIT; NO. & SIZE AS REQ'D PER PLAN COPPER EQUIPMENT GROUND CONDUCTOR ATTACHED TO INTERNAL LUG WELDED TO INTERIOR OF POLE. GROUND CONDUCTOR SHALL BE SAME SIZE AND TYPE AS SUPPLY CONDUCTOR.
TO EXIST. UTIL. SERVICE MANHOLE IN 1ST STREET SEE PLAN FOR LOCATION TO SCALE: N.T.S.	R	CONCRETE AS SPECIFIED

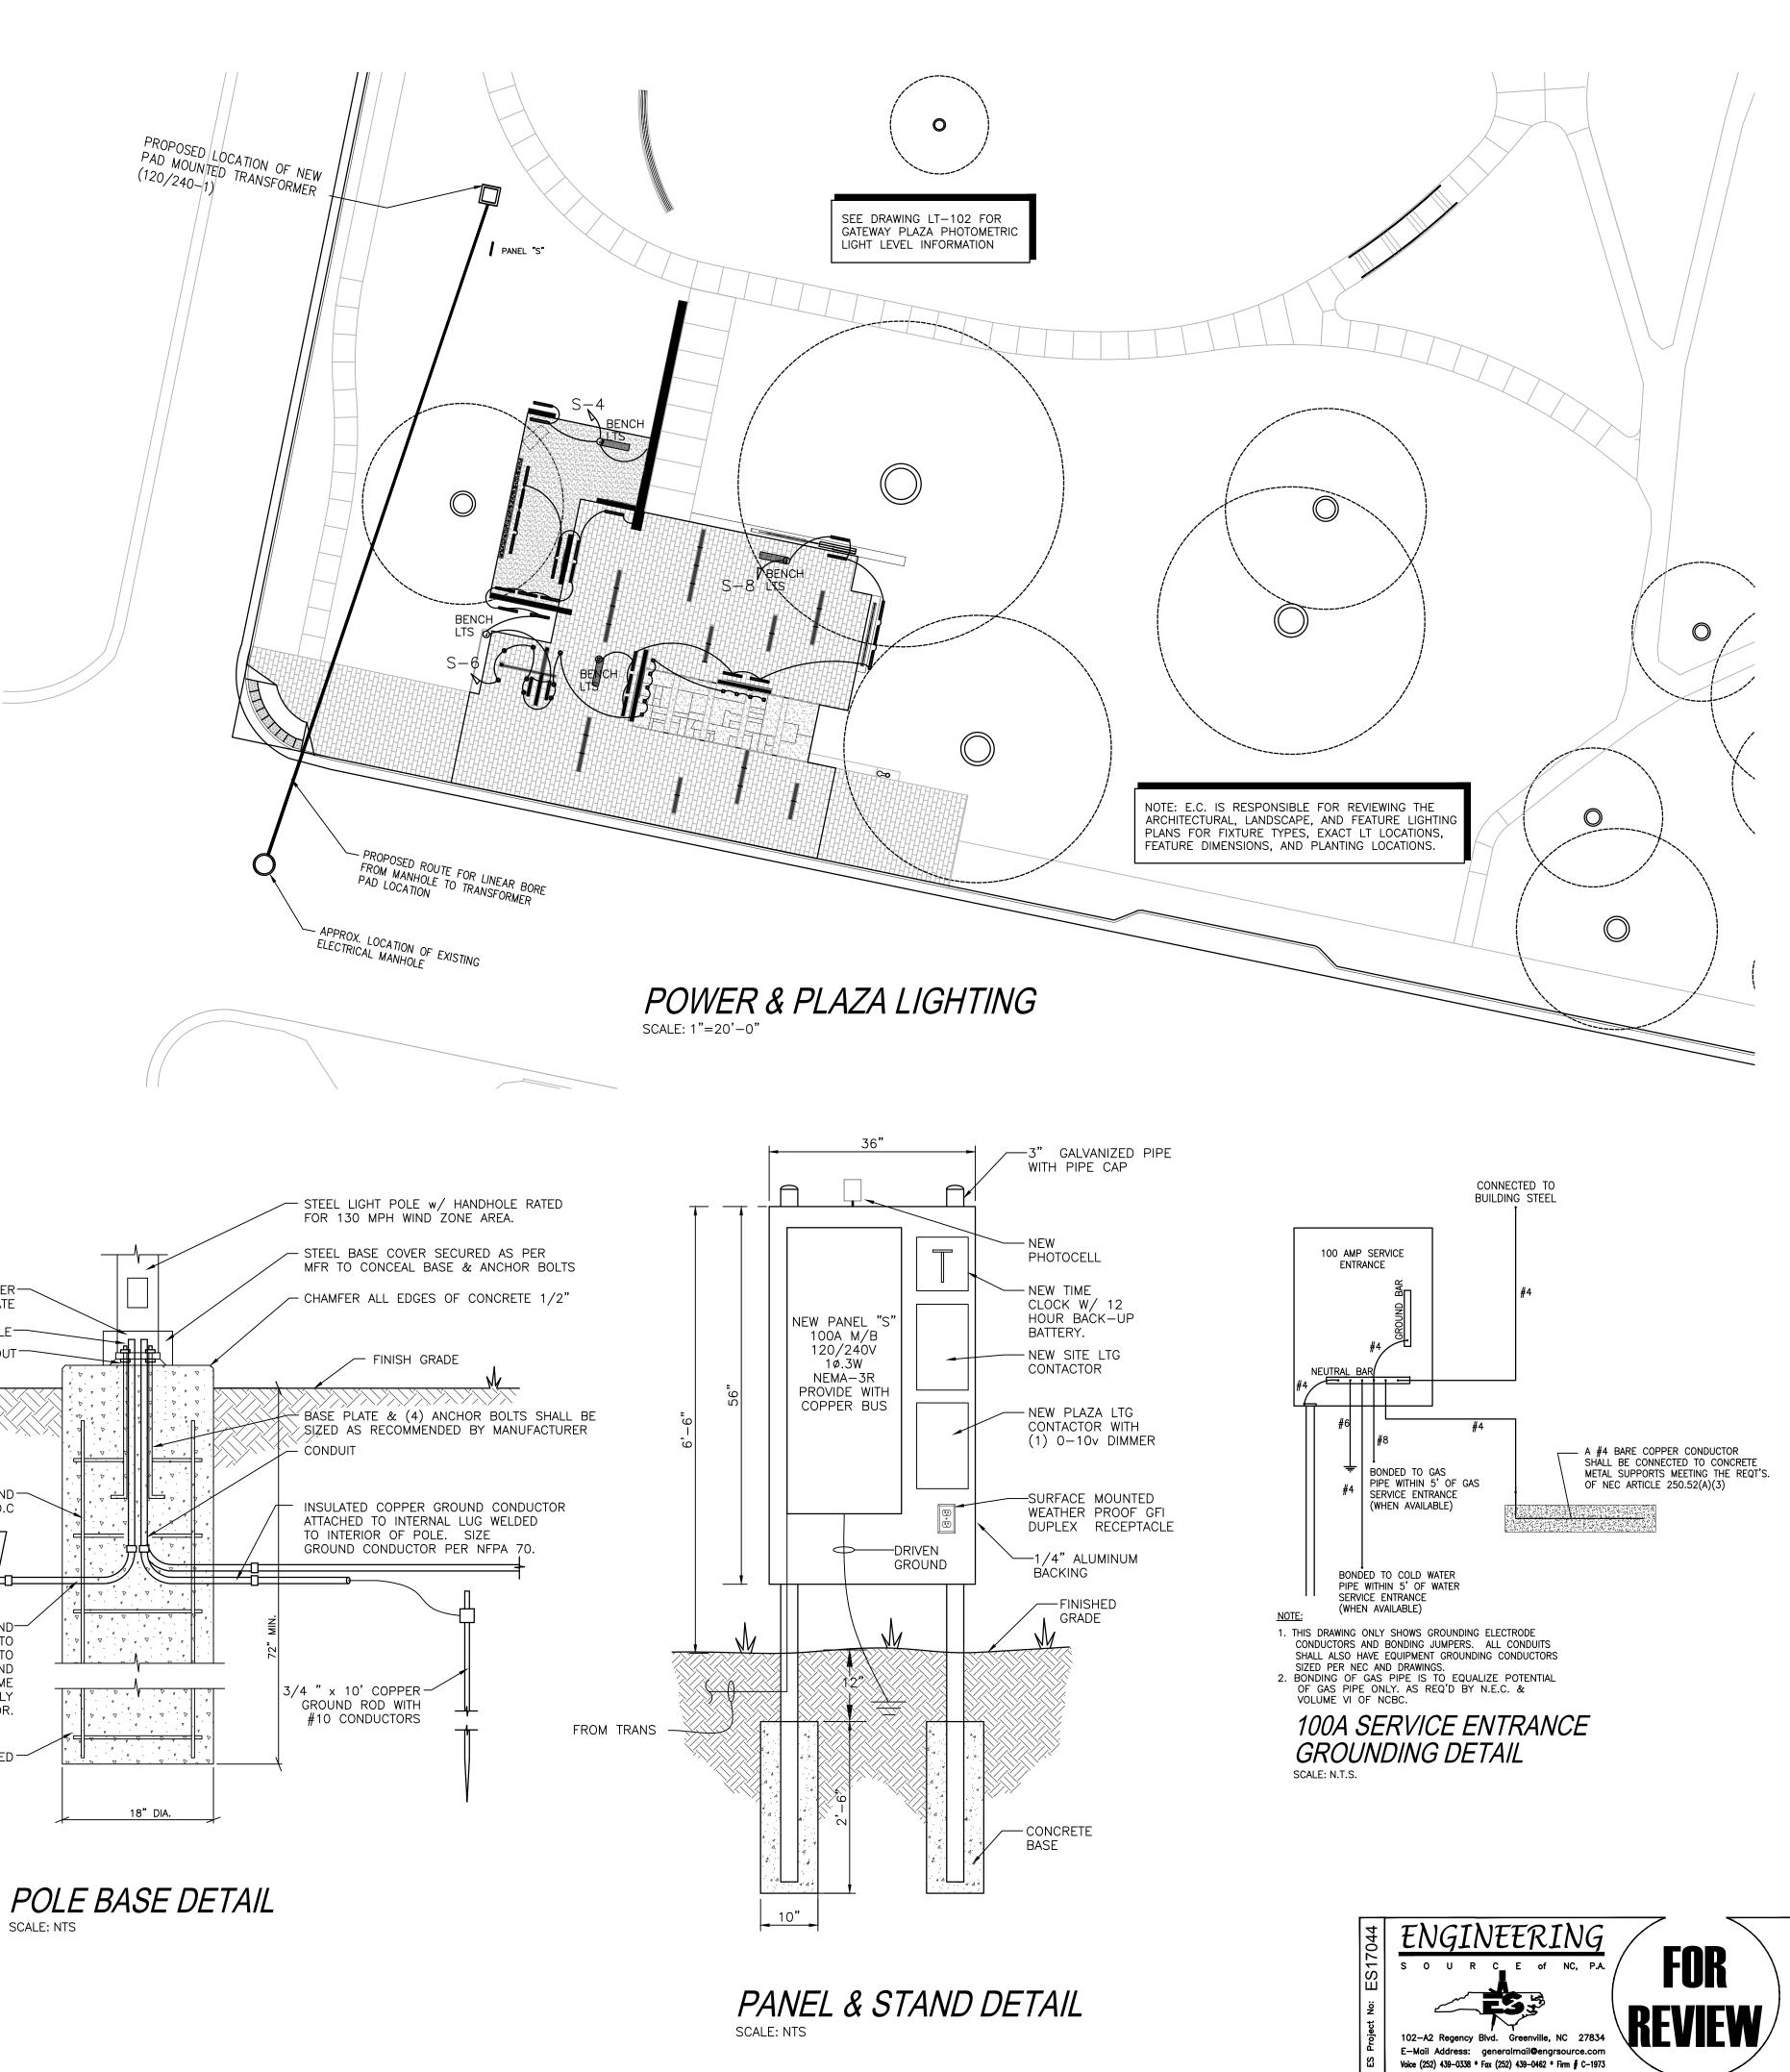

# GREENVILLE TOWN COMMON SYCAMORE HILL **GATEWAY PLAZA**

90% DESIGN SUBMISSION


#### ADDRESS:

201 W 1ST ST, GREENVILLE, NC 27858 Tel. 252.329.4567

**OWNER:** 



DESIGN TEAM:

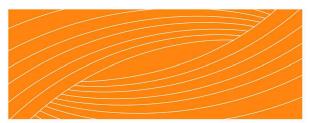

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THE EAST GROUP GALLAGHER & ASSOCIATES **BREE & ASSOCIATES** LIGHT DEFINES FORMS INC ENGINEERING SOURCE

**REVISION:** 

SCALE:

SEE PLAN

SHEET NAME: **POWER & PLAZA LTG PLAN** 

SHEET NUMBER:




**GATEWAY PLAZA** 


TYPE	DESCRIPTION	LAMPS	VOLTS	WATTS	B.F.
S1	POLE MOUNTED LED DARK SKY APPROVED @ $16'-0''$ HEIGHT. TYPE 2 DISTRIBUTION PATTERN, & 3000K DIODES. PROVIDE SELUX QUADRO H2 LED PEDESTRIAN LIGHT MODEL: QH2L-R2-1-5G350-30 OR APPROVED EQUAL. (COLOR BY ARCHITECT)	LED	MVOLT	35W	-
S2	POLE MOUNTED LED DARK SKY APPROVED @ 16'-0" HEIGHT. TYPE 3 DISTRIBUTION PATTERN, & 3000K DIODES. PROVIDE SELUX QUADRO H2 LED PEDESTRIAN LIGHT MODEL: QH2L-R3-1-5G530-30 OR APPROVED EQUAL. (COLOR BY ARCHITECT)	LED	MVOLT	49W	-
S3	POLE MOUNTED LED DARK SKY APPROVED @ 16'-0" HEIGHT. TYPE 5 DISTRIBUTION PATTERN, & 3000K DIODES. PROVIDE SELUX QUADRO H2 LED PEDESTRIAN LIGHT MODEL: QH2L-R5-1-5G530-30 OR APPROVED EQUAL. (COLOR BY ARCHITECT)	LED	MVOLT	49W	-

"S" D	EM	ANI	) (
LIG H TIN G	3.10	KVAX	125
RECEPTAC TOTAL 1ST REMAIN	10.00		
M O TO R S	0.00	KVAX	100
A /C	0.00	KVAX	100
H E A T IN G	0.00	KVAX	100
FUTURE		KVAX	100
K ITC H E N	0.00	KVAX	<mark>6</mark> 5
MISCELLANEOUS	0.90	KVAX	100
TO TA L =	22.4	amps	


PANELBOARD SCHEDULE - 'S'													$\neg$													
MAI	MAIN: 100A MCB VOLTAGE 240/120 PHASE: 1 WIRE: 3 MOUNTING: SURFACE AIC: 10,000 NOTES: COPPER BUS, BTM FED																									
CKT	BKR	POLE	W IR E	COND				LO	AD (K	VA)			PHAS	Ę		LO	AD (K		The second second			COND		POLE	BKR	CKT
#	TR IP		SIZE	SIZE	D E S C R IP TIO N	LTG	REC	MTR	A /C	HTG	KIT	M IS C	AB	LTG	REC	MTR	AA	HTG	KIT	MISC	DESCRIPTION	SIZE	SIZE		TR IP	#
1	20	1	12	3 /4"	SITE LTG CONTACTOR							0.3			0.6						EXTERIOR RECEPTS	1"	12	1	20	2
3	20	1	10	1"	WALKING PATH LTS	0.3								0.8							PLAZA LTS	1"	10	1	20	4
5	20	1	10	1"	WALKING PATH LTS	0.3								0.6							PLAZA GROUND LTS	1"	10	1	20	6
7	20	1	8	1"	POLE LIGHTS @ STREET	0.3								0.8							PLAZA LTS	1"	10	1	20	8
9	20	1	12	3 /4"	PLAZA LTG CONTACTOR							0.3								0.3	PLAZA LTG CONTROLS	3 /4"	12	1	20	10
11	20	1			SPARE																SPARE			1	20	12
13	20	1			SPARE																SPARE			1	20	14
15	20	1			SPARE																SPARE 1		1	20	16	
17	20	1			SPARE																SPARE 1		20	18		
19	20	1			SPARE																SPARE			1	20	20
21		1			SPACE																SPACE			1		22
23		1			SPACE																SPACE			1		24
25		1			SPACE																SPACE			1		26
27		1			SPACE																SPACE			1		28
29		1			SPACE																SPACE			1		30
L IG H	TING (K	V A ):			3.1	0.9	0.0	0.0	0.0	0.0	0.0	0.6		2.2	0.6	0.0	0.0	0.0	0.0	0.3	CONNECTED LOAD (KV)	A):				1.6
	EPTACL	<b>(</b>	( A ):		0.6																DEMAND LOAD (KVA): 5.4				.4	
	ORS (K)	/ A ):			0.0	PHASE A																				
A .C (K V A): 0.0										PHAS	EB	A 1044	2.2 18.3							CONNECTED LOAD (AMPS): 19.2						
	TING (K)				0.0								KVA	A	<b>NPS</b>						DEMAND LOAD (AMPS):				2	2.4
	HEN (K)				0.0																					
IN IS C	ELLANE	- 0 U S (	(KVA):		0.9	1																				

NOTE: NEMA-3R LOCKABLE ENCLOSURE

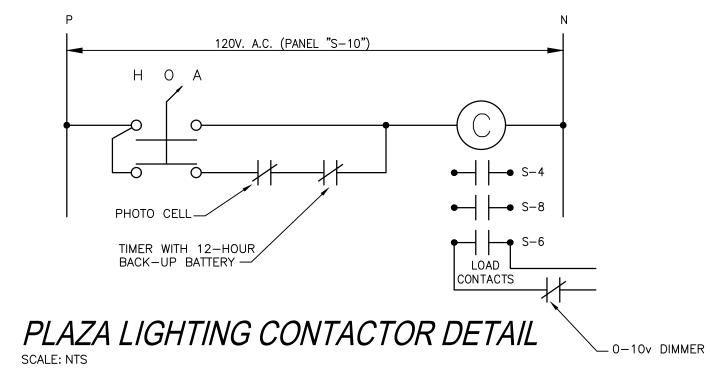

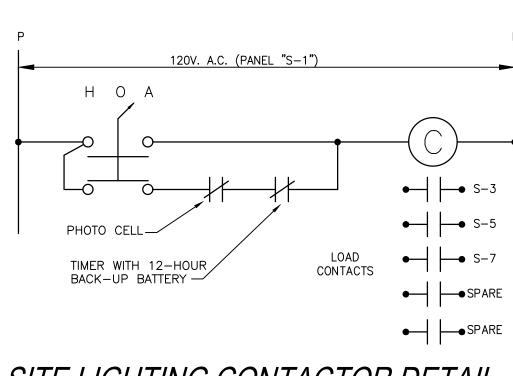

SITE LIGHTING CONTACTOR DETAIL SCALE: NTS

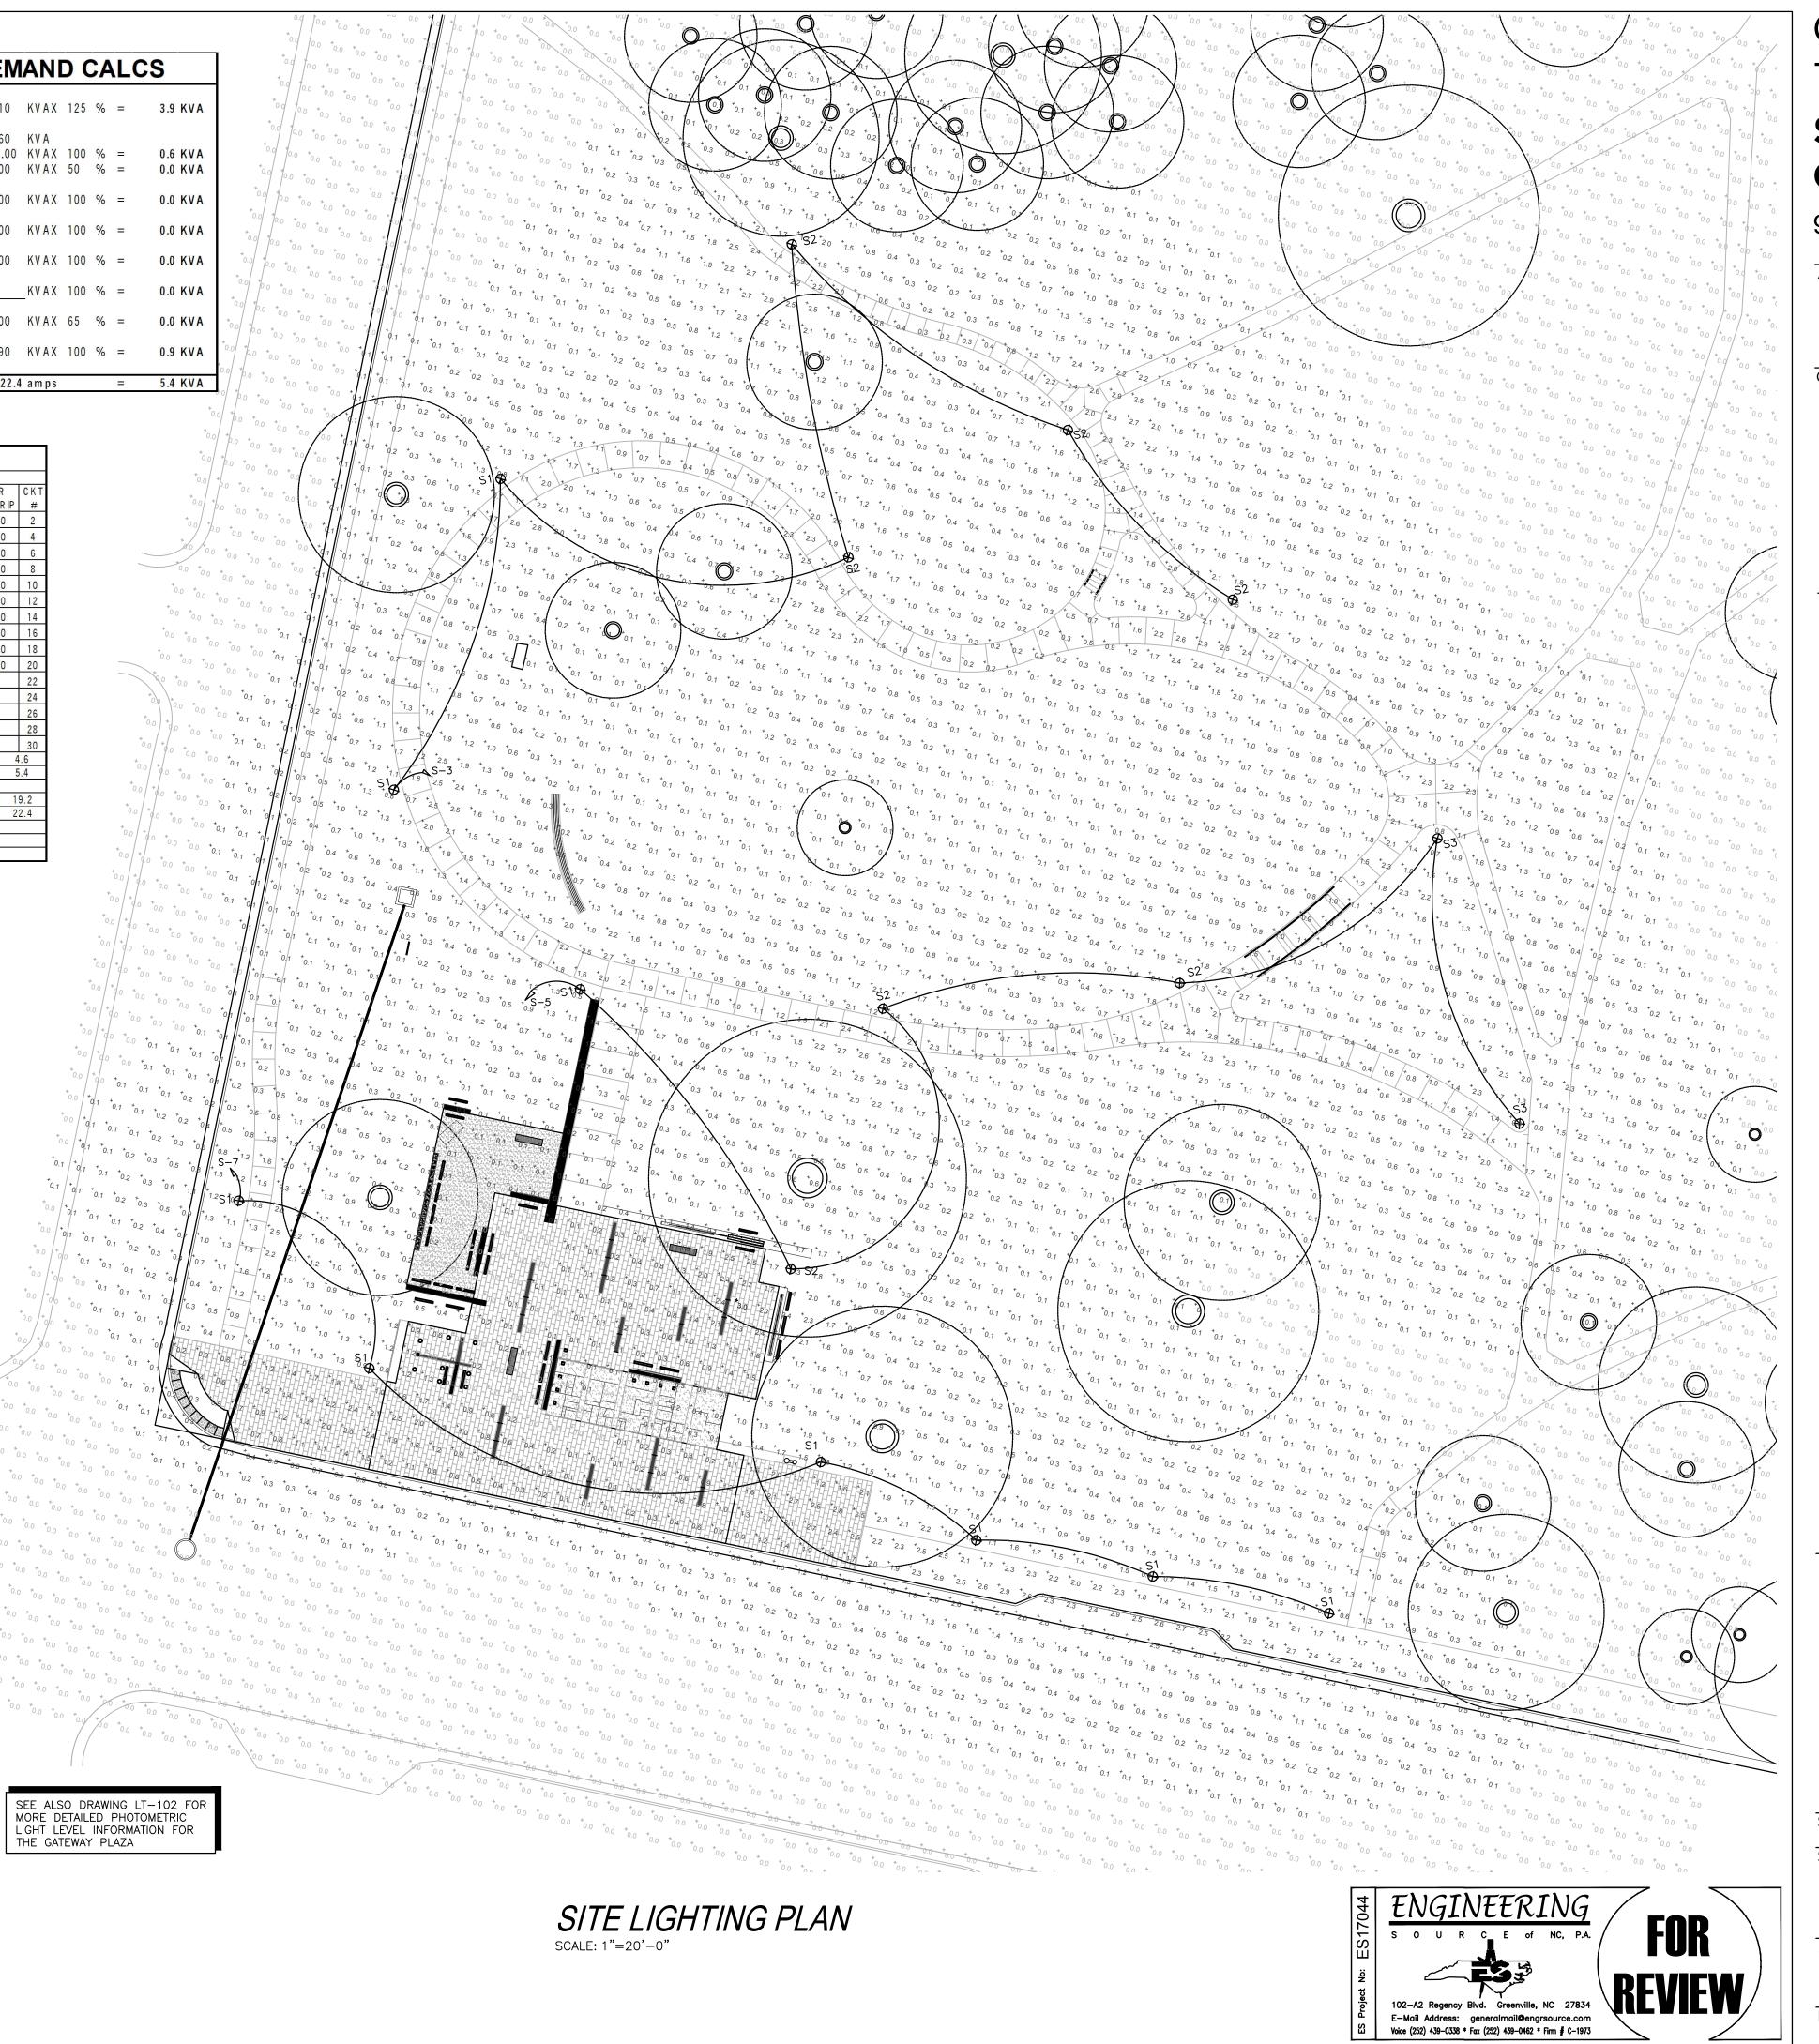



# GREENVILLE TOWN COMMON SYCAMORE HILL **GATEWAY PLAZA**

#### 90% DESIGN SUBMISSION


#### ADDRESS:

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OWNER:



DESIGN TEAM:

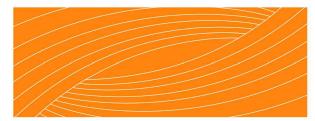

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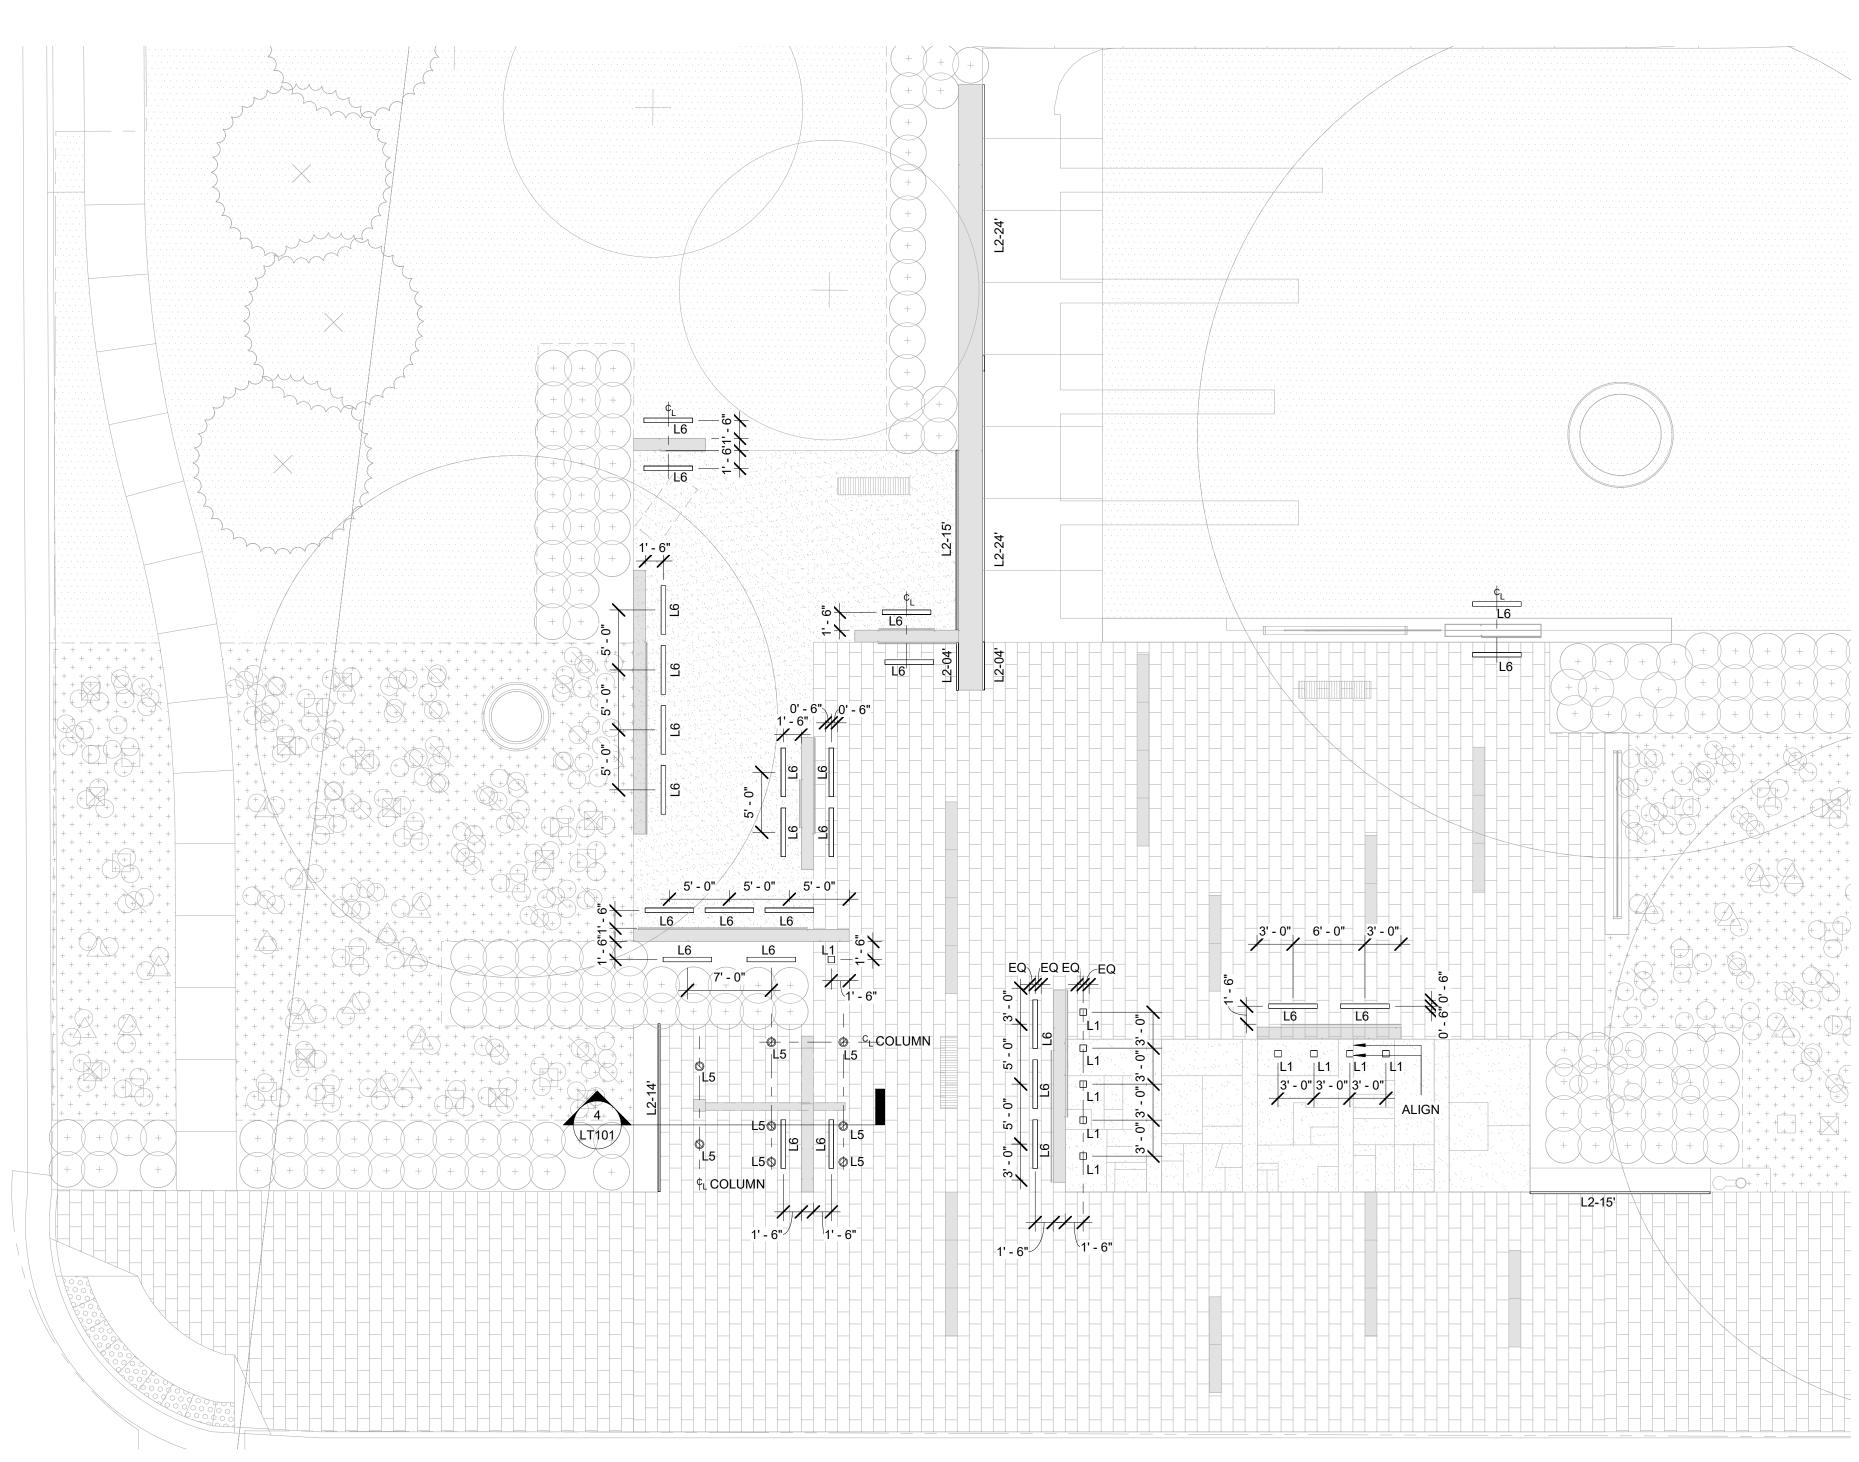
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THE EAST GROUP GALLAGHER & ASSOCIATES **BREE & ASSOCIATES** LIGHT DEFINES FORMS INC ENGINEERING SOURCE

**REVISION:** 

SCALE:	SEE PLAN
SHEET NAME:	GATEWAY PLAZA SITE LIGHTING PLAN
SHEET NUMBER	E-102
DATE:	SEDTEMPED 26 2019



<sup>1</sup> IN-GRADE LIGHTING LAYOUT 1/8" = 1'-0"


		LIGHT	TING FIXTURE SCHEDULE			
TYPE	DESCRIPTION	BASIS OF DESIGN MANUFACTURER	MODEL	LIGHT SOURCE	ESTIMATED LOAD CONTROL INTENT	LOAD TYPE
L1	RECESSED LED 6" SQUARE INGRADE UPLIGHT - WASH	BEGA	77023	INTEGRAL LED 3000K	11 VA SUNSET TO SUNRISE	0-10V LED
L2-04'	RECESSED LINEAR LED RIBBON LIGHT - IP68 RATED WARM WHITE	ACOLYTE	NL-67-24-30-B	INTEGRAL LED 3000K	12 VA SUNSET TO SUNRISE	NON-DIM
L2-14'	RECESSED LINEAR LED RIBBON LIGHT - IP68 RATED WARM WHITE	ACOLYTE	NL-67-24-30-B	INTEGRAL LED 3000K	42 VA SUNSET TO SUNRISE	NON-DIM
L2-15'	RECESSED LINEAR LED RIBBON LIGHT - IP68 RATED WARM WHITE	ACOLYTE	NL-67-24-30-B	INTEGRAL LED 3000K	45 VA SUNSET TO SUNRISE	NON-DIM
L2-24'	RECESSED LINEAR LED RIBBON LIGHT - IP68 RATED WARM WHITE	ACOLYTE	NL-67-24-30-B	INTEGRAL LED 3000K	72 VA SUNSET TO SUNRISE	NON-DIM
L3	RECESSED OR BOLLARD MOUNTED LED STEP LIGHT	BEGA	22272-K3-[FINISH]	INTEGRAL LED 3000K	7 VA SUNSET TO SUNRISE	NON-DIM
L5	RECESSED LED 9" ROUND UPLIGHT	BEGA	84115-K3	INTEGRAL LED 3000K	19 VA SUNSET TO SUNRISE	0-10V LED
L6	RECESSED LINEAR LED 6" SLOT INGRADE WALLWASHER	BEGA	77646-K3	INTEGRAL LED 3000K	40 VA SUNSET TO SUNRISE	0-10V LED
L16-01'	SURFACE MOUNTED LINEAR LED GRAZING WASHLIGHT	ECOSENSE	TROV L50-E-12"-10-30-90-MULT-9X29	INTEGRAL LED 3000K	10 VA SUNSET TO SUNRISE	NON-DIM
L16-04'	SURFACE MOUNTED LINEAR LED GRAZING WASHLIGHT	ECOSENSE	TROV L50-E-48"-10-30-90-MULT-9X29	INTEGRAL LED 3000K	40 VA SUNSET TO SUNRISE	NON-DIM
L16A-01'	SURFACE MOUNTED LINEAR LED GRAZING WASHLIGHT	ECOSENSE	TROV L50-E-12"-06-30-90-MULT-9X29	INTEGRAL LED 3000K	6 VA SUNSET TO SUNRISE	NON-DIM
L16A-04'	SURFACE MOUNTED LINEAR LED GRAZING WASHLIGHT	ECOSENSE	TROV L50-E-48"-06-30-90-MULT-9X29	INTEGRAL LED 3000K	24 VA SUNSET TO SUNRISE	NON-DIM

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THE EAST GROUP GALLAGHER & ASSOCIATES BREE & ASSOCIATES LIGHT DEFINES FORM ENGINEERING SOURCE

> NOT FOR CONSTRUCTION OR BIDDING

**REVISION:** 

SCALE:

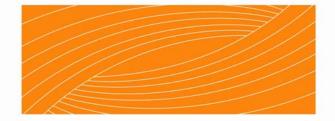
1/8" = 1'-0"


SHEET NAME:


IN-GRADE LIGHTING LAYOUT

SHEET NUMBER:

LT100 SEPTEMBER 26, 2018

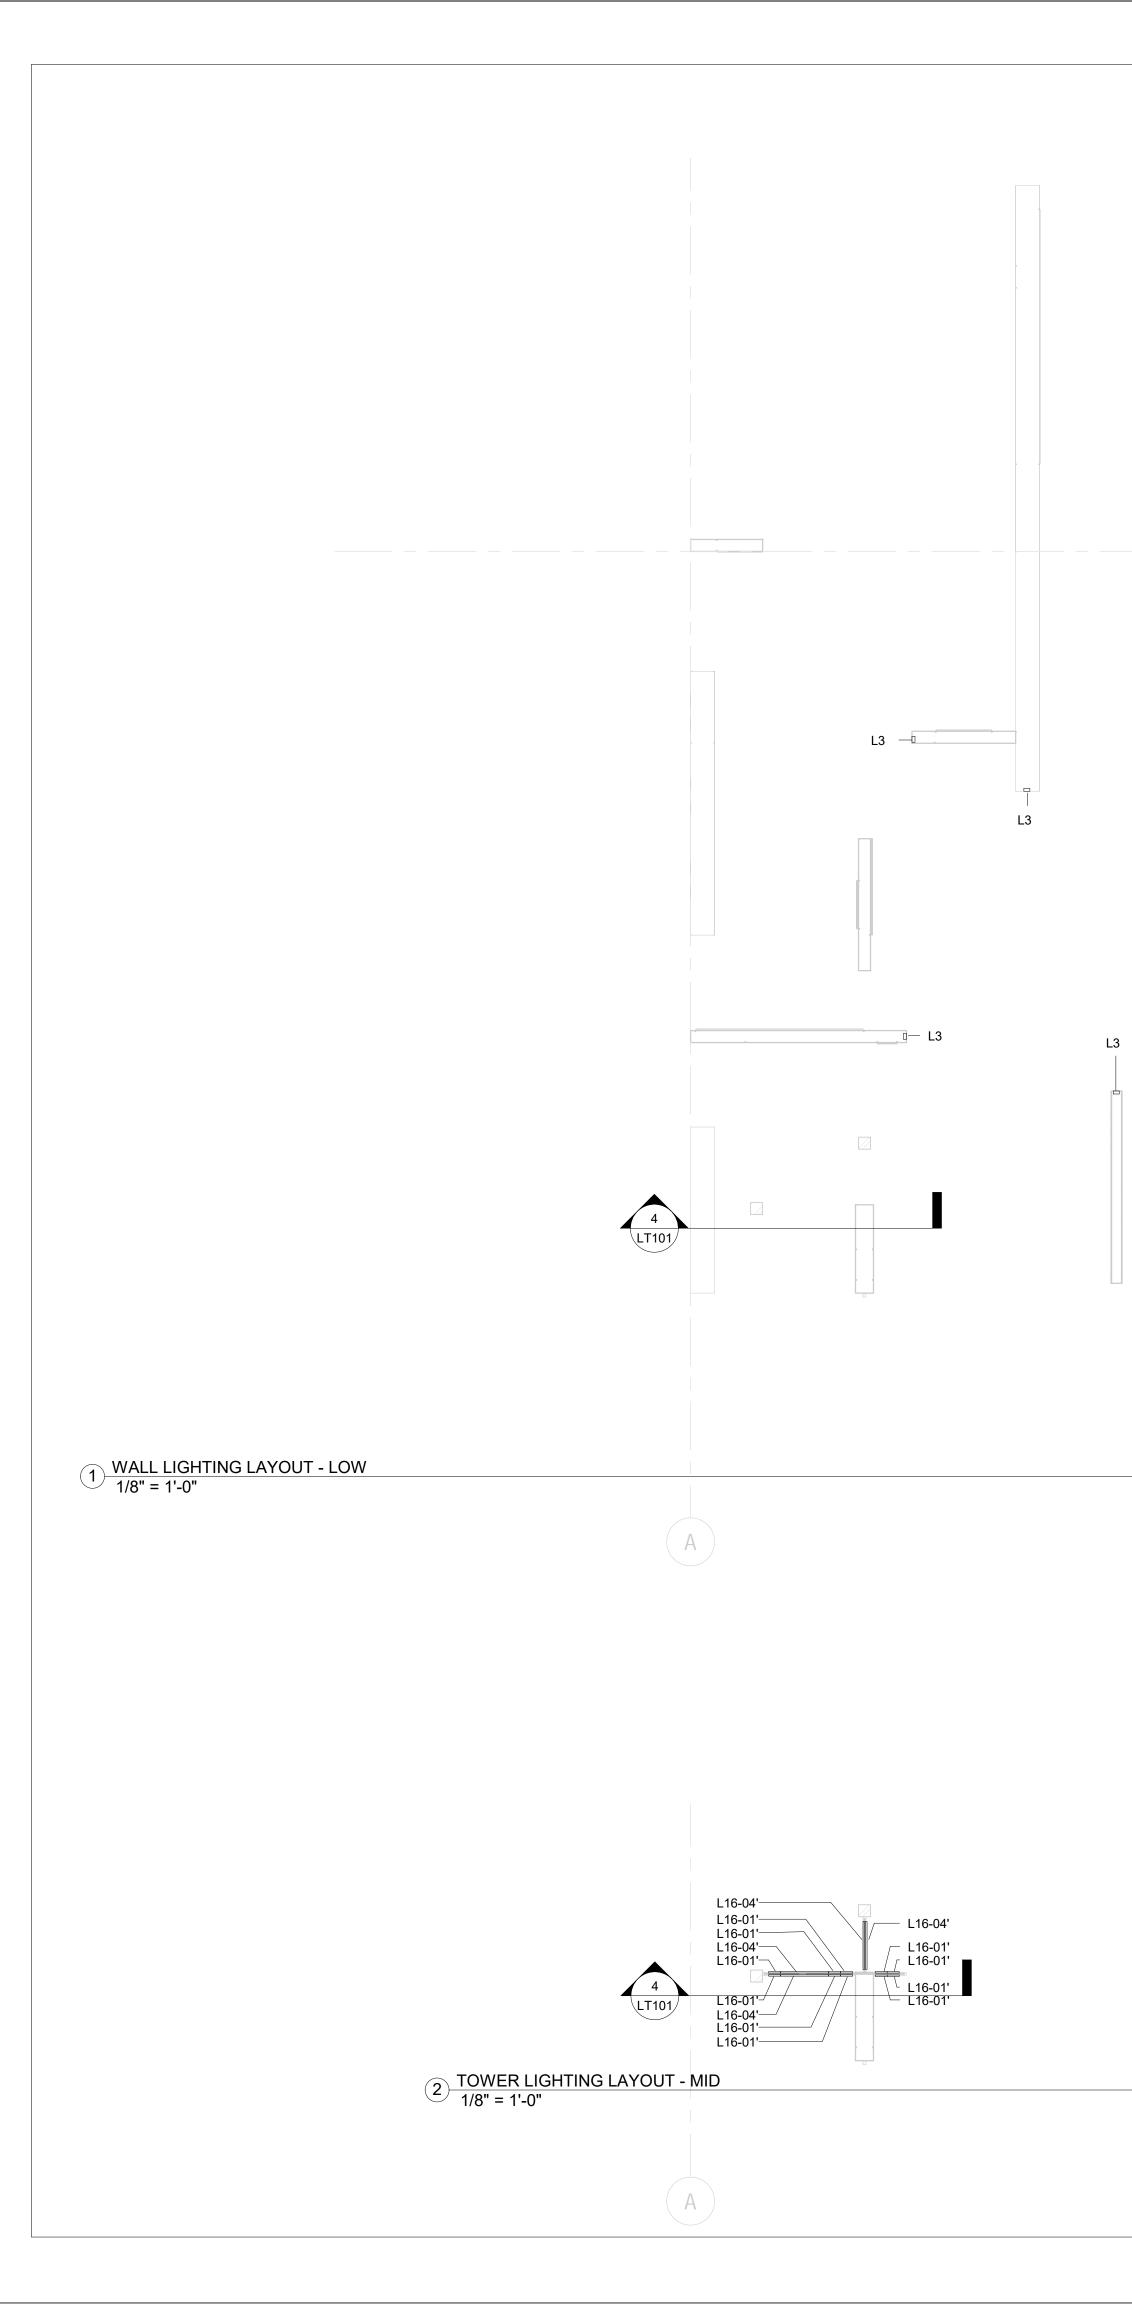

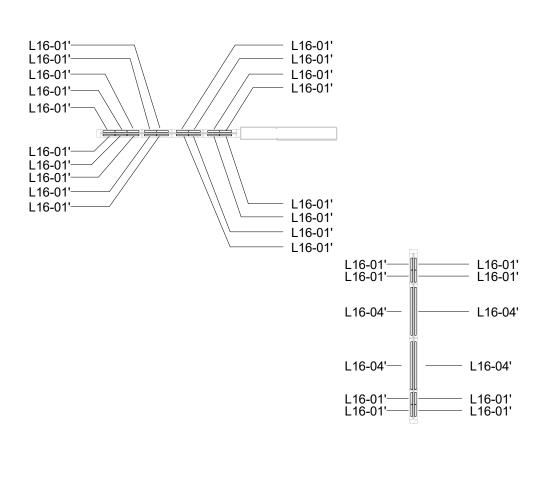

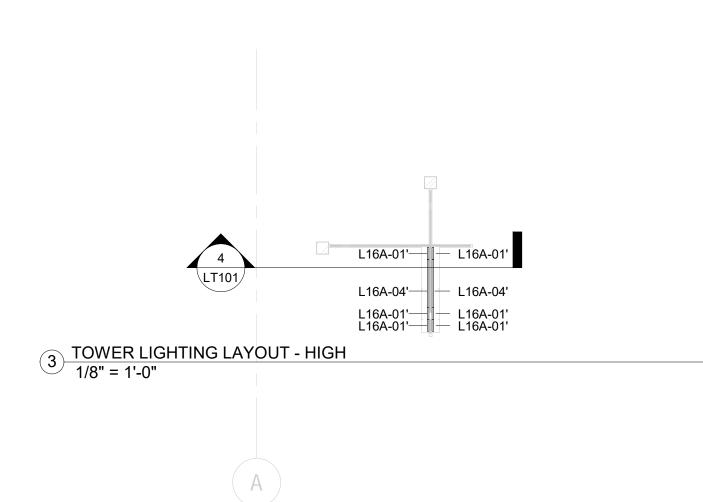

- 1


# GREENVILLE TOWN COMMON SYCAMORE HILL GATEWAY PLAZA

#### 90% DESIGN SUBMISSION

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**REVISION:** 

SCALE:


DATE:

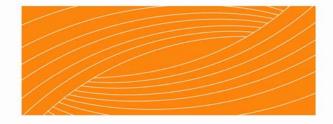1/8" = 1'-0"

SHEET NAME: ARCHITECTURAL LIGHTING LAYOUT

SHEET NUMBER:

LT101 SEPTEMBER 26, 2018

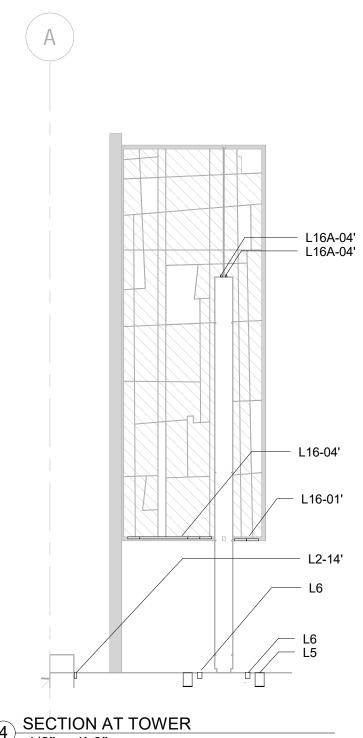

4 SECTION AT TOWER 1/8" = 1'-0"



MAINTAINED ILLUMINANCE AT GRADE FROM ARCHITECTURAL FIXTURES 1/8" = 1'-0"


# GREENVILLE TOWN COMMON SYCAMORE HILL GATEWAY PLAZA

#### 90% DESIGN SUBMISSION

ADDRESS: 105 E 1ST ST, GREENVILLE, NC 27858 Tel. 252.329.4567 OWNER:



OWNER:

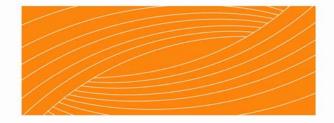

RHODESIDE & HARWELL 510 King Street Suite 300 Alexandria, VA 22314 703-683-7447 ph 703-683-7449 fx www.rhodeside-harwell.com

#### PERKINS+WILL

411 W. Chapel Hill St., Suite 200, Durham, NC 27701 919-433-5300 ph 919-433-5301 fx <u>www.perkinswill.com</u>

THE EAST GROUP GALLAGHER & ASSOCIATES BREE & ASSOCIATES LIGHT DEFINES FORM ENGINEERING SOURCE

> NOT FOR CONSTRUCTION OR BIDDING

**REVISION:** 

SCALE:

1/8" = 1'-0"

SHEET NAME:

MAINTAINED ILLUMINANCE AT GRADE

SHEET NUMBER:

LT102 SEPTEMBER 26, 2018