### GUY SMITH STADIUM IMPROVEMENTS

2113 Myrtle Ave, Greenville, NC 27834

Issue Date: 9/22/2023

Project Type: Stadium Improvements

Project No. 23-0176

### Project Status: CONSTRUCTION DOCUMENTS

### PROJECT DIRECTORY

### **OWNER**

City of Greenville, NC 200 West Fifth St. Greenville, NC 27858 Mark Nottingham Mnottingham@greenvillenc.gov

### **ARCHITECTURE**

**Mammoth Sports Construction** 

601 E Wyandotte St. Meriden, KS 66512 David Devore, Head of Design and Architecture

David@mammothbuilt.com

### <u>CIVIL</u>

**Mammoth Sports Construction** 

601 E Wyandotte St. Meriden, KS 66512 Dylan Medlock, Director of Engineering Dmedlock@mammothbuilt.com

### <u>MEP</u>

RTM Engineering Consultants
9225 Indian Creek Pkwy. Suite 1075
Overland Park, KS 66210
Keith Hammerschmidt
Keith.Hammerschmidt@rtmec.com

### SCOPE OF WORK

Phase 1 - Relocate foul line field fences, warning track, and bullpens. Remove and build new batting cages and hitting net systel Phase 2 - Build new bleachers, restrooms, concessions, and merchandise structures.

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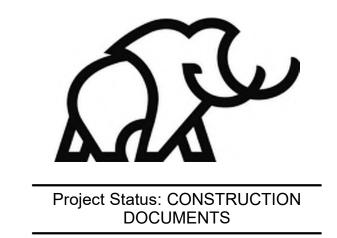
### LOCATION MAP



SITE MAP



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# Y SMITH STADIUM IMPROVEMENTS



Revision Key

Date Revision

Project Manager:

BH

Project Architect:

DF

Checked By:

DD

Project Number:

23-0176

Date of Issue:

Issue Date: 9/22/2023

G000 COVER SHEET

### 1.0 GENERAL CIVIL CONSTRUCTION NOTES:

### 1.1 SCOPE OF THE WORK

A. SITE WORK, INCLUDING FINE GRADING, CHAINLINK FENCE INSTALLATION, AND ATHLETIC FIELD APPURTENANCES.

### 1.2 SPECIFICATIONS WHICH APPLY:

A. CONTRACTOR SHALL FOLLOW THE PROJECT MANUAL FOR GUY SMITH STADIUM DOCUMENTS INCLUDED AS PART OF THIS PROJECT.

### 1.3 OVERALL PROJECT GENERAL NOTES

- A. ALL WORK SHALL CONFORM TO THE CONTRACT DOCUMENTS, WHICH INCLUDE, BUT ARE NOT LIMITED TO, THE OWNER CONTRACTOR AGREEMENT, DRAWINGS OF ALL DISCIPLINES AND ALL ADDENDA, MODIFICATIONS AND CLARIFICATIONS ISSUED BY THE ENGINEER ALL WORK PRESENTED SHALL CONFORM TO ANY CONTRACT DOCUMENTS, INCLUDING THE PROJECT MANUAL FOR GUY SMITH STADIUM.
- B. WRITTEN DIMENSIONS TAKE PRECEDENCE OVER SCALED DIMENSIONS. NOTIFY ENGINEER OF ANY DISCREPANCIES OR CONDITIONS REQUIRING INFORMATION OR CLARIFICATION BEFORE PROCEEDING WITH THE WORK.
- C. FIELD VERIFY ALL EXISTING CONDITIONS AND DIMENSIONS. NOTIFY ENGINEER OF ANY DISCREPANCIES OR CONDITIONS REQUIRING INFORMATION OR CLARIFICATION BEFORE PROCEEDING WITH THE WORK.
- D. RESTORE ALL EXISTING AREAS AFFECTED BY DEMOLITION AND RELATED NEW CONSTRUCTION TO THEIR ORIGINAL CONDITION.

### 2.0 SITE WORK

### 2.1 GENERAL

A. THE SCOPE OF THE WORK WILL INCLUDE FINE GRADING, CONCRETE WORK, INSTALLATION OF ATHLETIC RELATED FURNISHINGS, AND GENERAL SITE RESTORATION UPON COMPLETION.

### 2.2 CLEARING AND GRUBBING

A. ALL CLEARING AND GRUBBING SHALL BE CONSIDERED INCIDENTAL.

### 2.3 GRADING:

- A. WORK SHALL INCLUDE STRIPPING AND REMOVAL OF TOPSOIL AND UNSUITABLE SOILS AND REGRADING OF SITE TO INDICATED GRADES. TOPSOIL REMOVAL AND SUBGRADE PREPARATION FOR LIGHTLY LOADED PAVEMENT; BATTING CAGE OR SIMILAR INSTALLATION.
- B. THE CONTRACTOR SHALL MAINTAIN DRAINAGE THROUGH THE PROJECT AREA AT ALL TIMES. ALL MATERIALS AND LABOR NECESSARY TO MAINTAIN DRAINAGE (DEWATERING) SHALL BE CONSIDERED INCIDENTAL TO THE PROJECT, UNLESS OTHERWISE SPECIFIED.
- C. TOPSOIL AND UNSUITABLE SOILS SHALL BE EXCAVATED AS NEEDED. THE SUBGRADE SHALL BE APPROVED BY THE CIVIL ENGINEER OF RECORD OR A GEOTECHNICAL ENGINEER PRIOR TO PLACEMENT OF FILL / AGGREGATE. THE EXCAVATION SHALL ALWAYS BE MAINTAINED FREE OF WATER.
- D. SALVAGED MATERIAL SHALL BE USED TO FILL GRASSED AREAS THAT WERE DISTURBED, AS REQUIRED, LEAVING ROOM FOR 6" MINIMUM OF TOPSOIL IN THE LANDSCAPED AREAS. UNSUITABLE MATERIALS SUCH AS ROCKS, BOULDERS, TREE ROOTS, ETC. SHALL BE REMOVED FROM THE BACKFILL MATERIAL AND DISPOSED OF OFF-SITE. EXCESS EXCAVATED MATERIAL SHALL BE HAULED FROM THE SITE OR TO A SUITABLE PLACE ON SITE DESIGNATED BY OWNER.

### 2.5 SUBGRADE:

- A. EXECUTION:
- 1. SUBGRADE SHALL BE PREPARED IN ACCORDANCE WITH NCDOT SPECIFICATIONS.

### B. FINAL RESULT

1. LOW SPOTS OR POCKETS FROM WHICH WATER WILL NOT DRAIN ARE NOT ACCEPTABLE.

### 2.6 SITE SOILS:

A. AS PER THE USDA WEB SOIL SURVEY TOOL, THE SITE CONSISTS OF EXUM FINE SANDY LOAM (0-1%) AND GOLDSBORO SANDY LOAM (0-1%).

### 2.7 AGGREGATES AND STRUCTURAL FILL:

- A. GRANULAR STRUCTURAL FILL: THE GRANULAR STRUCTURAL FILL SHOULD CONSIST OF A PIT-RUN OR PROCESSED SAND OR GRAVEL HAVING A MAXIMUM PARTICLE SIZE OF 3 INCHES WITH LESS THAN 15 PERCENT BY WEIGHT PASSING THE #200 SIEVE. THE GRANULAR STRUCTURAL FILL SHOULD BE PLACED IN LIFTS OF UP TO 1 FOOT IN
- B. <u>SELECT GRANULAR FILL</u>: THE SELECT GRANULAR FILL SHOULD CONSIST OF A MEDIUM TO COARSE GRAINED, FREE-DRAINING SAND OR ROCK HAVING A MAXIMUM PARTICLE SIZE OF 1 INCH WITH LESS THAN 5 PERCENT BY WEIGHT PASSING THE #200 SIEVE. THE SELECT GRANULAR FILL SHOULD BE PLACED IN LIFTS OF UP TO 1 FOOT IN

### 2.8 SITE RESTORATION:

A. ALL SITE WORK THAT IS NOT ATHLETIC FIELD RELATED TO BE SEEDED AS SHOWN ON THE SITE RESTORATION PLAN. ALL SEEDING OPERATIONS TO FOLLOW NCDOT SPECIFICATIONS.

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Revision Key

No. Date Revision

Project Manager:

Project Engineer:

DM

Checked By:

DR

Project Number:

23-0176

Date of Issue:

09-20-2023

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Sheet Number:

**GENERAL NOTES** 



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Project Manager: Project Engineer: Checked By: Project Number: 23-0176 Date of Issue: 08-14-2023 Sheet Number:

G - 002

SURVEY CONTROL

### SURVEY CONTROL AND INFORMATION

**DESCRIPTION:** ATHLETIC FACILITY IMPROVEMENTS IN GREENVILLE, NC GREENVILLE, PITT COUNTY, NORTH CAROLINA LAT: 35.602525° N LONG: 77.395133° W

BASED ON NAD83, STATE PLANE NORTH CAROLINA (3200) AND NAVD88. NO BENCHMARK FOUND - ASSUMED VERTICAL W/ AUTONOMOUS GPS SHOT. ALL PLAN ELEVATIONS ARE RELATIVE TO THE CONTROL.

CP #1000 N: 2477300.268 E: 678095.014 ELEV: 62.432

E: 678577.334

ELEV: 62.310

CP #1001 N: 2477172.647 E: 677944.194 ELEV: 63.172

CP #1003 N: 2476884.845 CP #1004 N: 2477378.924 E: 678429.476

CP #1005 N: 2477744.654 E: 677949.053 ELEV: 61.945 ELEV: 61.701


CP #1002

N: 2476808.883

E: 678040.352

ELEV: 63.037

**SURVEY CONTROL MAP** 

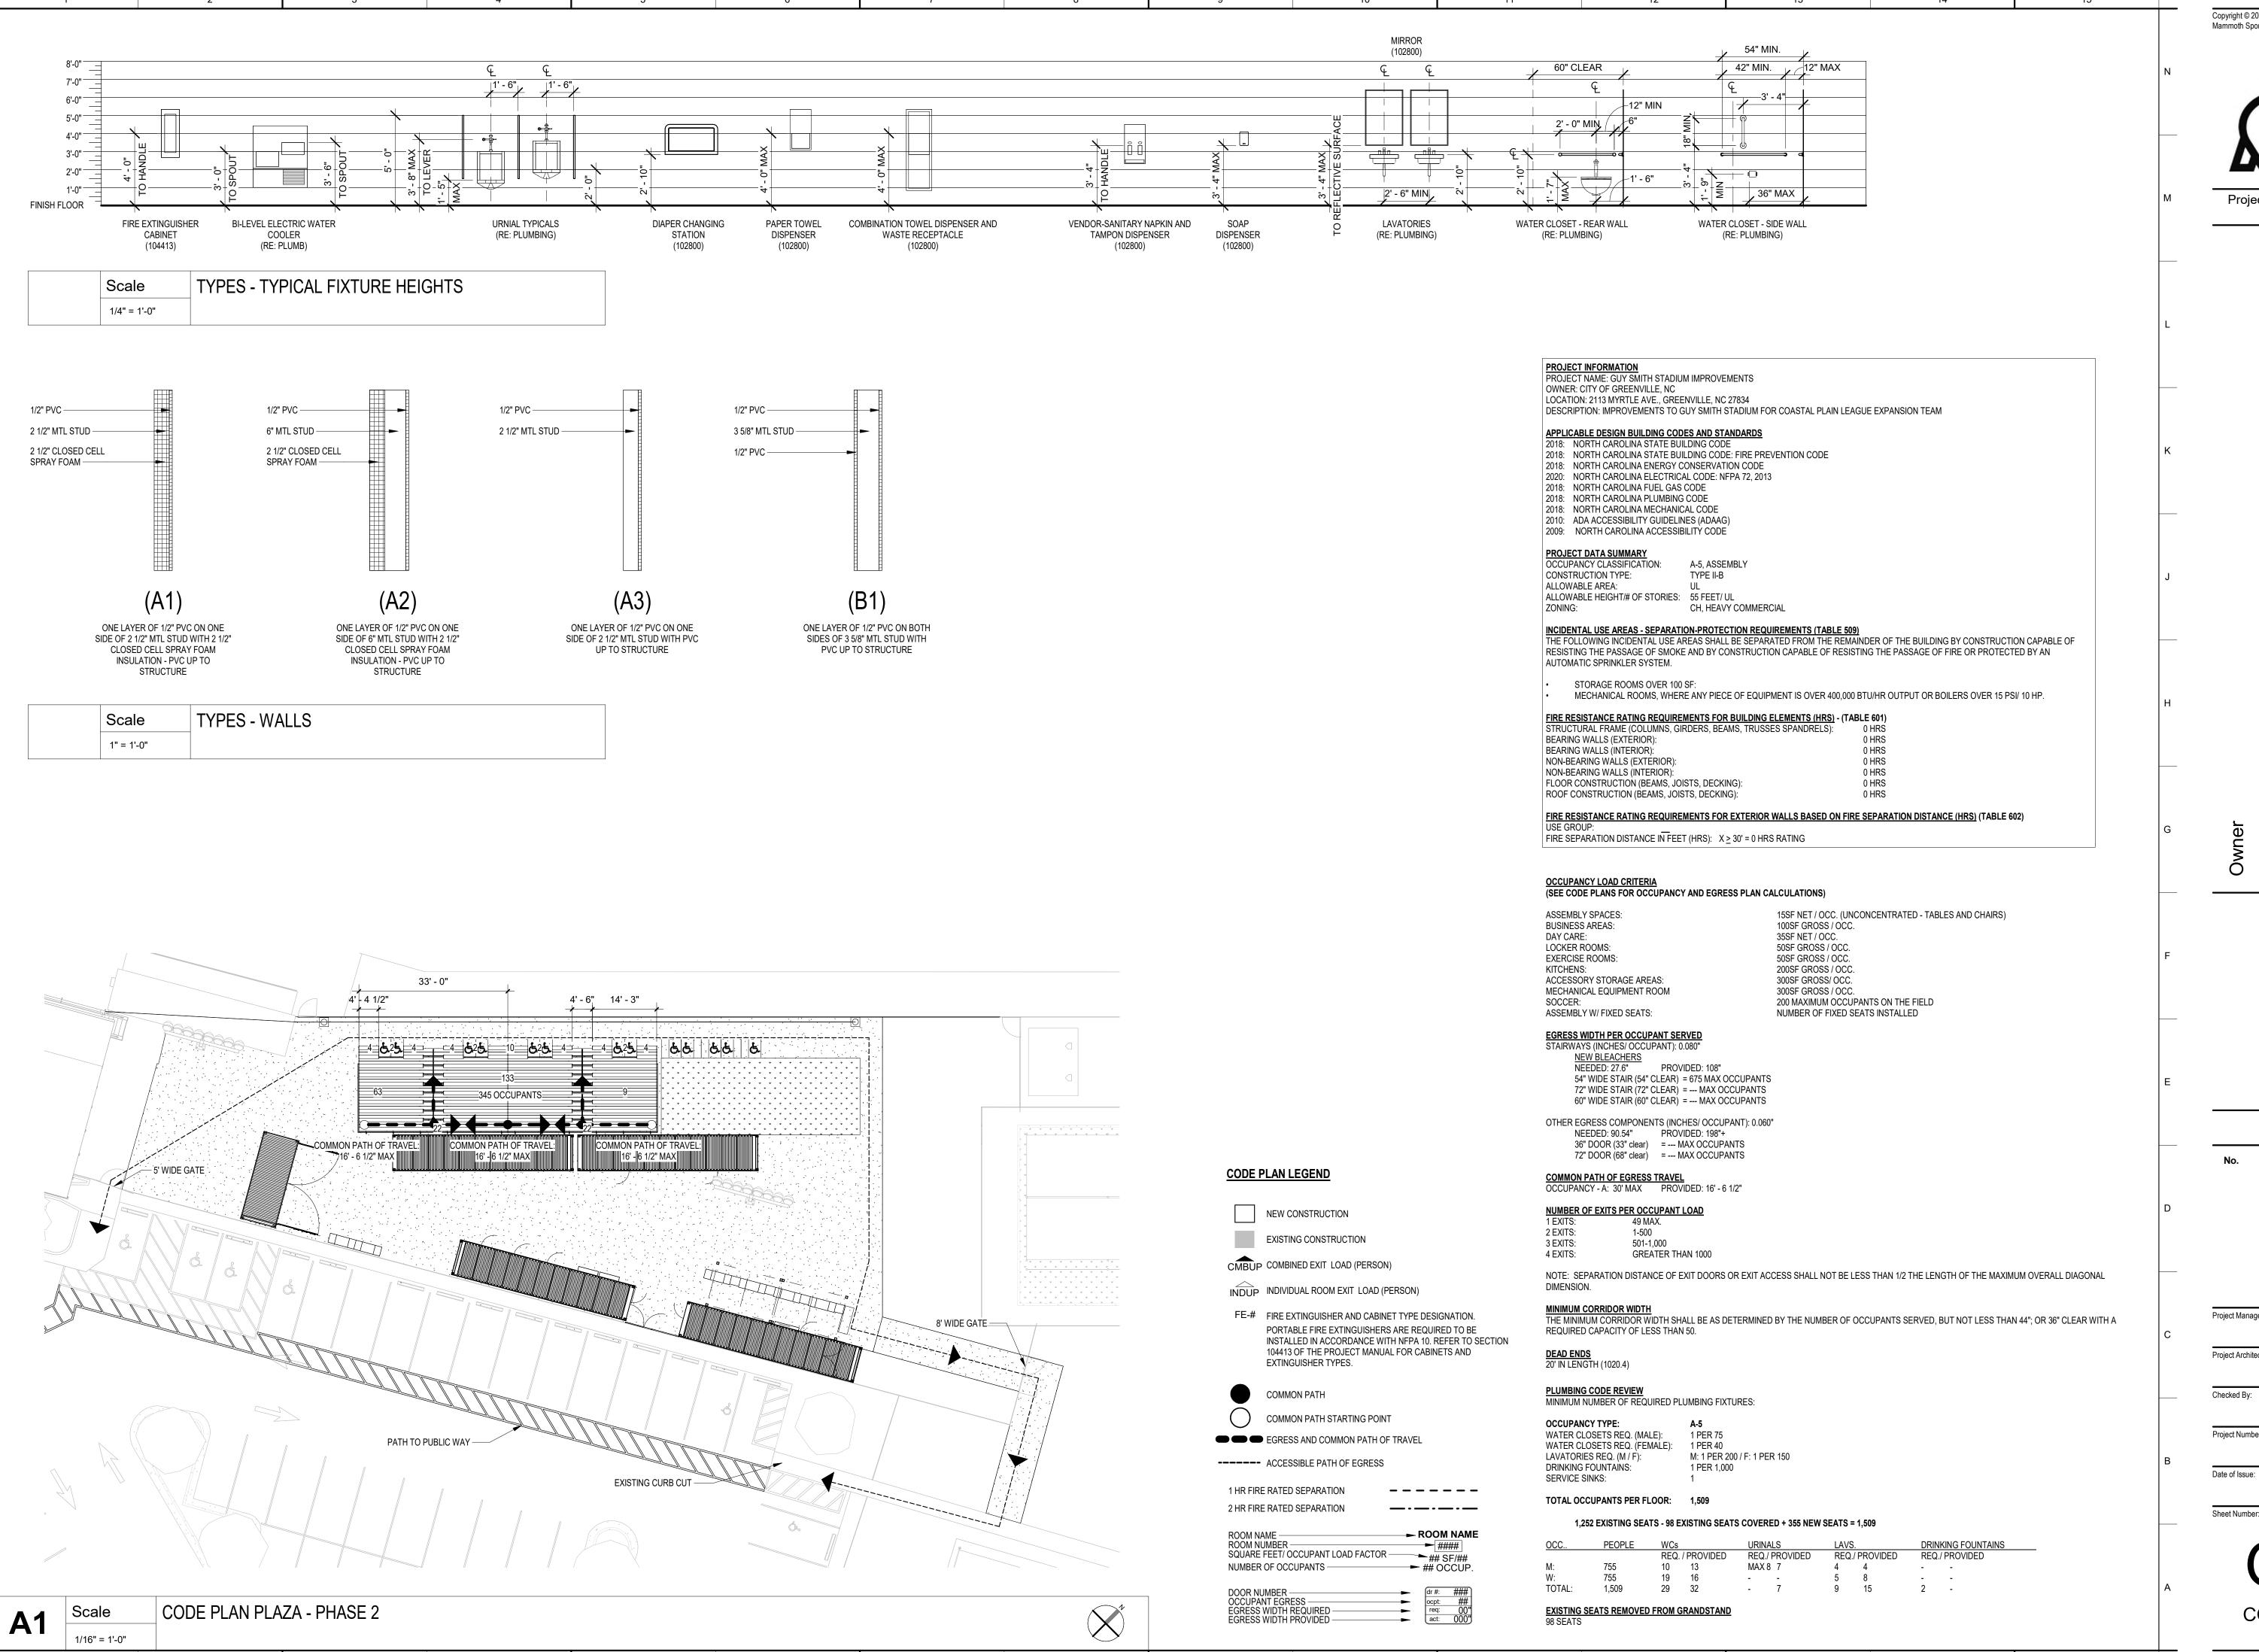




Project Status: CONSTRUCTION DOCUMENTS

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Revision Key

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**CODE SUMMARY** 



Checker 23-0176

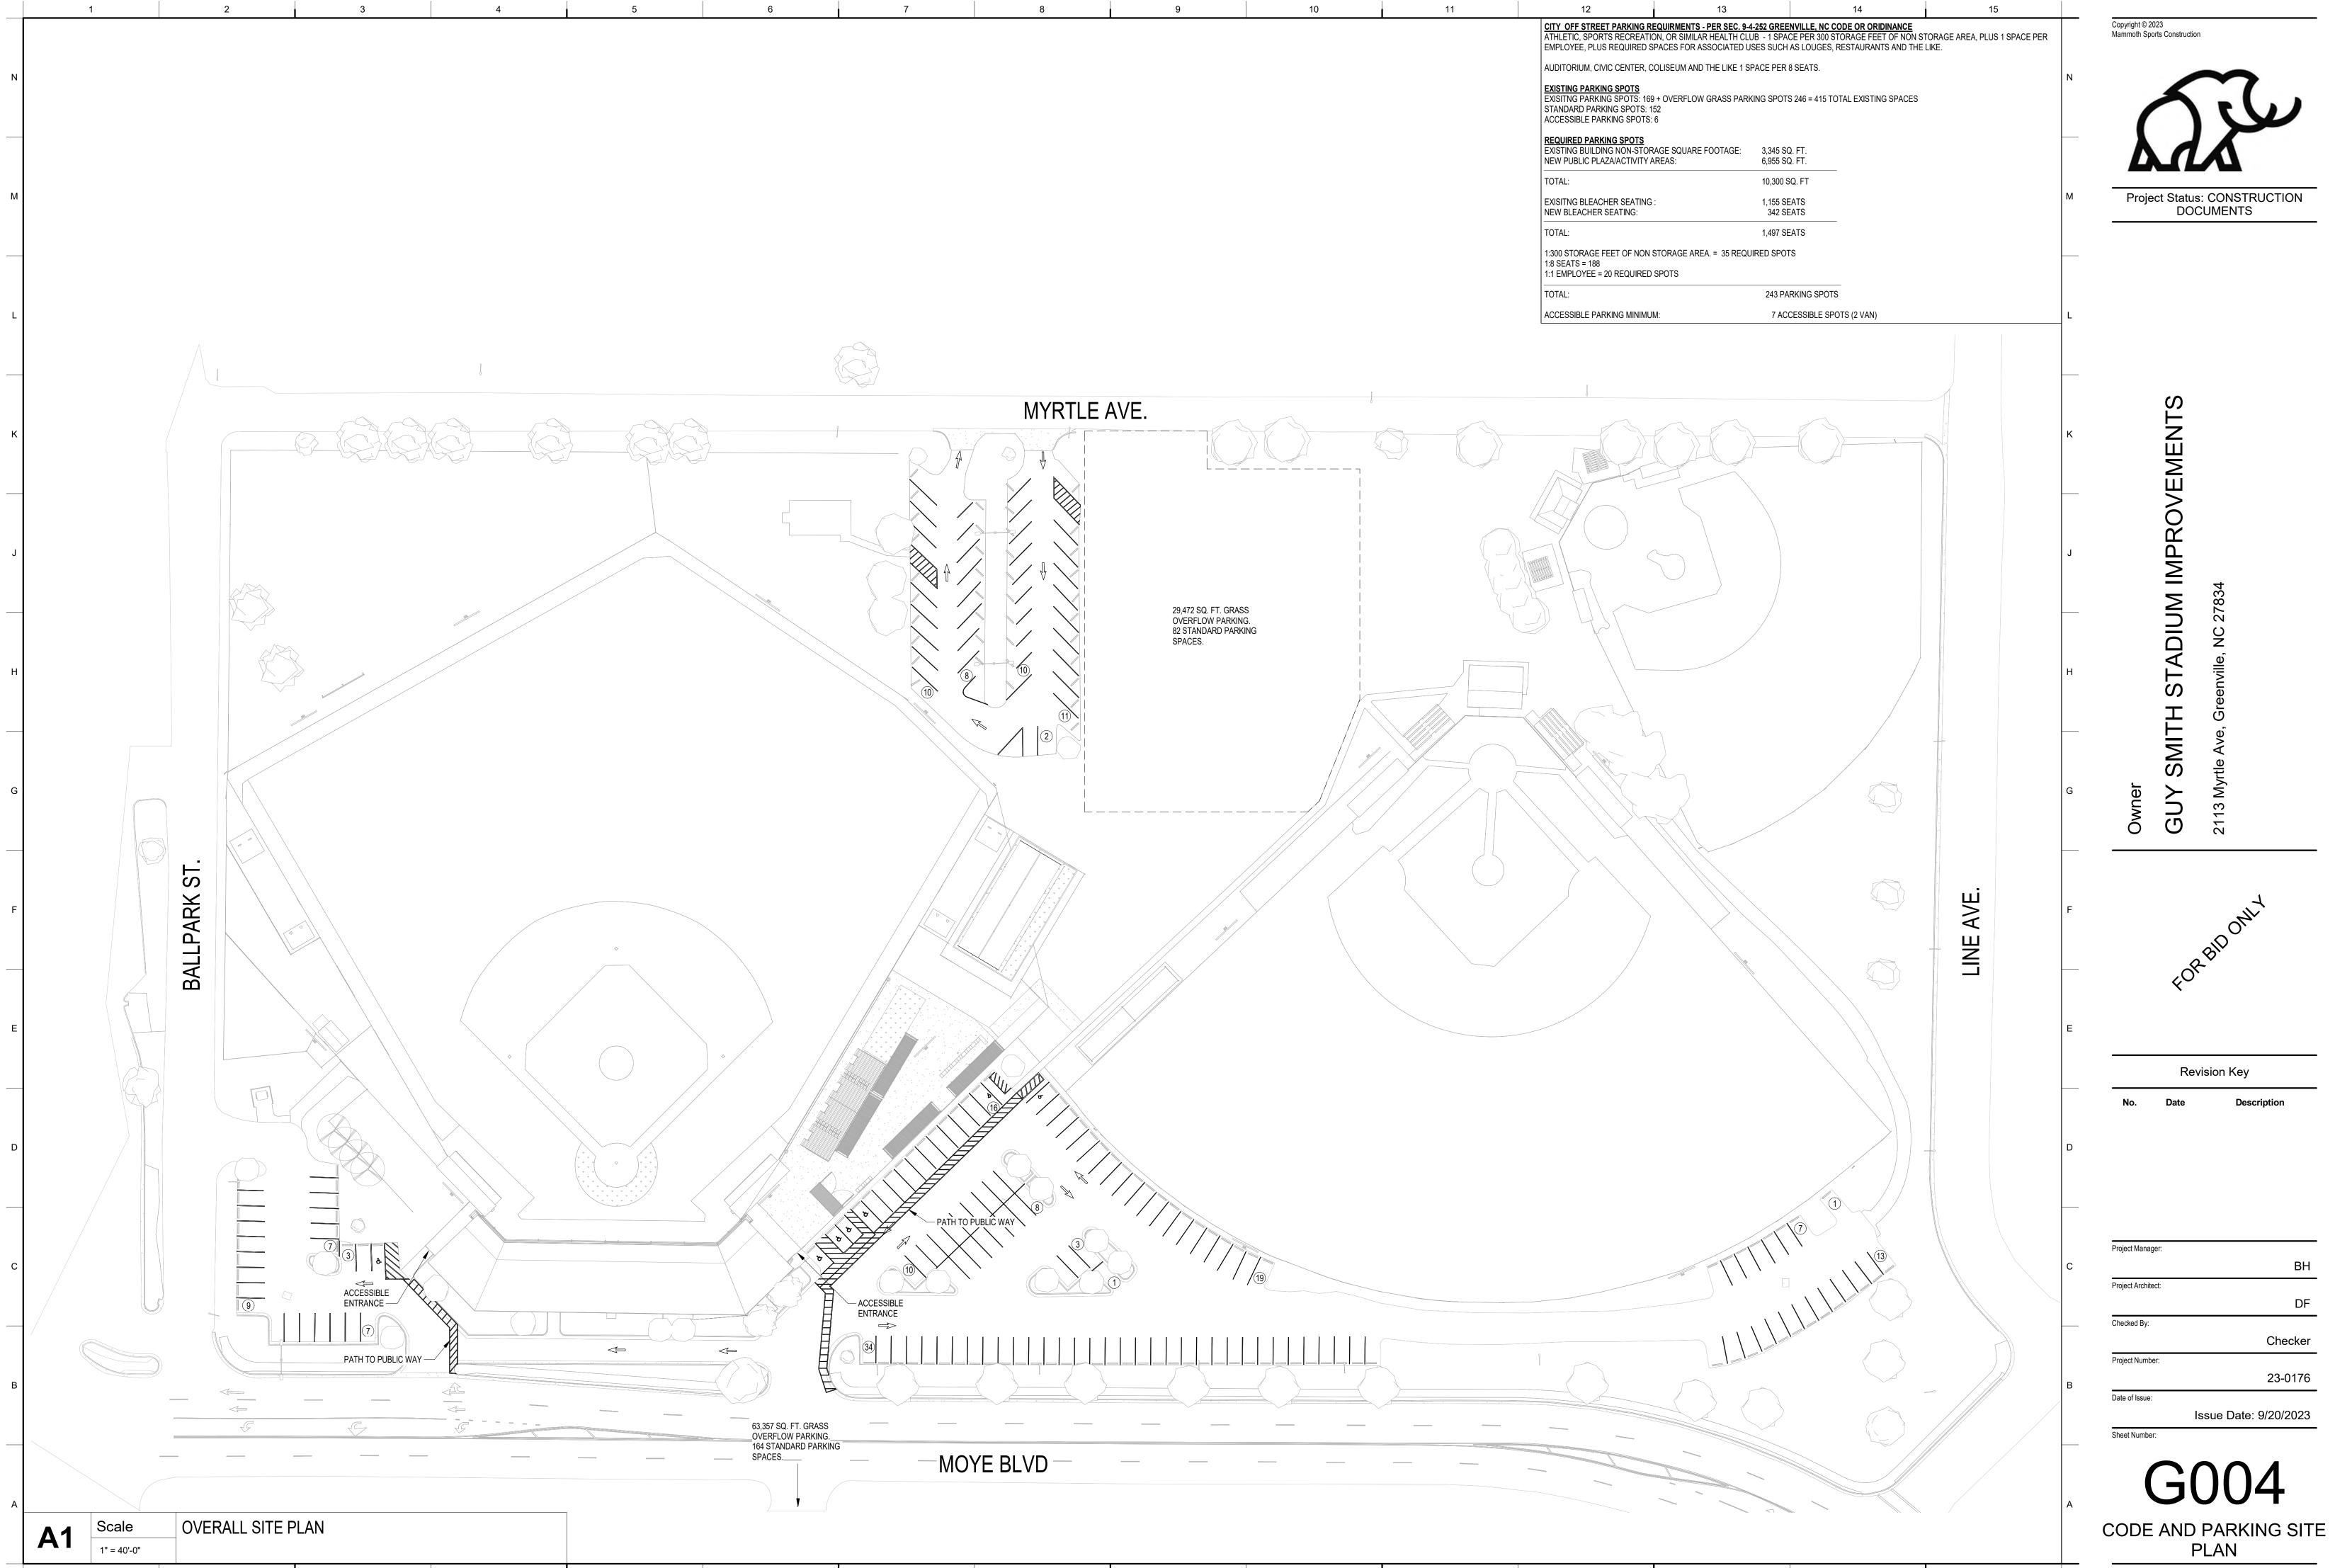

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## BUY SMITH STADIL MPROVEMENTS

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ADD.1 09-29-23 ADDITIONAL DETAIL

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DM

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09-20-2023

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Sheet Number:

SITE PLAN (PH. 2)





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ADD.1 09-29-23 ADDITIONAL DETAIL

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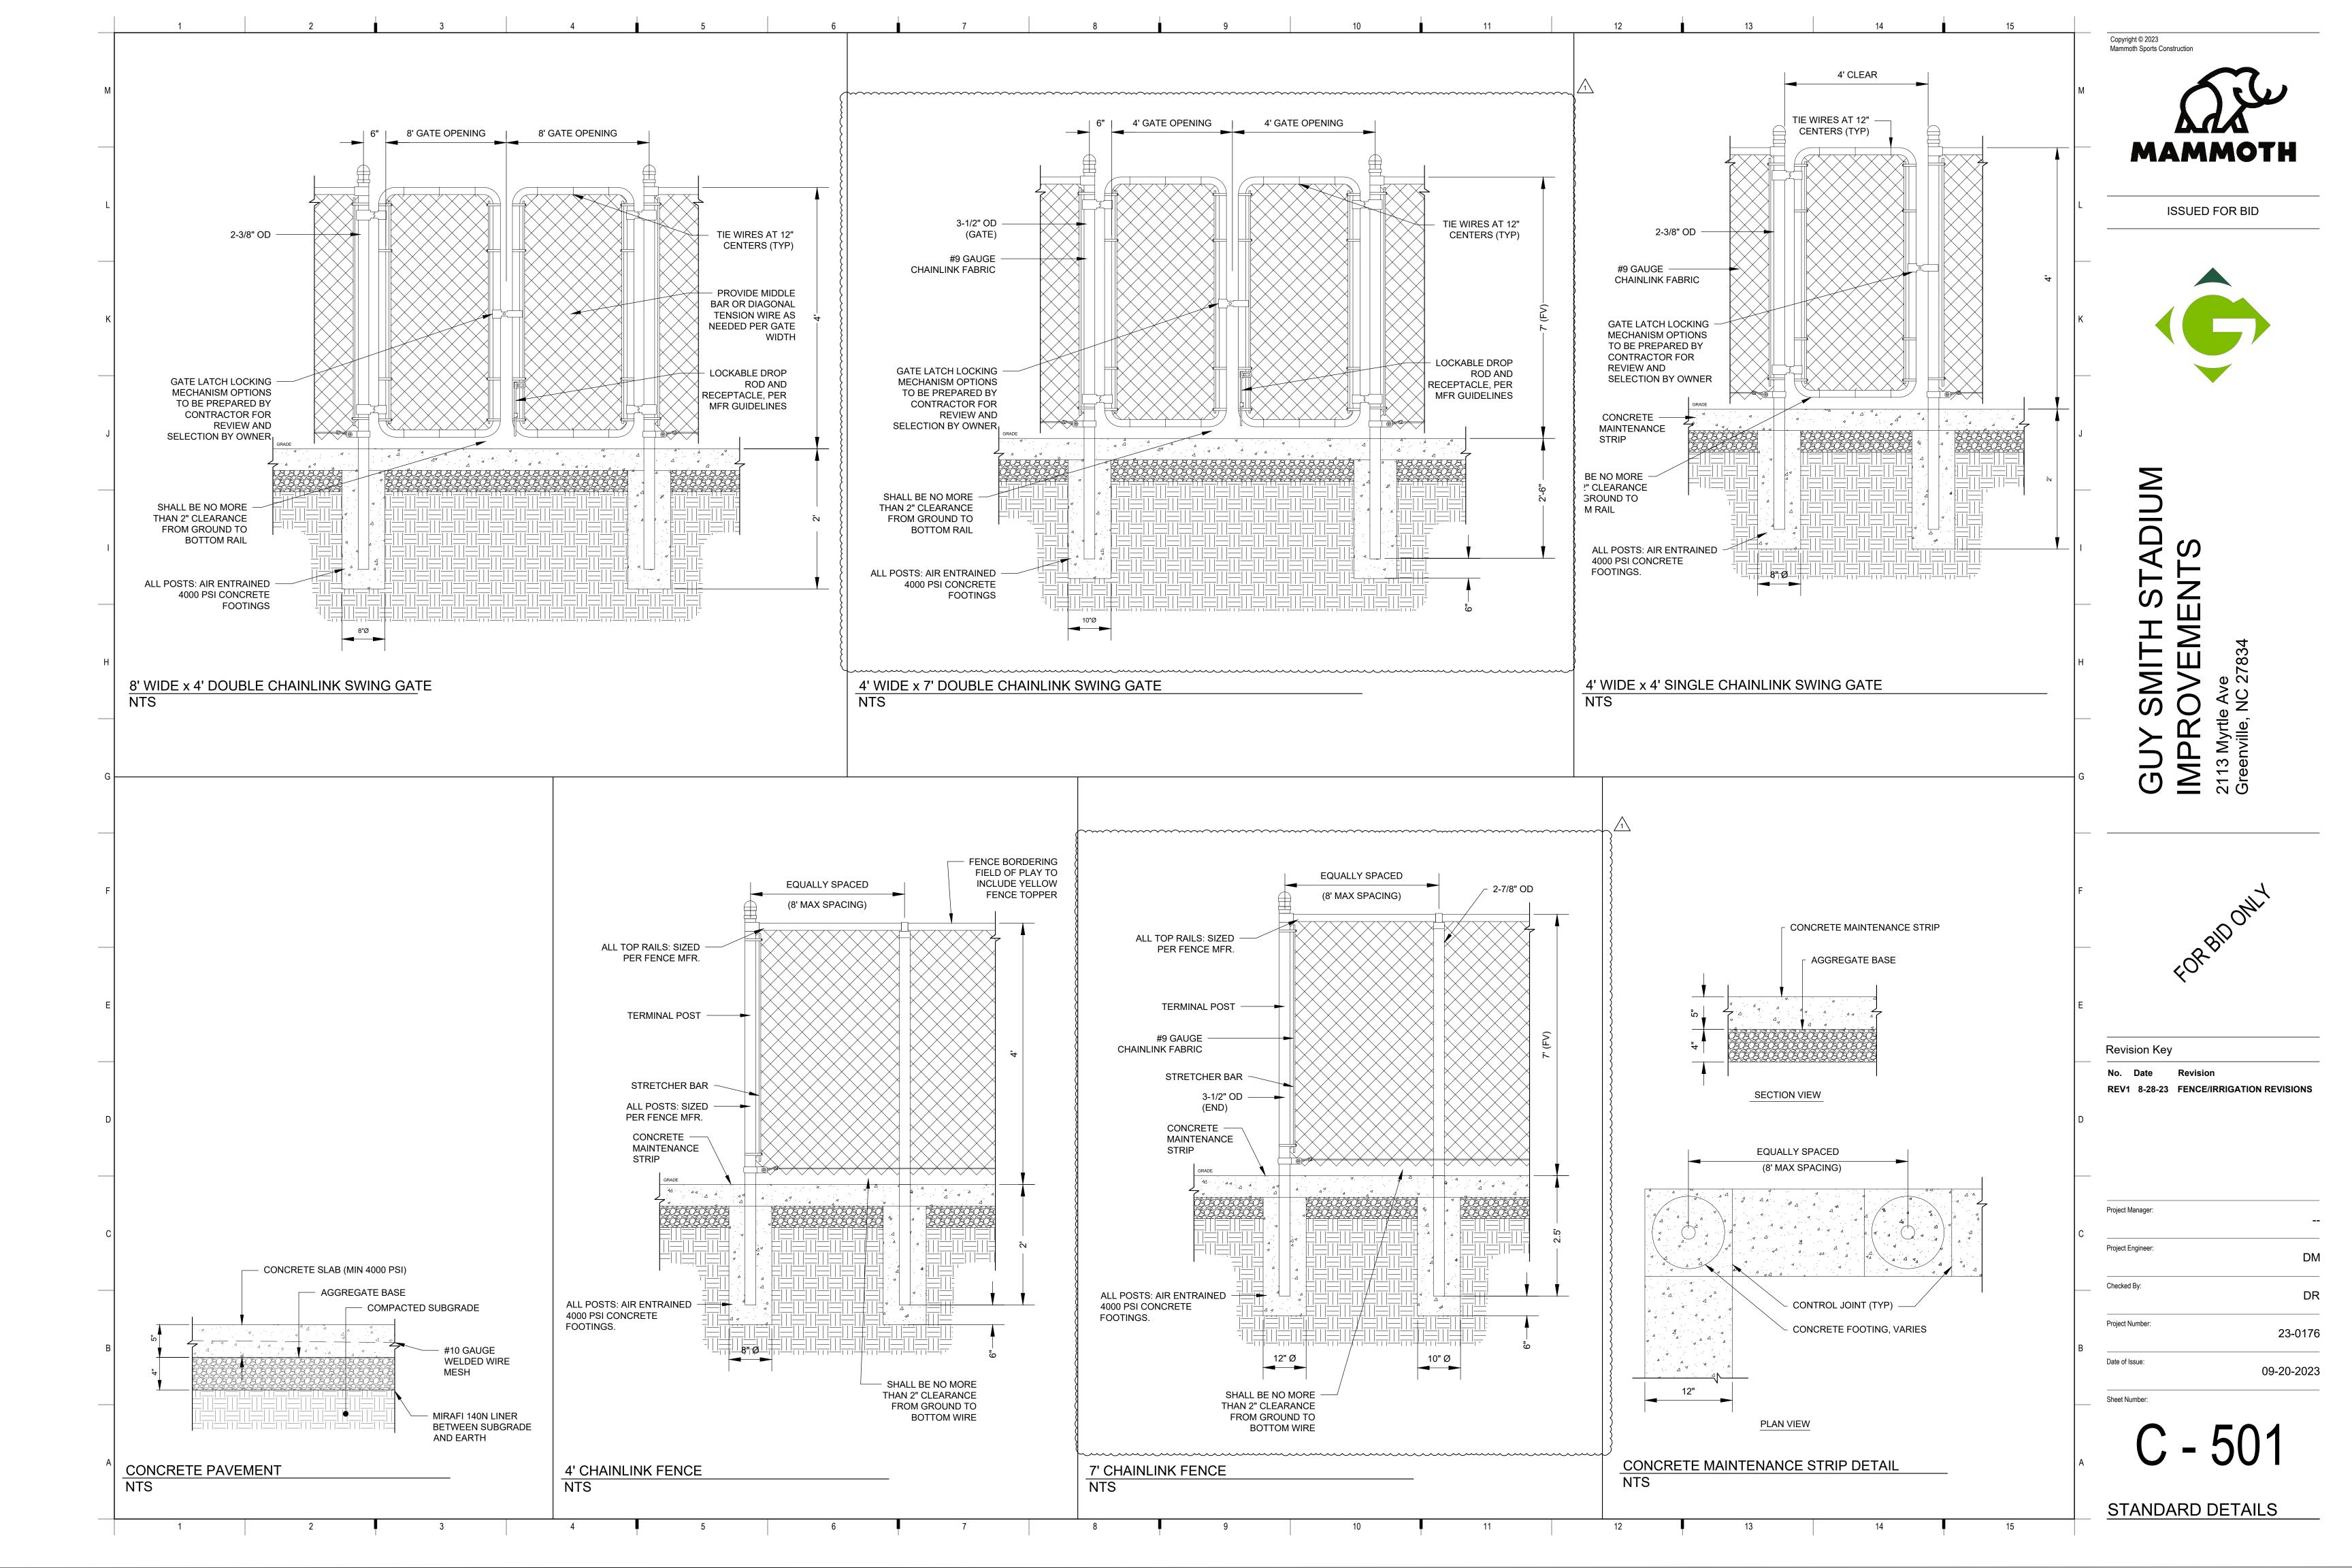
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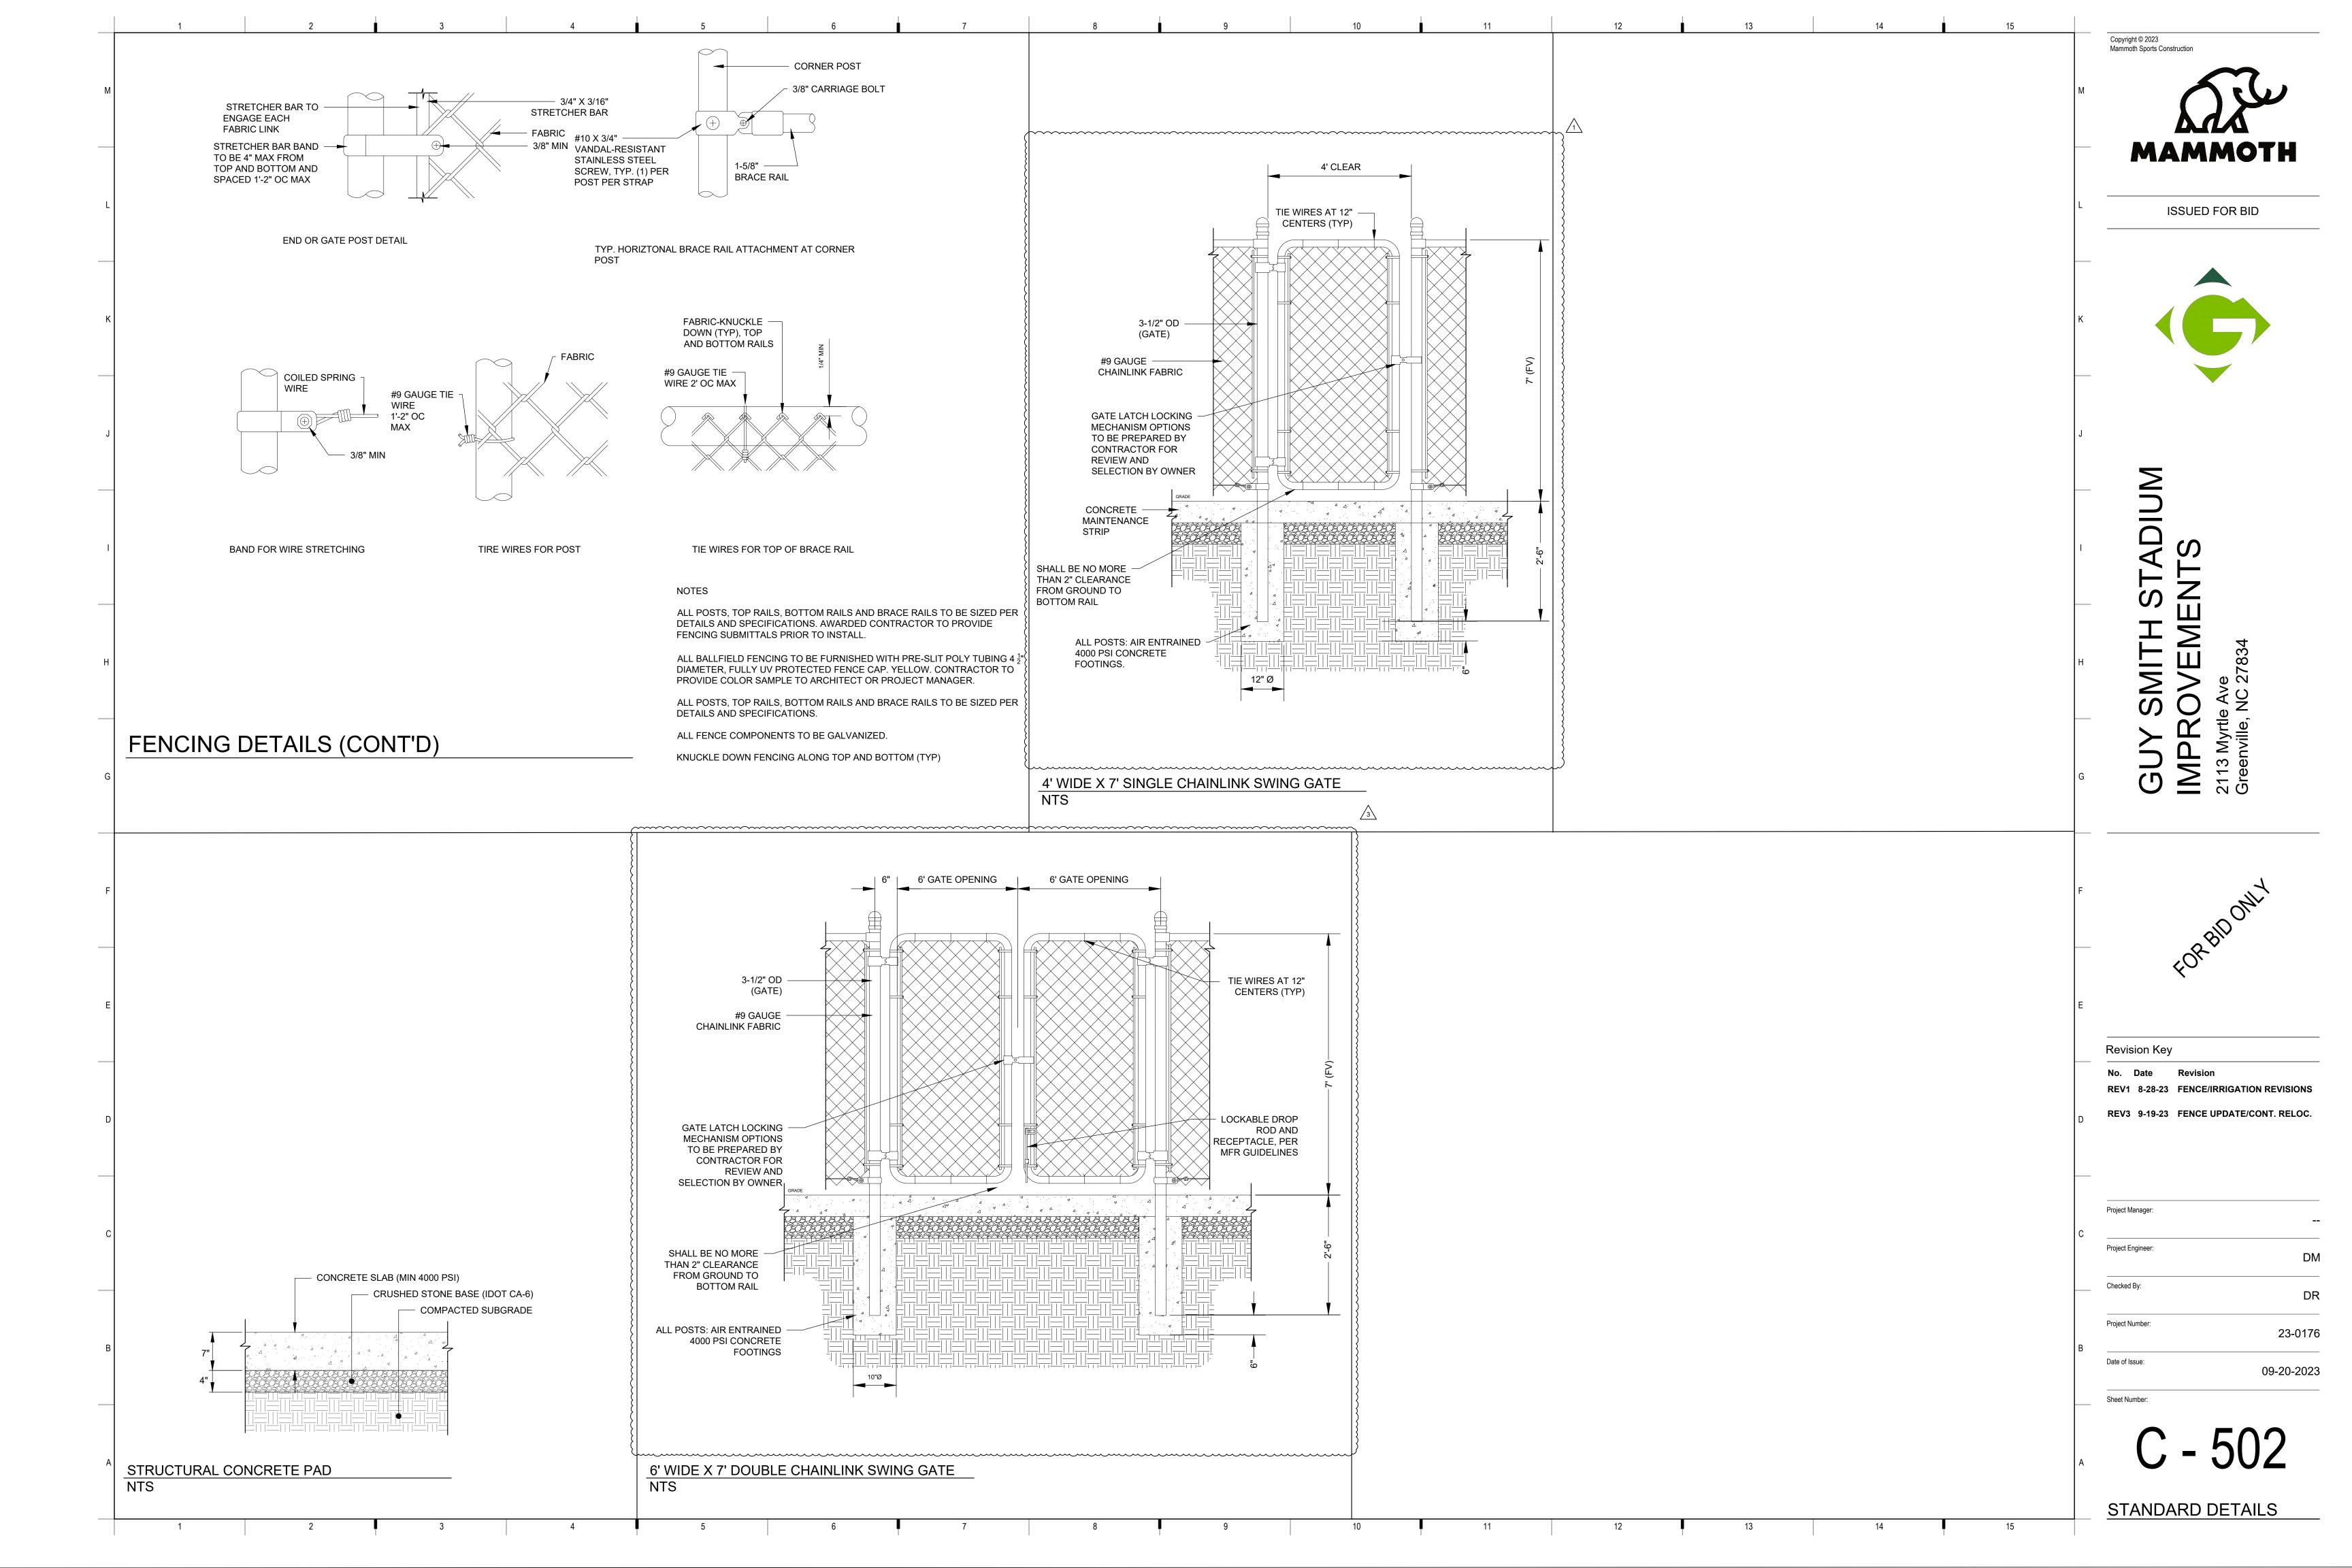
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C - 201

PH. 2 GRADE PLAN









SITE DEMO PLAN - PHASE 2

### **GENERAL NOTES - SITE DEMOLITION**

- THE CONTRACTOR, PRIOR TO ANY EXCAVATION OR NEW CONSTRUCTION, SHALL HAVE UTILITIES FIELD LOCATED BY THE APPROPRIATE UTILITY COMPANY AND/OR CITY/COUNTY AGENCY.AT LOCATIONS
- THE CONTRACTOR SHALL SPOT DIG TO FIELD LOCATE EXISTING SITE UTILITIES PRIOR TO CONSTRUCTION. SERVICE LINES SHOWN IN EXISTING SURVEY WERE OBTAINED FROM RECORD DATA AND SURFACE STRUCTURES AND WERE NOT FIELD LOCATED. EXISTING UTILITIES MAY NOT BE SHOWN OR MAY BE SHOWN INCORRECTLY.
- THE SITE PLAN IS BASED ON A SURVEY OF THE SITE CONDITIONS AT THE TIME OF CONSTRUCTION AND MAY VARY FROM THE SURVEYED CONDITIONS. CONTRACTOR SHALL VERIFY EXISTING SITE CONDITIONS PRIOR TO CONSTRUCTION.
- 4. ALL MANHOLES, CATCH BASINS, UTILITY VALVES AND METER PITS SHALL BE ADJUSTED OR REBUILT TO GRADE AS REQUIRED.
- NO CHANGES TO THE APPROVED CONSTRUCTION PLANS WILL BE PERMITTED WITHOUT PRIOR WRITTEN APPROVAL OF THE ENGINEER.
- THE CONTRACTOR SHALL BE RESPONSIBLE FOR PRESERVING PROPERTY PINS AND SECTION CORNER MONUMENTS. THE CONTRACTOR WILL BE REQUIRED TO RE-ESTABLISH ANY PROPERTY PINS OR MONUMENTS WHICH ARE DAMAGED OR DESTROYED BY HIS CONSTRUCTION OPERATIONS, SUCH PINS SHALL BE RE-ESTABLISHED BY A LICENSED LAND SURVEYOR IN ACCORDANCE WITH STATE LAWS.
- 7. THE CONTRACTOR IS RESPONSIBLE FOR VERIFYING ALL QUANTITIES, DIMENSIONS, AND PLAN SCALES, AND SHALL IMMEDIATELY NOTIFY THE OWNER/ENGINEER/ARCHITECT OF ANY SUCH DISCREPANCIES. ALL QUANTITIES, DIMENSIONS, AND PLAN SCALES PROVIED ARE FOR GENERAL INFORMATION PURPOSES ONLY. THE CONTRACTOR IS RESPONSIBLE FOR DETERMINING ALL QUANTITIES NECESSARY FOR THE COMPLETION OF THE WORK AS DESCRIBED IN THE CONSTRUCTION DOCUMENTS. THE CONTRACTOR SHALL BE RESPONSIBLE TO PROVIDE THE WORK DESCRIBED IN THE CONSTRUCTION DOCUMENTS IRRESPECTIVE OF THE QUANTITIES, DIMENSIONS, AND PLAN SCALES NOTED, NOT NOTED, OR NOTED

- ALL REMOVALS SHALL BE REMOVED FROM THE SITE AND DISPOSED OF PER APPLICABLE STANDARDS UNLESS OTHERWISE NOTED.
- THE CONTRACTOR SHALL FAMILIARIZE HIMSELF WITH THE GEOTECHNICAL ENGINEERING SERVICES REPORT AND SHALL IMPLEMENT THE RECOMMENDATIONS NOTED IN THE REPORT FOR ALL SOILS AND FOUNDATION RELATED CONSTRUCTION.
- 10. THE PAVEMENT SECTIONS ARE BASED ON THE GEOTECHNICAL REPORT. THE GEOTECHNICAL REPORT RECOMMENDATIONS SHALL TAKE PRECEDENCE IN THE CASE OF ANY DISCREPANCIES. CONSEQUENTLY, THE ENGINEER WHOSE SEAL APPEARS ON THESE PLANS IS NOT RESPONSIBLE FOR THE DURABILITY OR SUITABILITY OF THE PAVEMENT SECTIONS.
- 11. CONTRACTOR SHALL TAKE APPROPRIATE MEASURES TO PROTECT ALL ADJACENT WORK NOT INDICATED TO BE DEMOLISHED PRIOR TO COMMENCEMENT OF DEMOLITION. CONTRACTOR SHALL BE RESPONSIBLE FOR DAMAGE AND REPAIR CAUSED BY CONTRACTOR'S NEGLIGENT PERFORMANCE.
- 12. REFER TO MECHANICAL, PLUMBING, AND ELECTRICAL DEMOLITION DRAWINGS FOR ASSOCIATED WORK.
- 13. CONTRACTOR SHALL PROVIDE TEMPORARY SHORING AND BRACING OF PARTIALLY DEMOLISHED CONSTRUCTION AND STRUCTURAL ELEMENTS AS REQUIRED TO MAINTAIN SAFE WORKING CONDITIONS.
- 14. CONTRACTOR TO CONFIRM WITH ARCHITECTECT SECTIONS OF FENCE TO BE DEMOLISHED PRIOR TO DEMOLITION.

### **LEGEND - KEYNOTES**

KEY VALUE KEYNOTE TEXT

DEMOLISH SHADE STRUCTURE AND SOG D14 DEMOLISH EXISTING SIDEWALK D17


RELOCATE TRANSFORMER AND ELECTRICAL BOX - RE: MEP DEMOLISH FENCE - AT END OF PHASE 2 CONSTRUCTION

### **DEMOLITION LEGEND**



KEYNOTE IDENTIFIER

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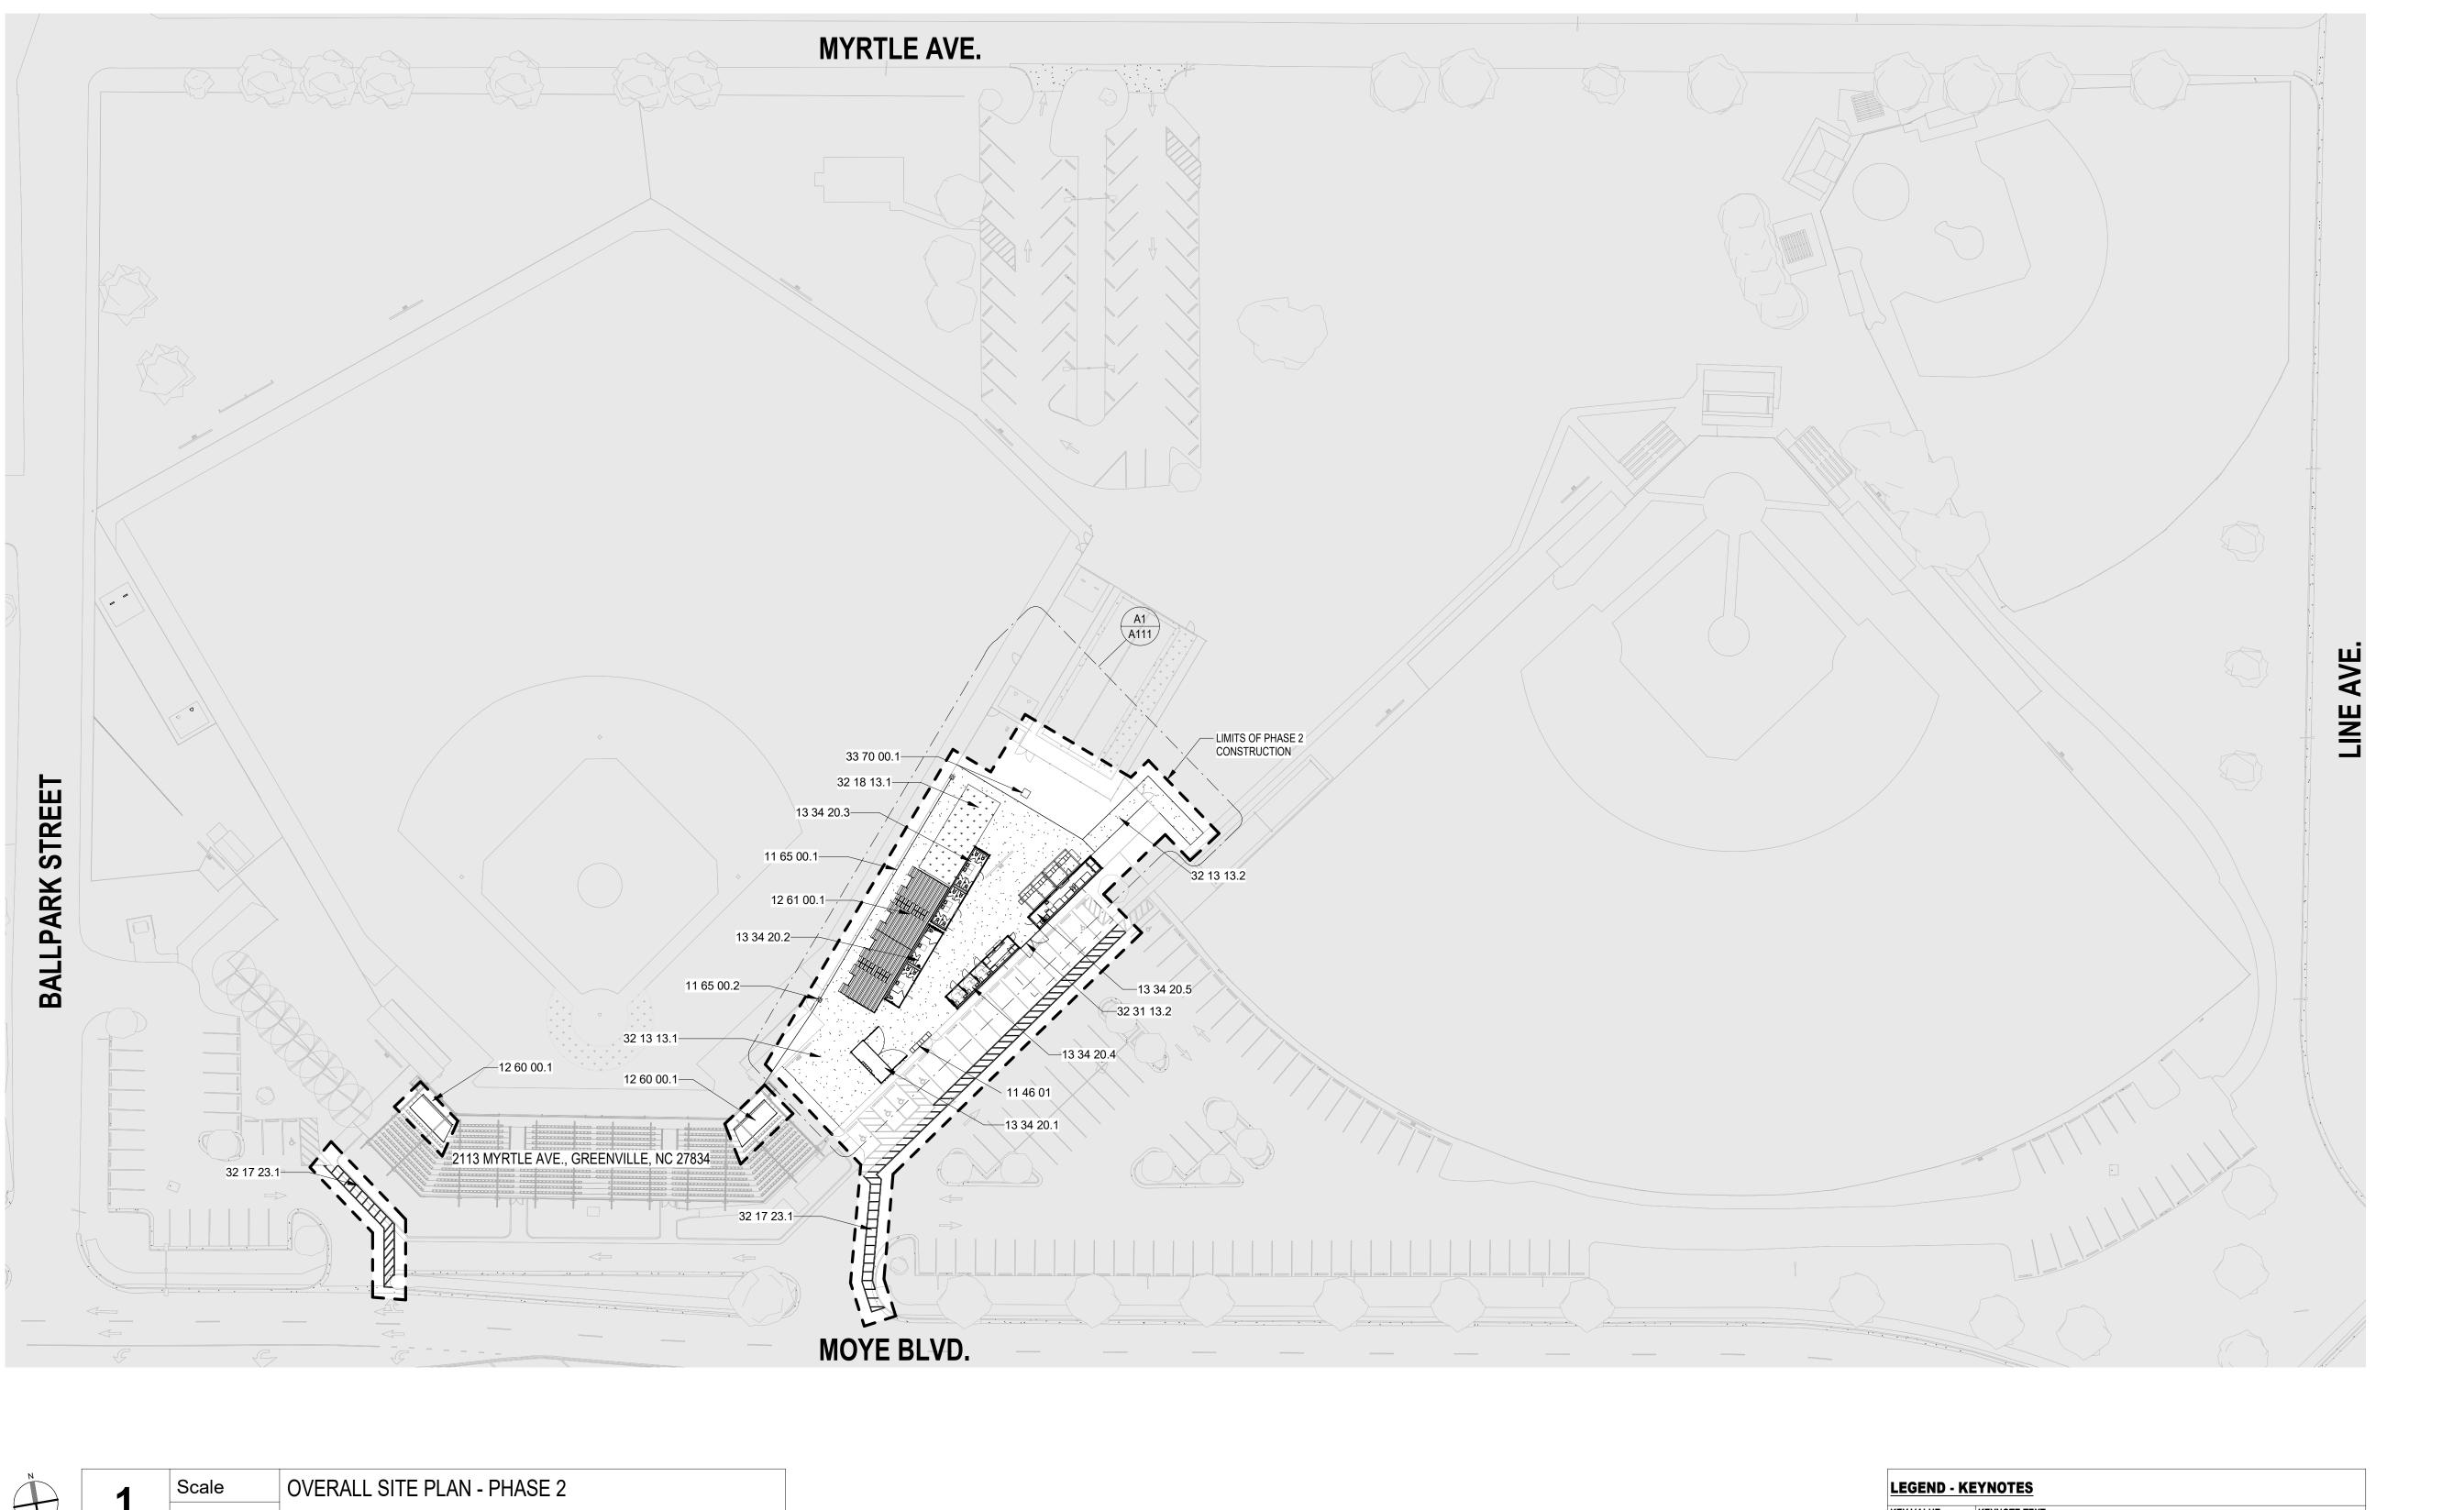

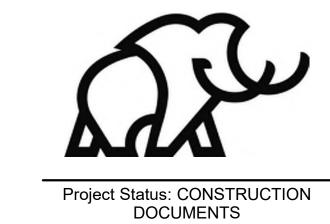
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Project Manager: Project Architect: Project Number: 23-0176 Date of Issue: Issue Date: 9/20/2023


DEMO. SITE PLAN -PHASE 2



1" = 40'-0"

KEYNOTE TEXT MOBILE POS - DTG OPEN CONFIGURATION SPORTS NETTING 11 65 00.1 NETTING POLE PER MFG SEAT COVERS - FIRST FOUR ROWS BLEACHERS PER BELSON OUTDOORS OR APPROVED ALTERNATE - MODEL:BD-1033C - NON-ELEV. 10 ROW X 33'-0" W/ WHEELCHAIR CUTOUTS ADDED CONTAINER 1 - 20' X 8' TEAM STORE CONTAINER 2 - 40' X 8' RESTROOM CONTAINER W/ 3 WOMEN'S, INCLUDING ADA TOILETS, 3 MEN'S, INCLUDING ADA, TOILETS, AND LAVATORIES CONTAINER 3 - 40' X 8' RESTROOM CONTAINER W/ 8 WOMEN'S TOILETS AND 4 CONTAINER 4 - 40' X 8' 3 FAMILY TOILETS AND CONCESSIONS W/ 2 POS CONTAINER 5 - 40' X 8' KITCHEN/PASS THROUGH RE: PHASE 2 CIVIL SITE PLAN FOR LOCATION AND SPECIFICATIONS OF SOG 32 13 13.2 RE: PHASE 2 CIVIL SITE PLAN FOR LOCATION AND SPECIFICATIONS OF NEW SIDE PATH TO PUBLIC WAY STRIPING 32 18 13.1 RE: CIVIL PHASE 2 - SYNTHETIC TURF AREA RE: CIVIL PHASE 2 - 12' FENCE GATE RE:CIVIL PHASE 2 - RELOCATE TRANSFORMER


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	Revis	ion Key
No.	Date	Description
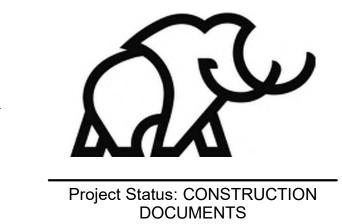
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Project Architect:	
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Checked By:	
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Project Number:	
	23-01
Date of Issue:	
	Issue Date: 9/20/20
Sheet Number:	

AS102 ARCH. SITE PLAN - PHASE



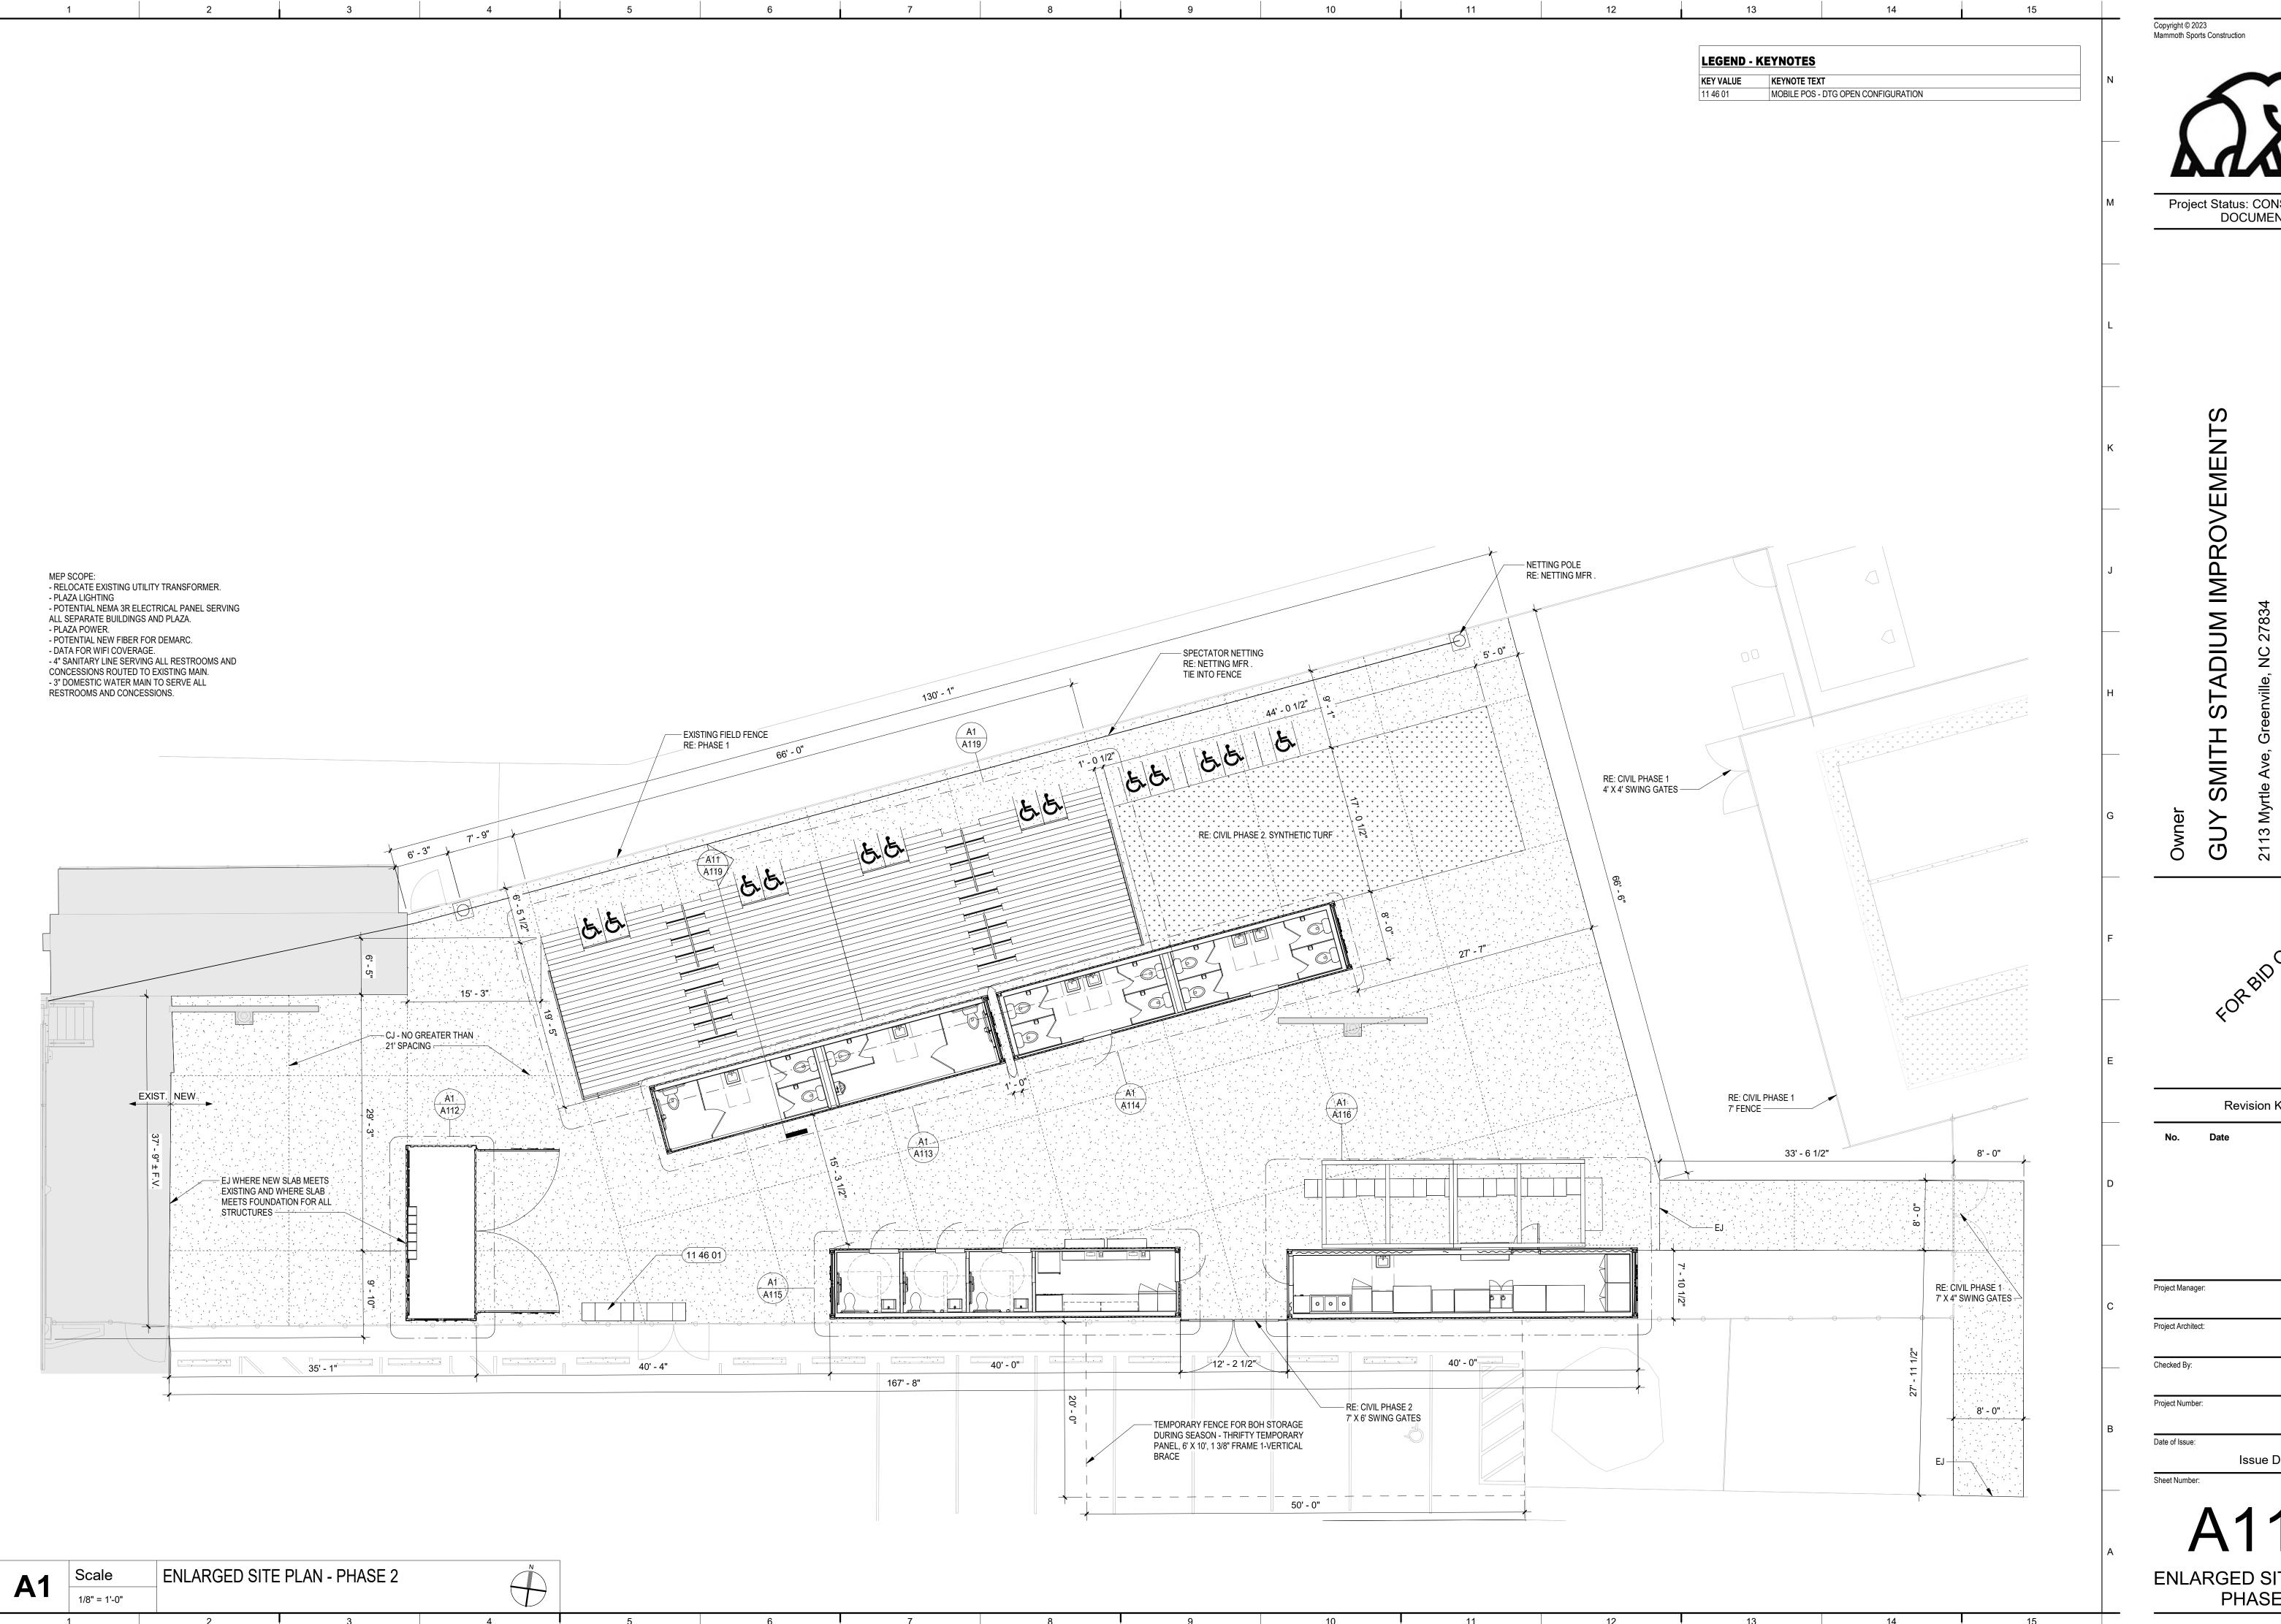


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ENLARGED SITE PLAN -PHASE 2



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1 9/29/23 REV #1

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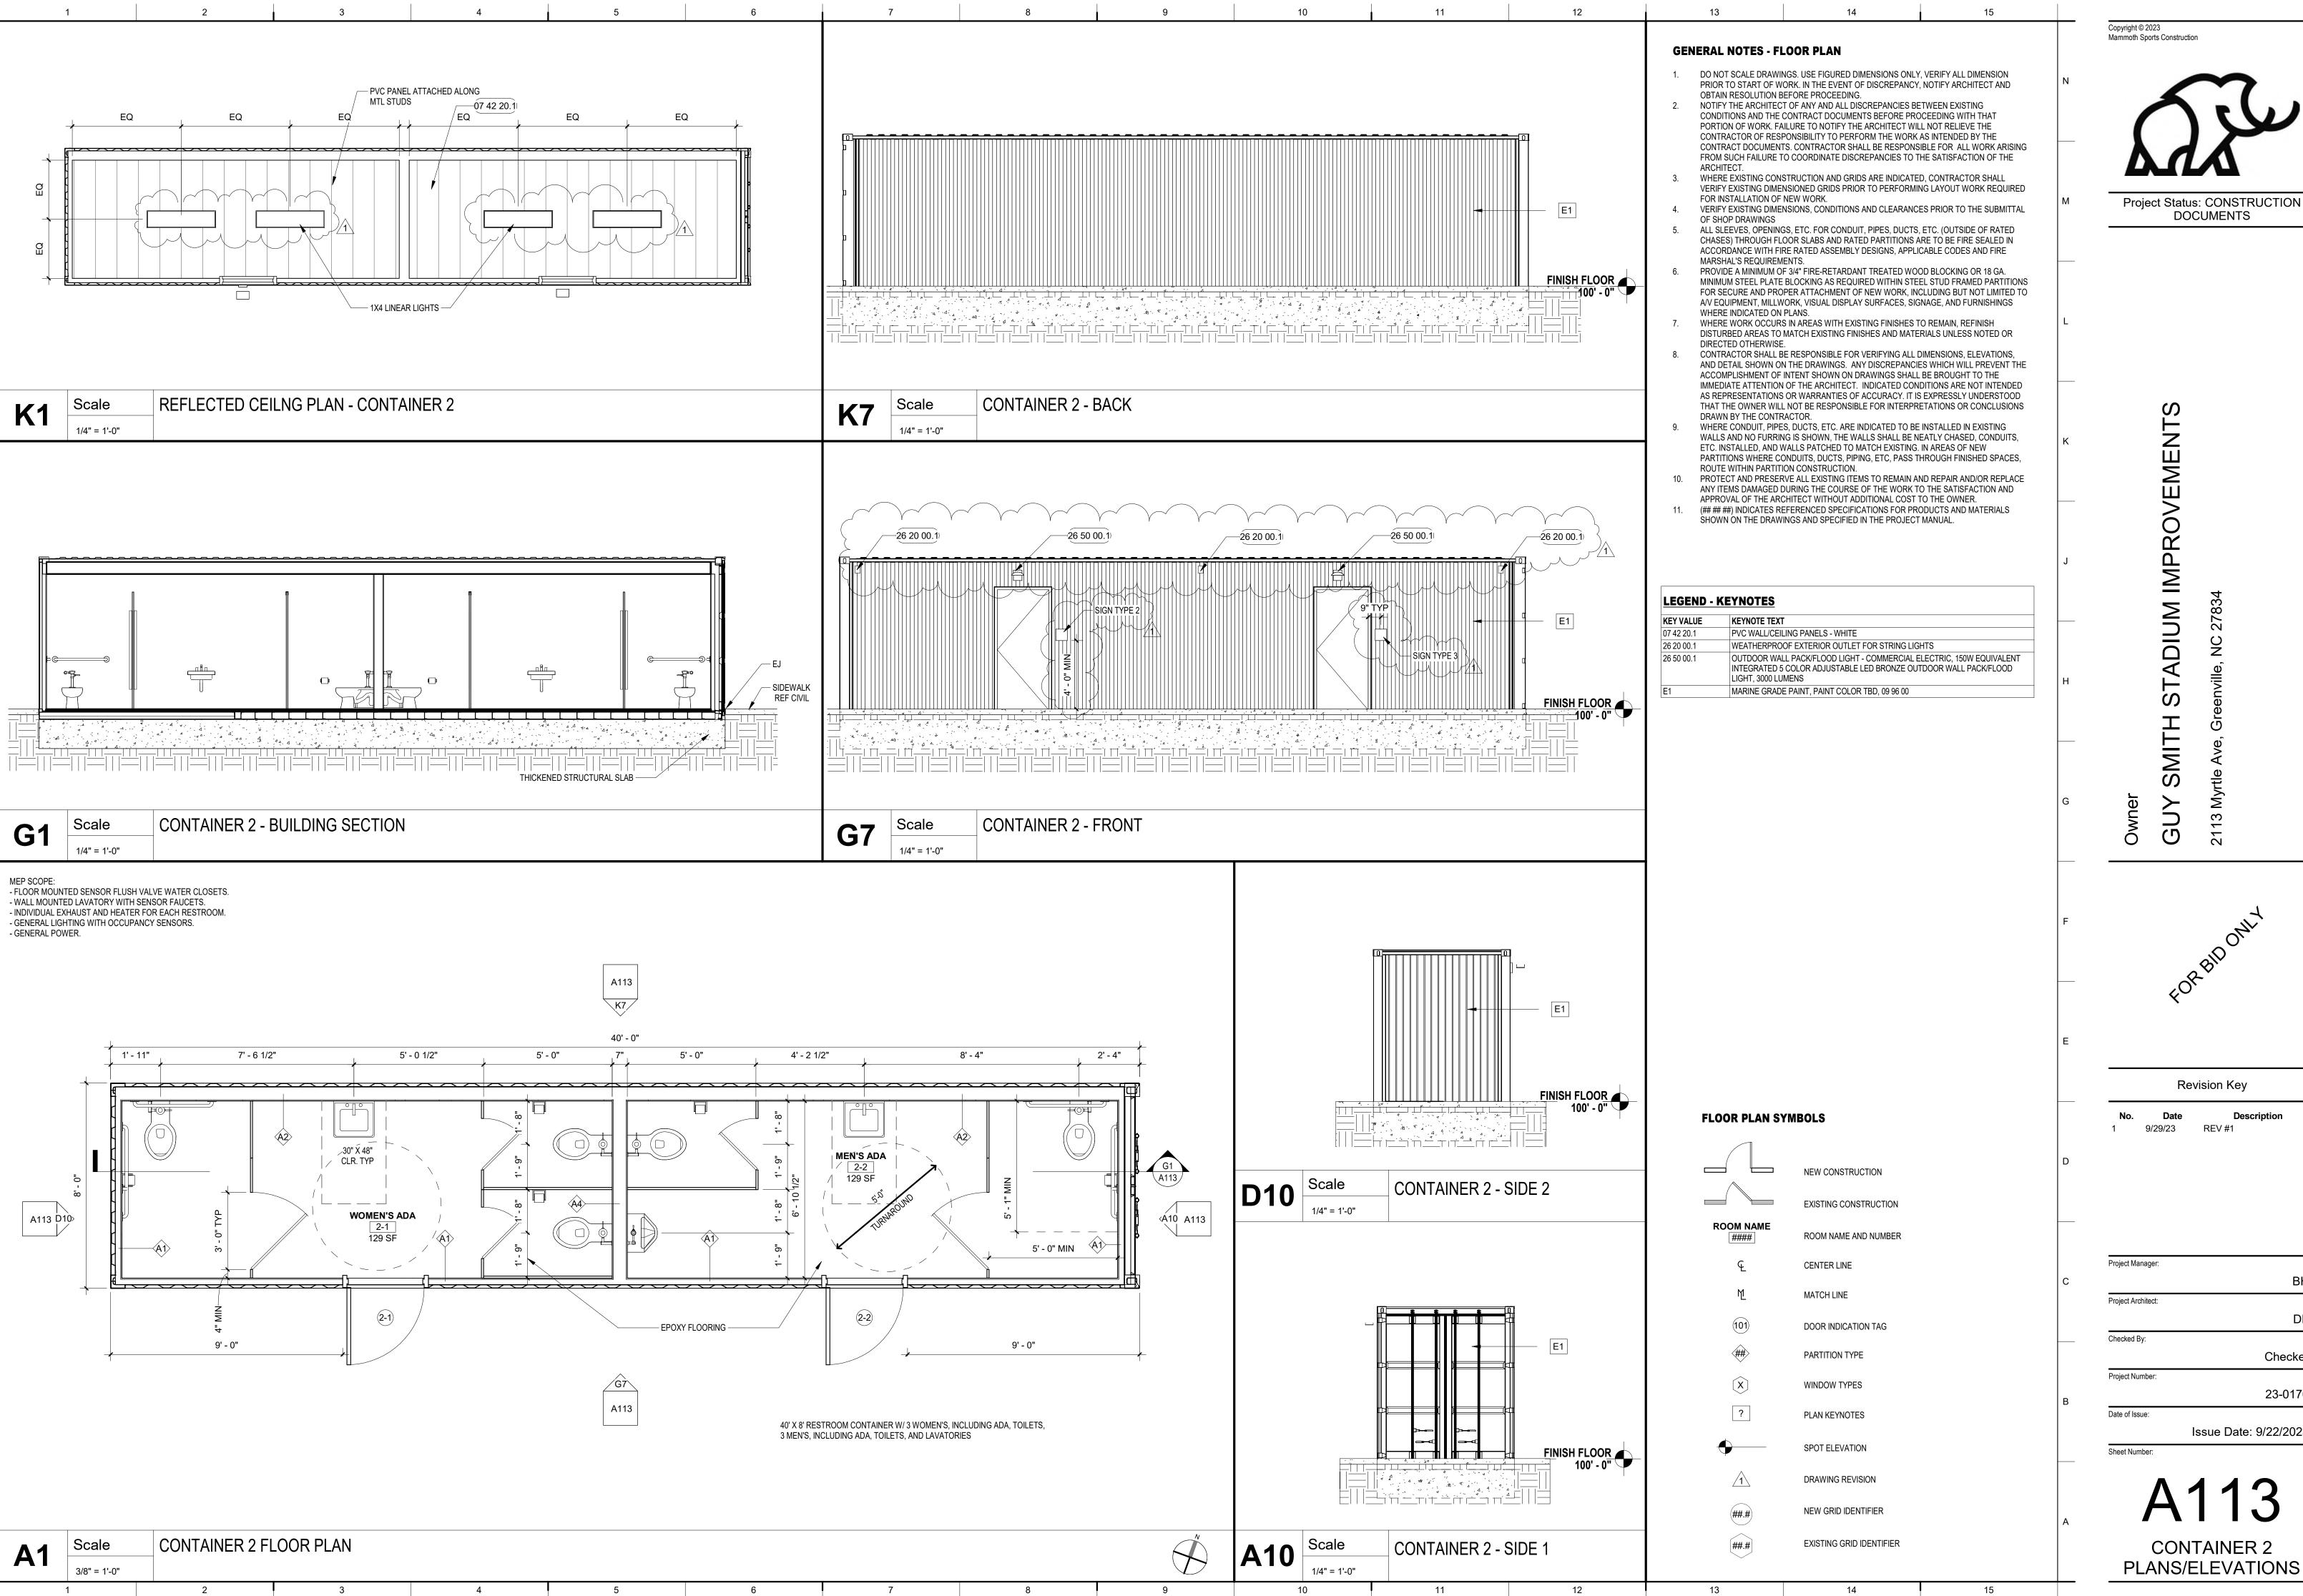
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Issue Date: 9/22/2023
Sheet Number:

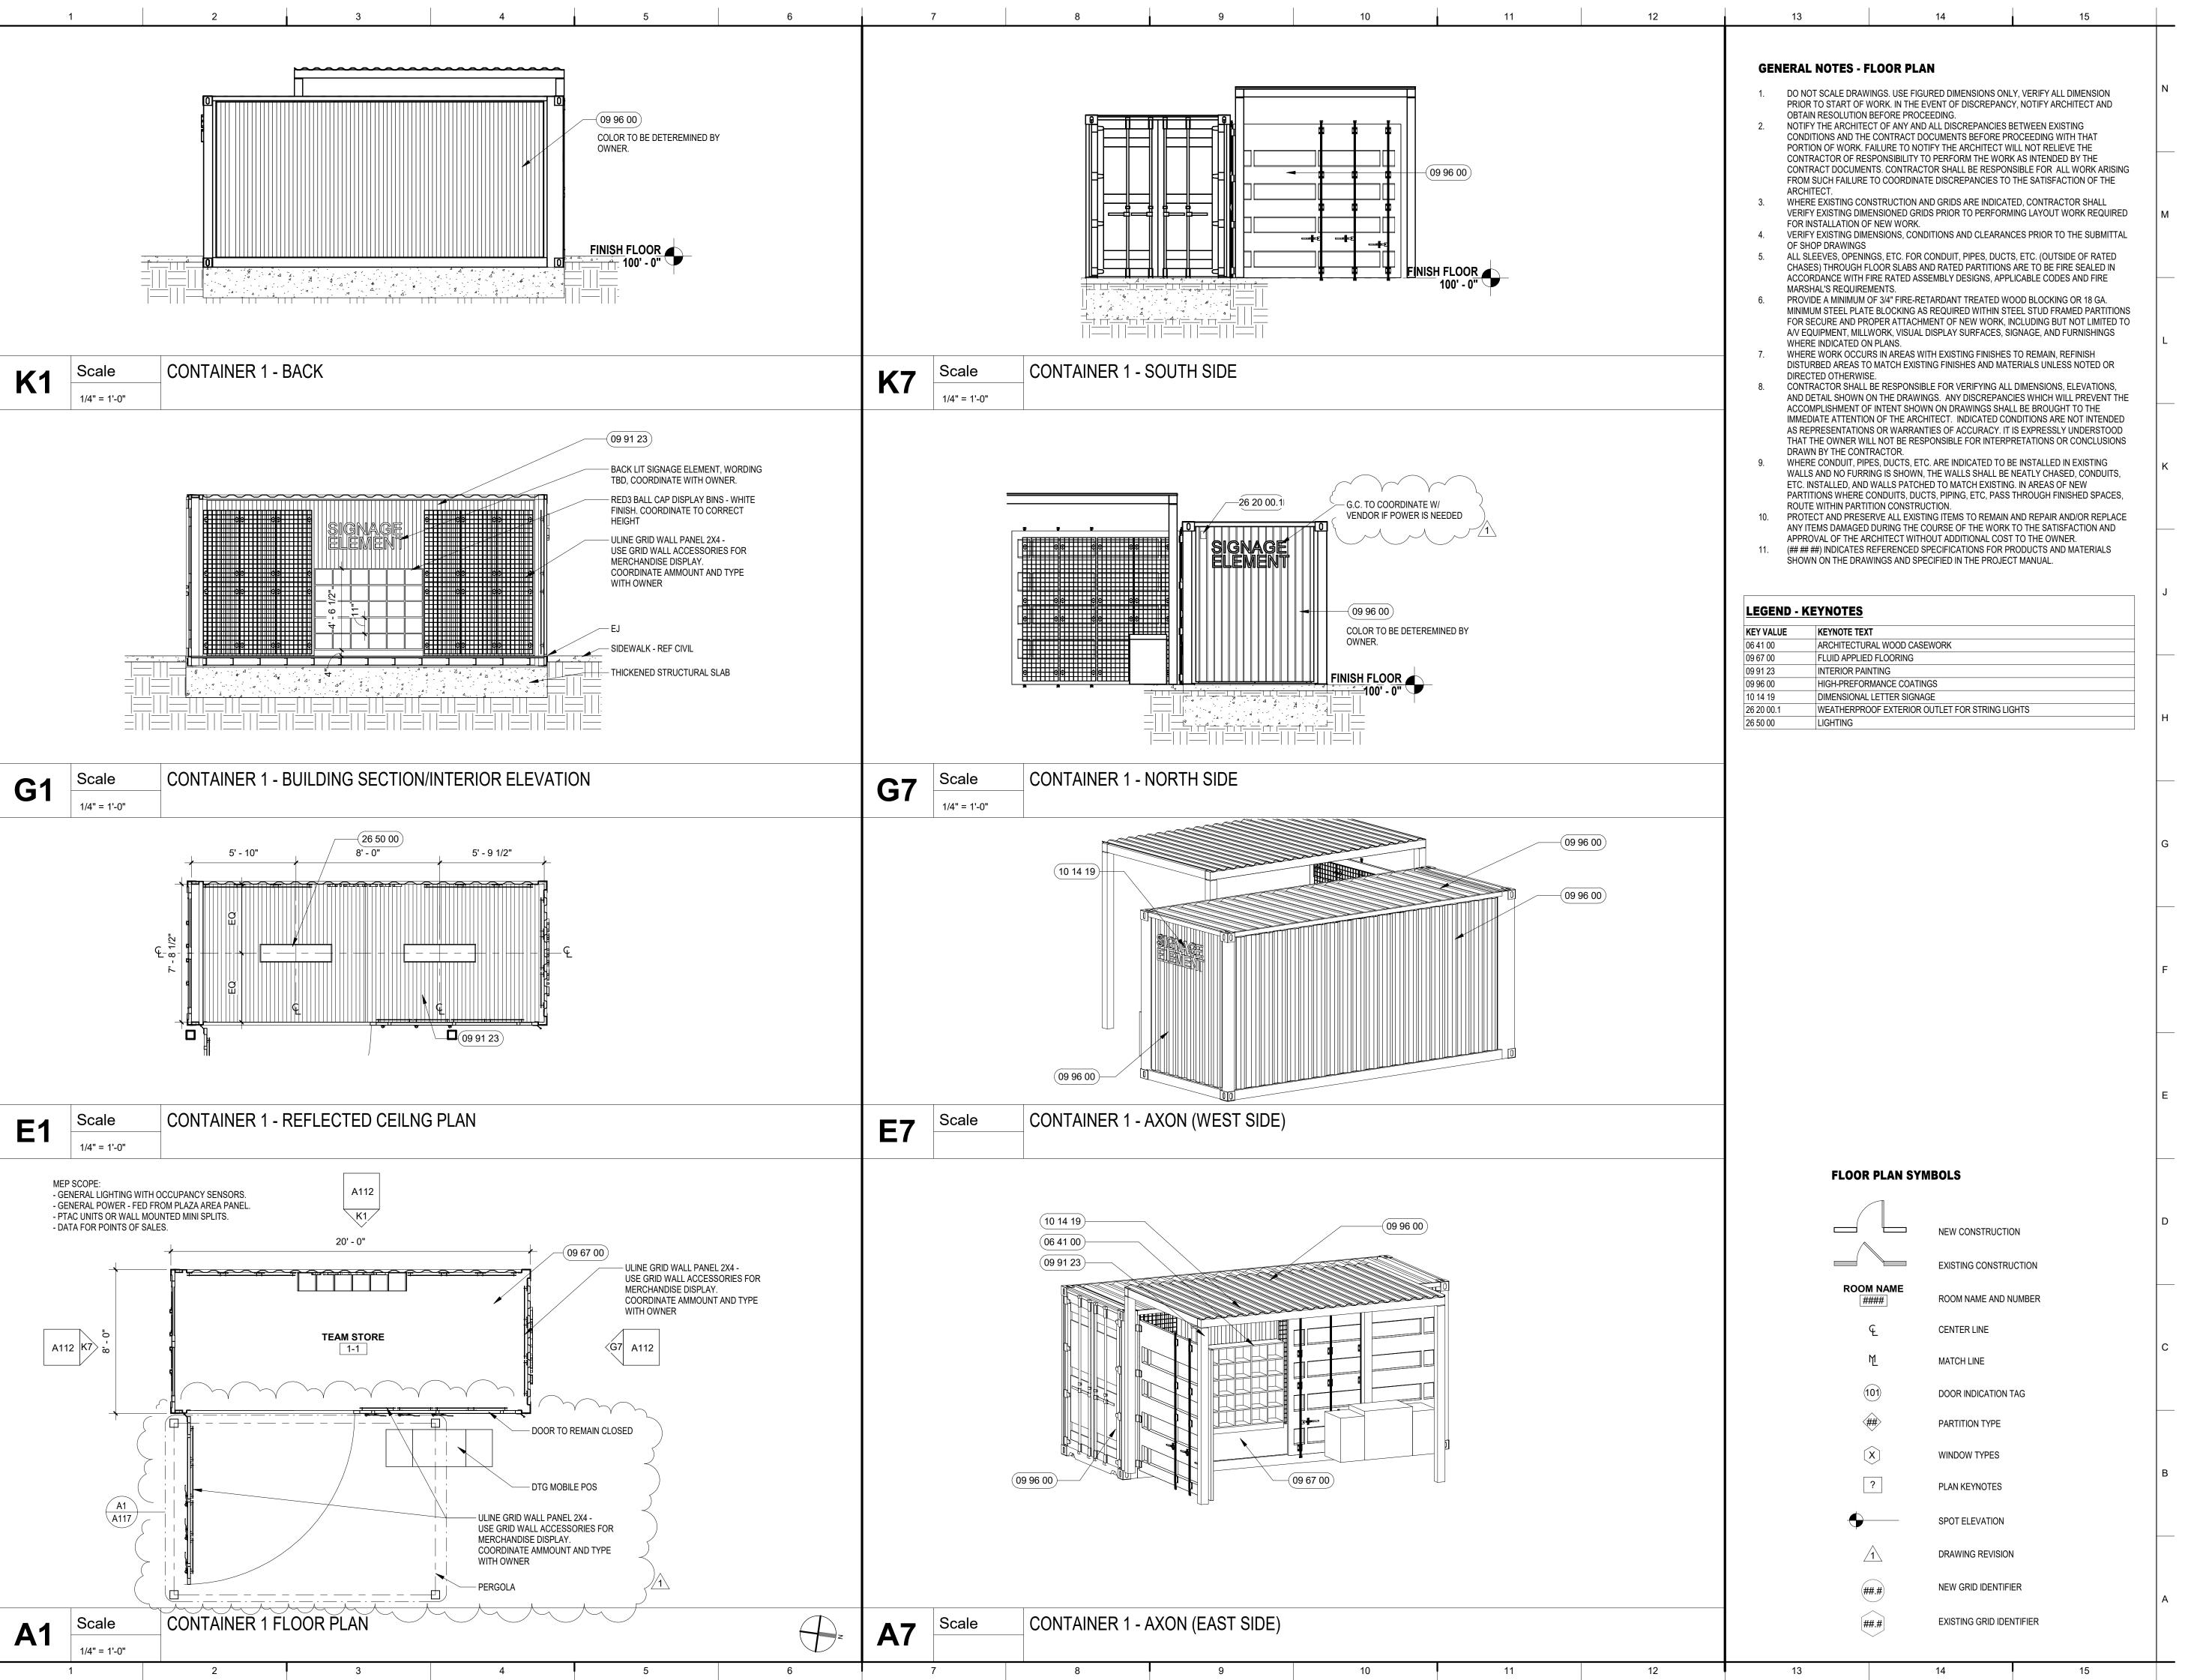CONTAINER 1
PLANS/ELEVATIONS





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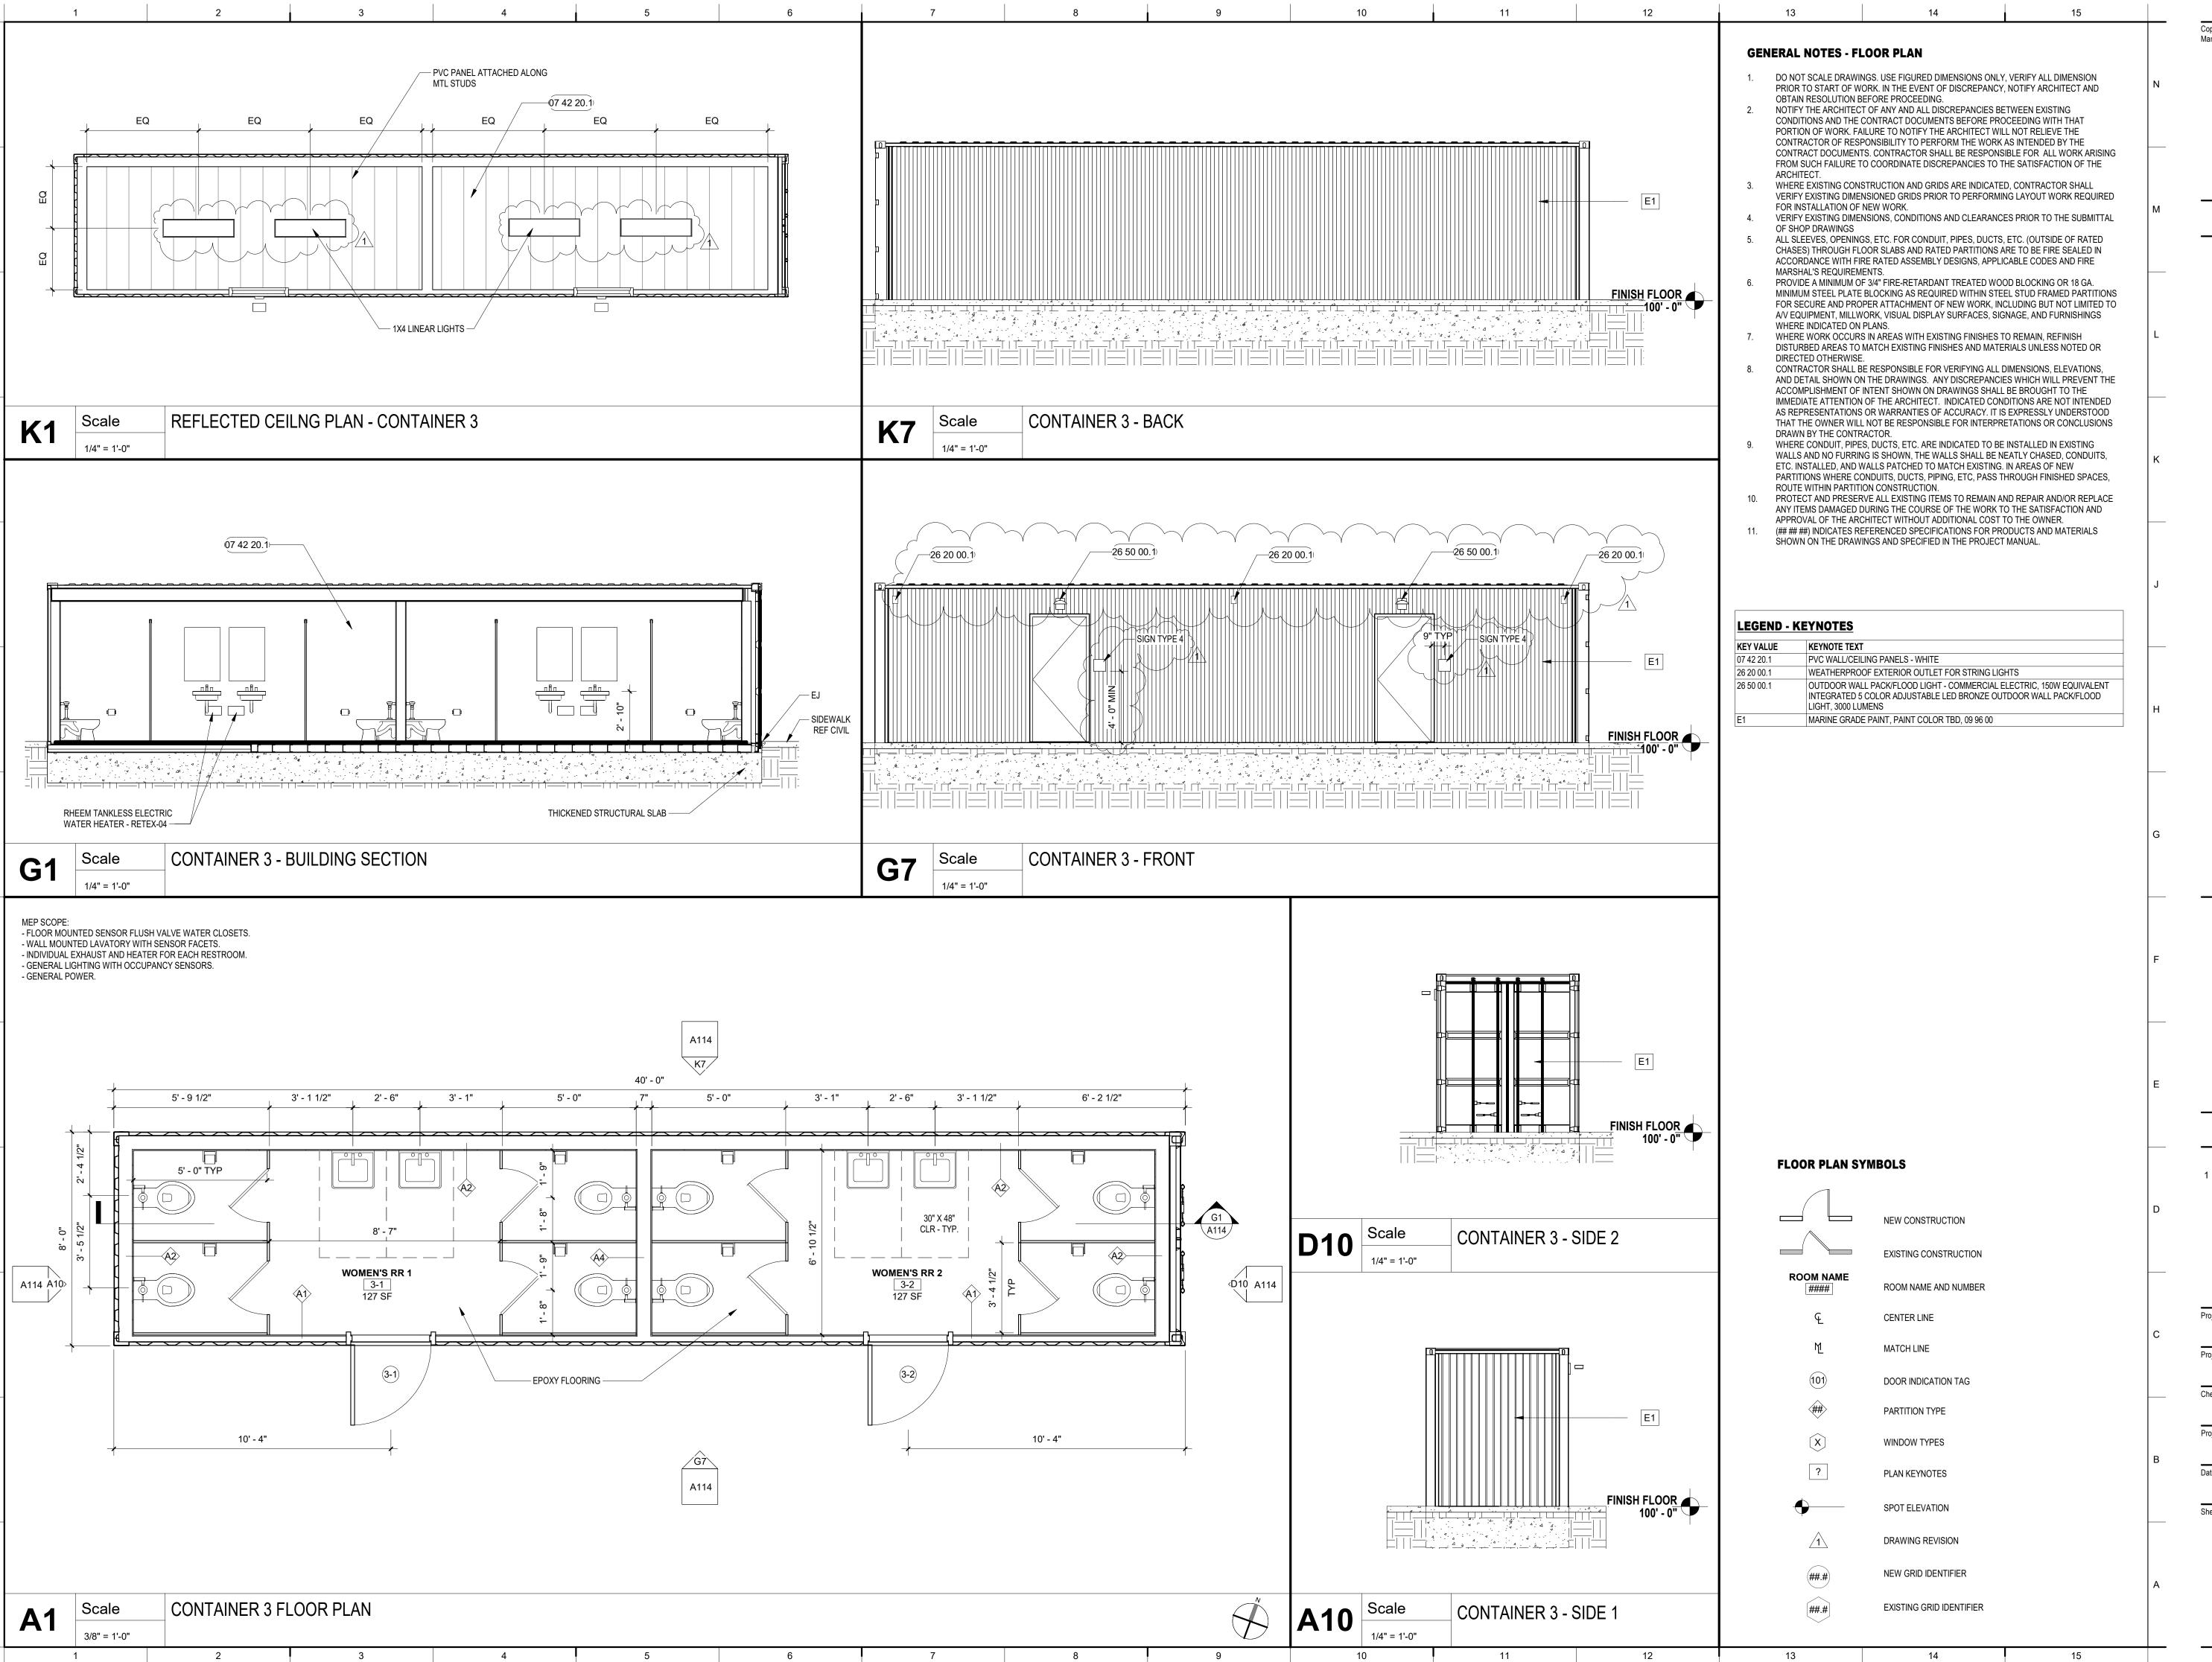
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CONTAINER 2






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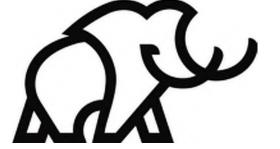
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Project Manager: Project Architect Checked By: Checker Project Number: 23-0176 Date of Issue:

Issue Date: 9/22/2023

CONTAINER 3 PLANS/ELEVATIONS



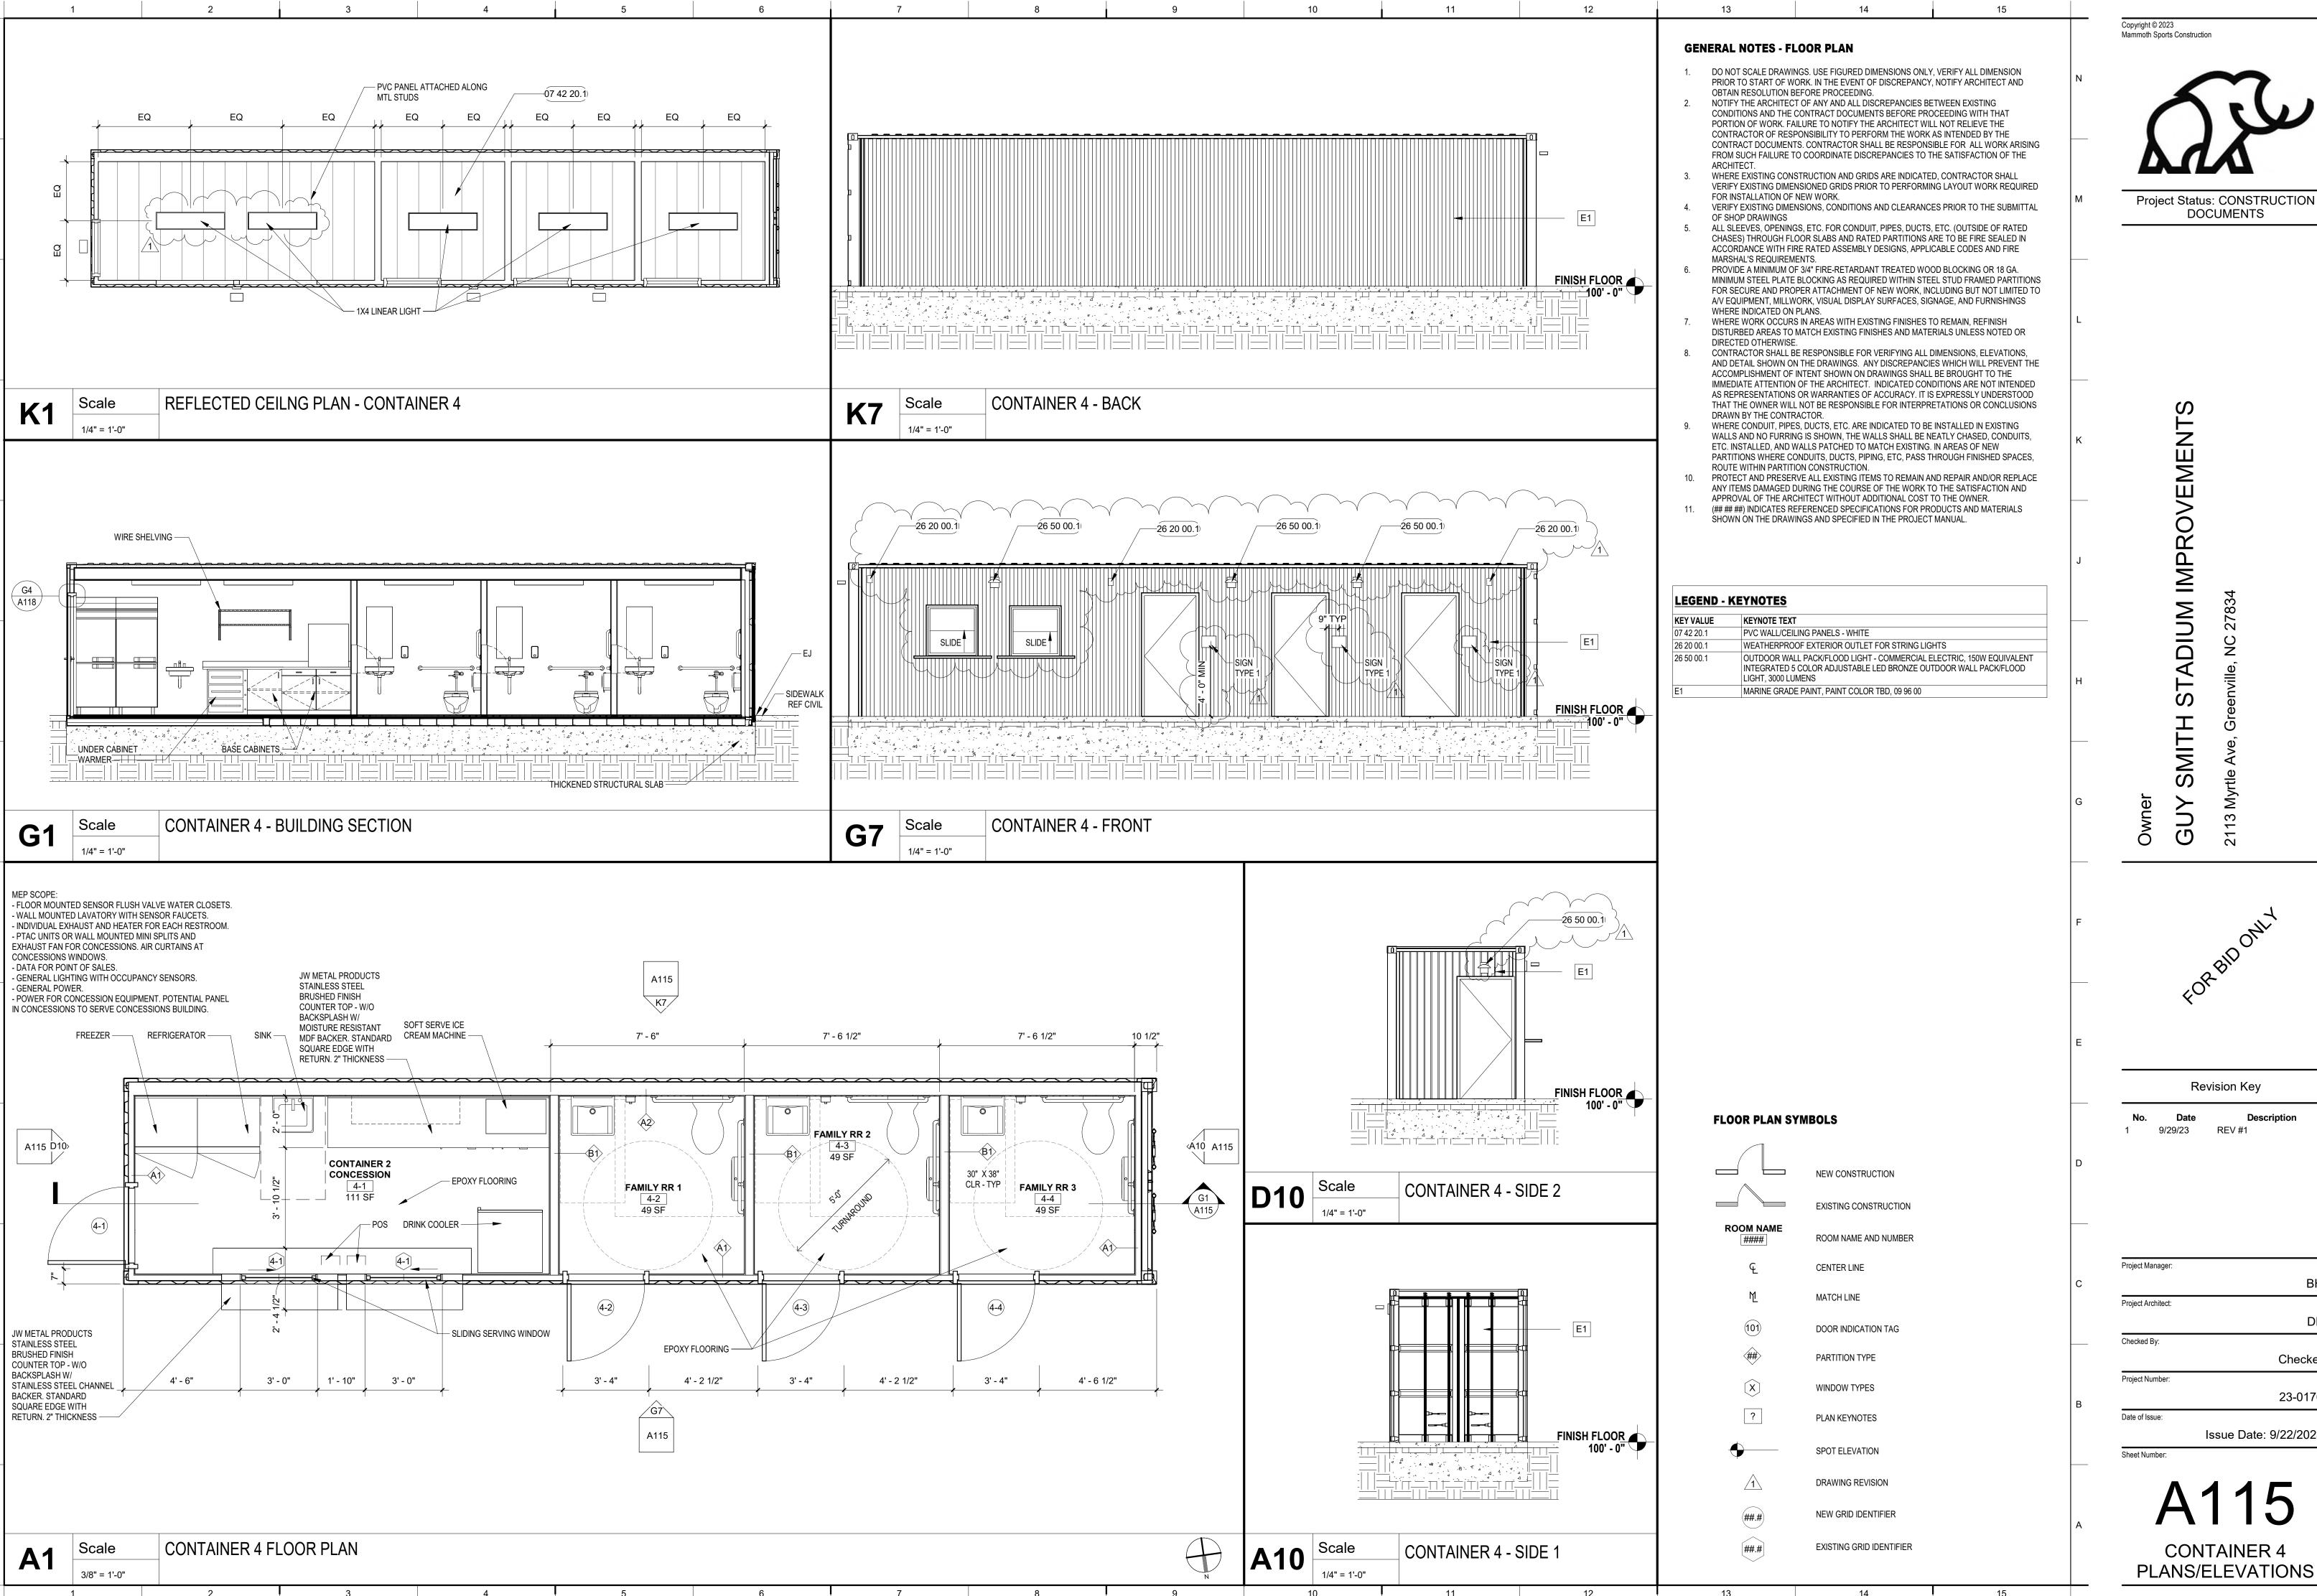


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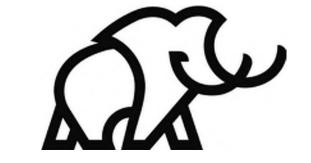
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**CONTAINER 4** 





Project Status: CONSTRUCTION DOCUMENTS

UY SMITH STADIUM IMPROVEMENTS
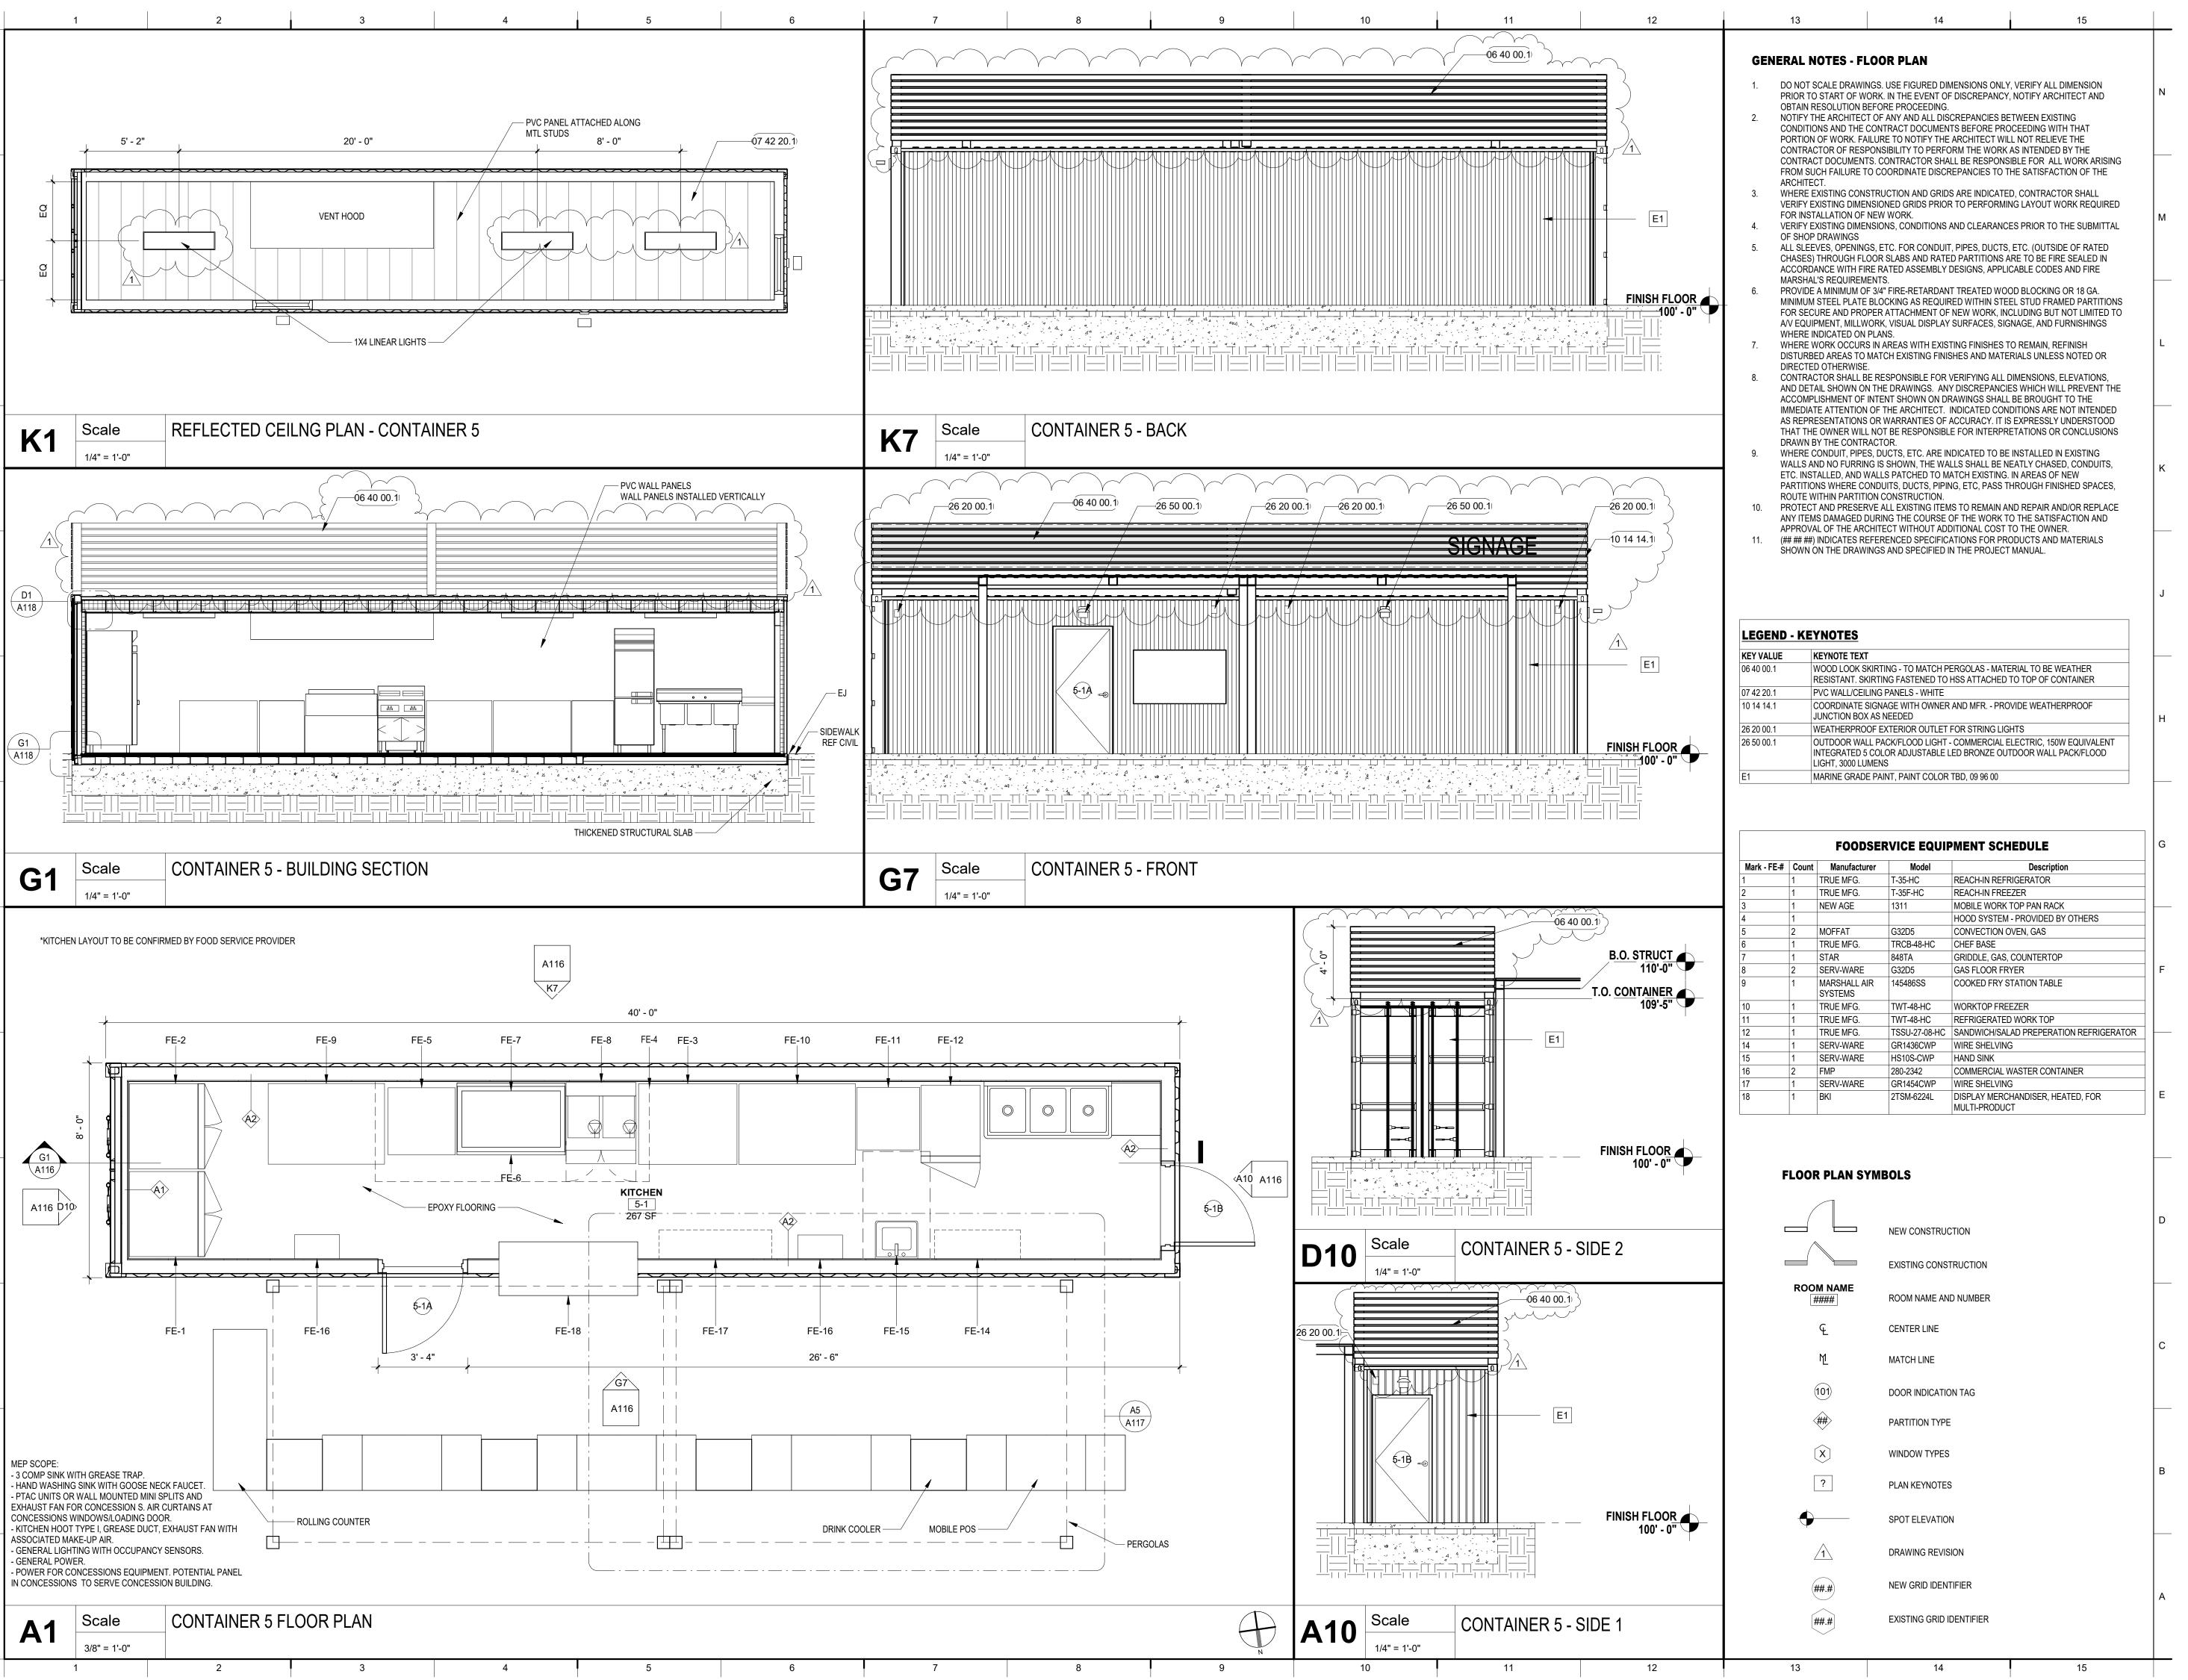
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Project Manager:

BH

Project Architect:

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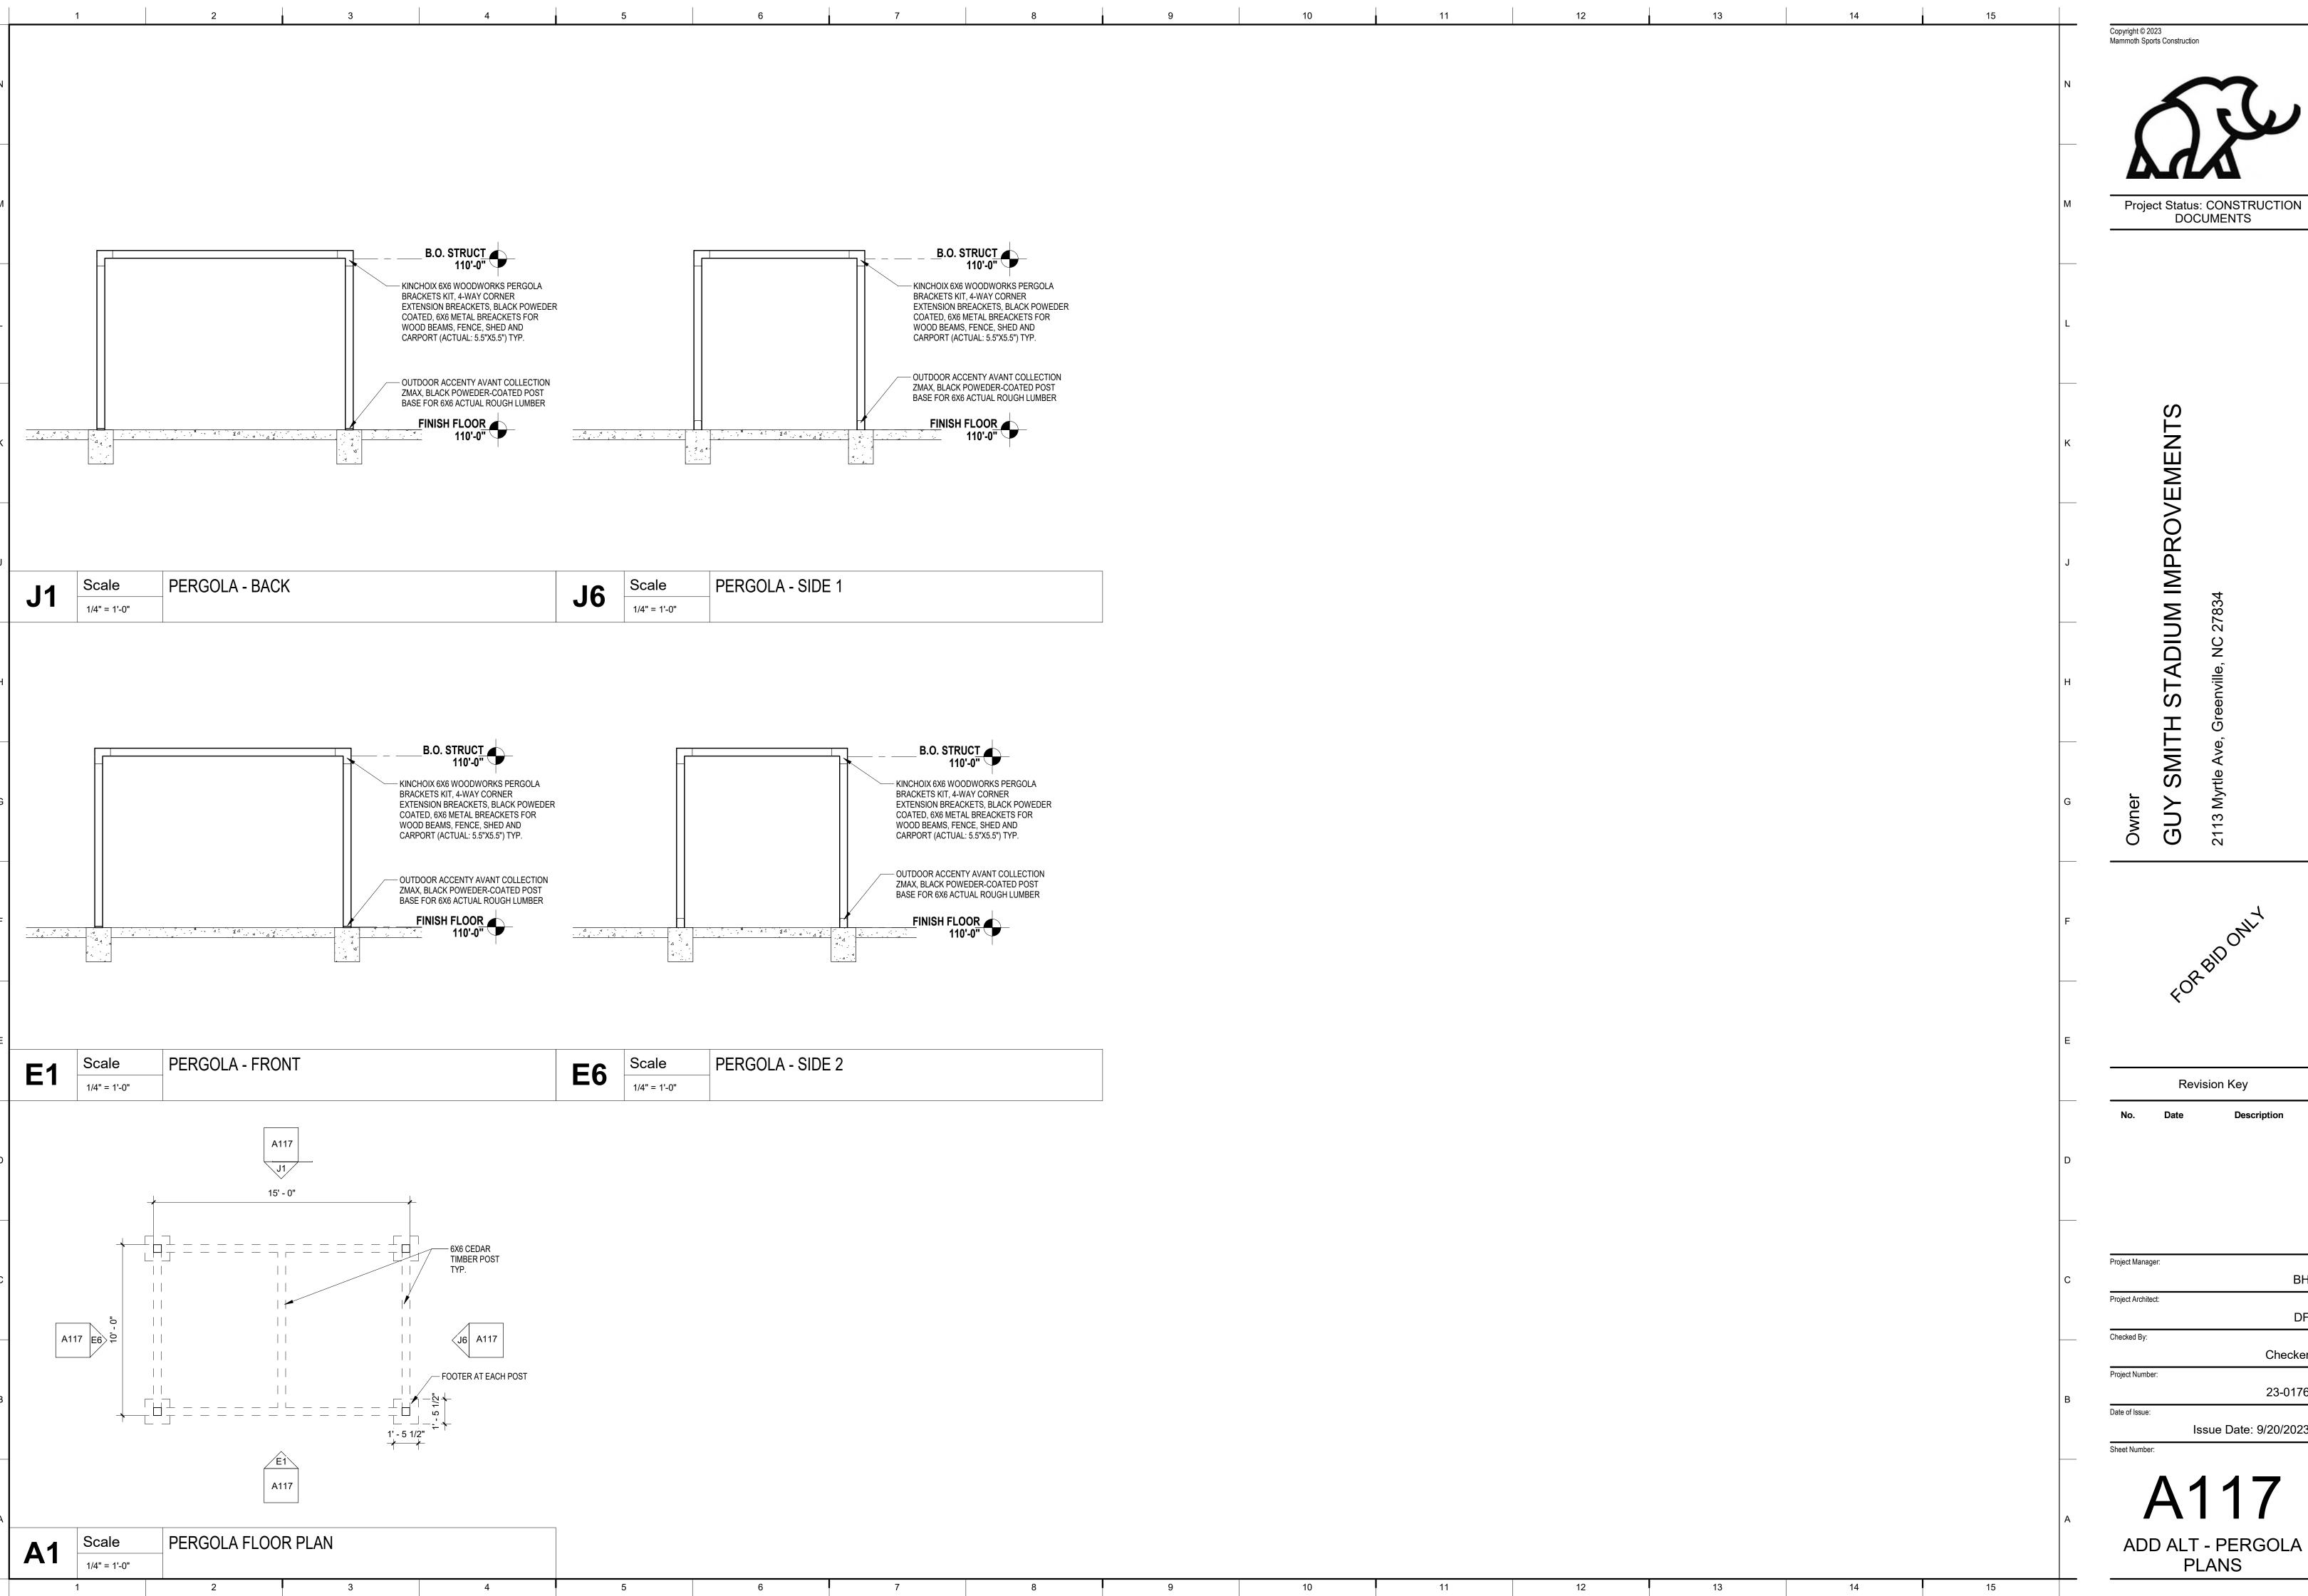
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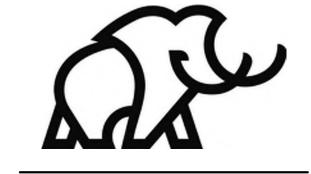
Date of Issue:

Issue Date: 9/22/2023

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ADD ALT - CONTAINER 5 PLANS/ELEVATIONS





O D 2


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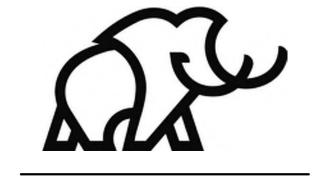
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ADD ALT - PERGOLA

**PLANS** 



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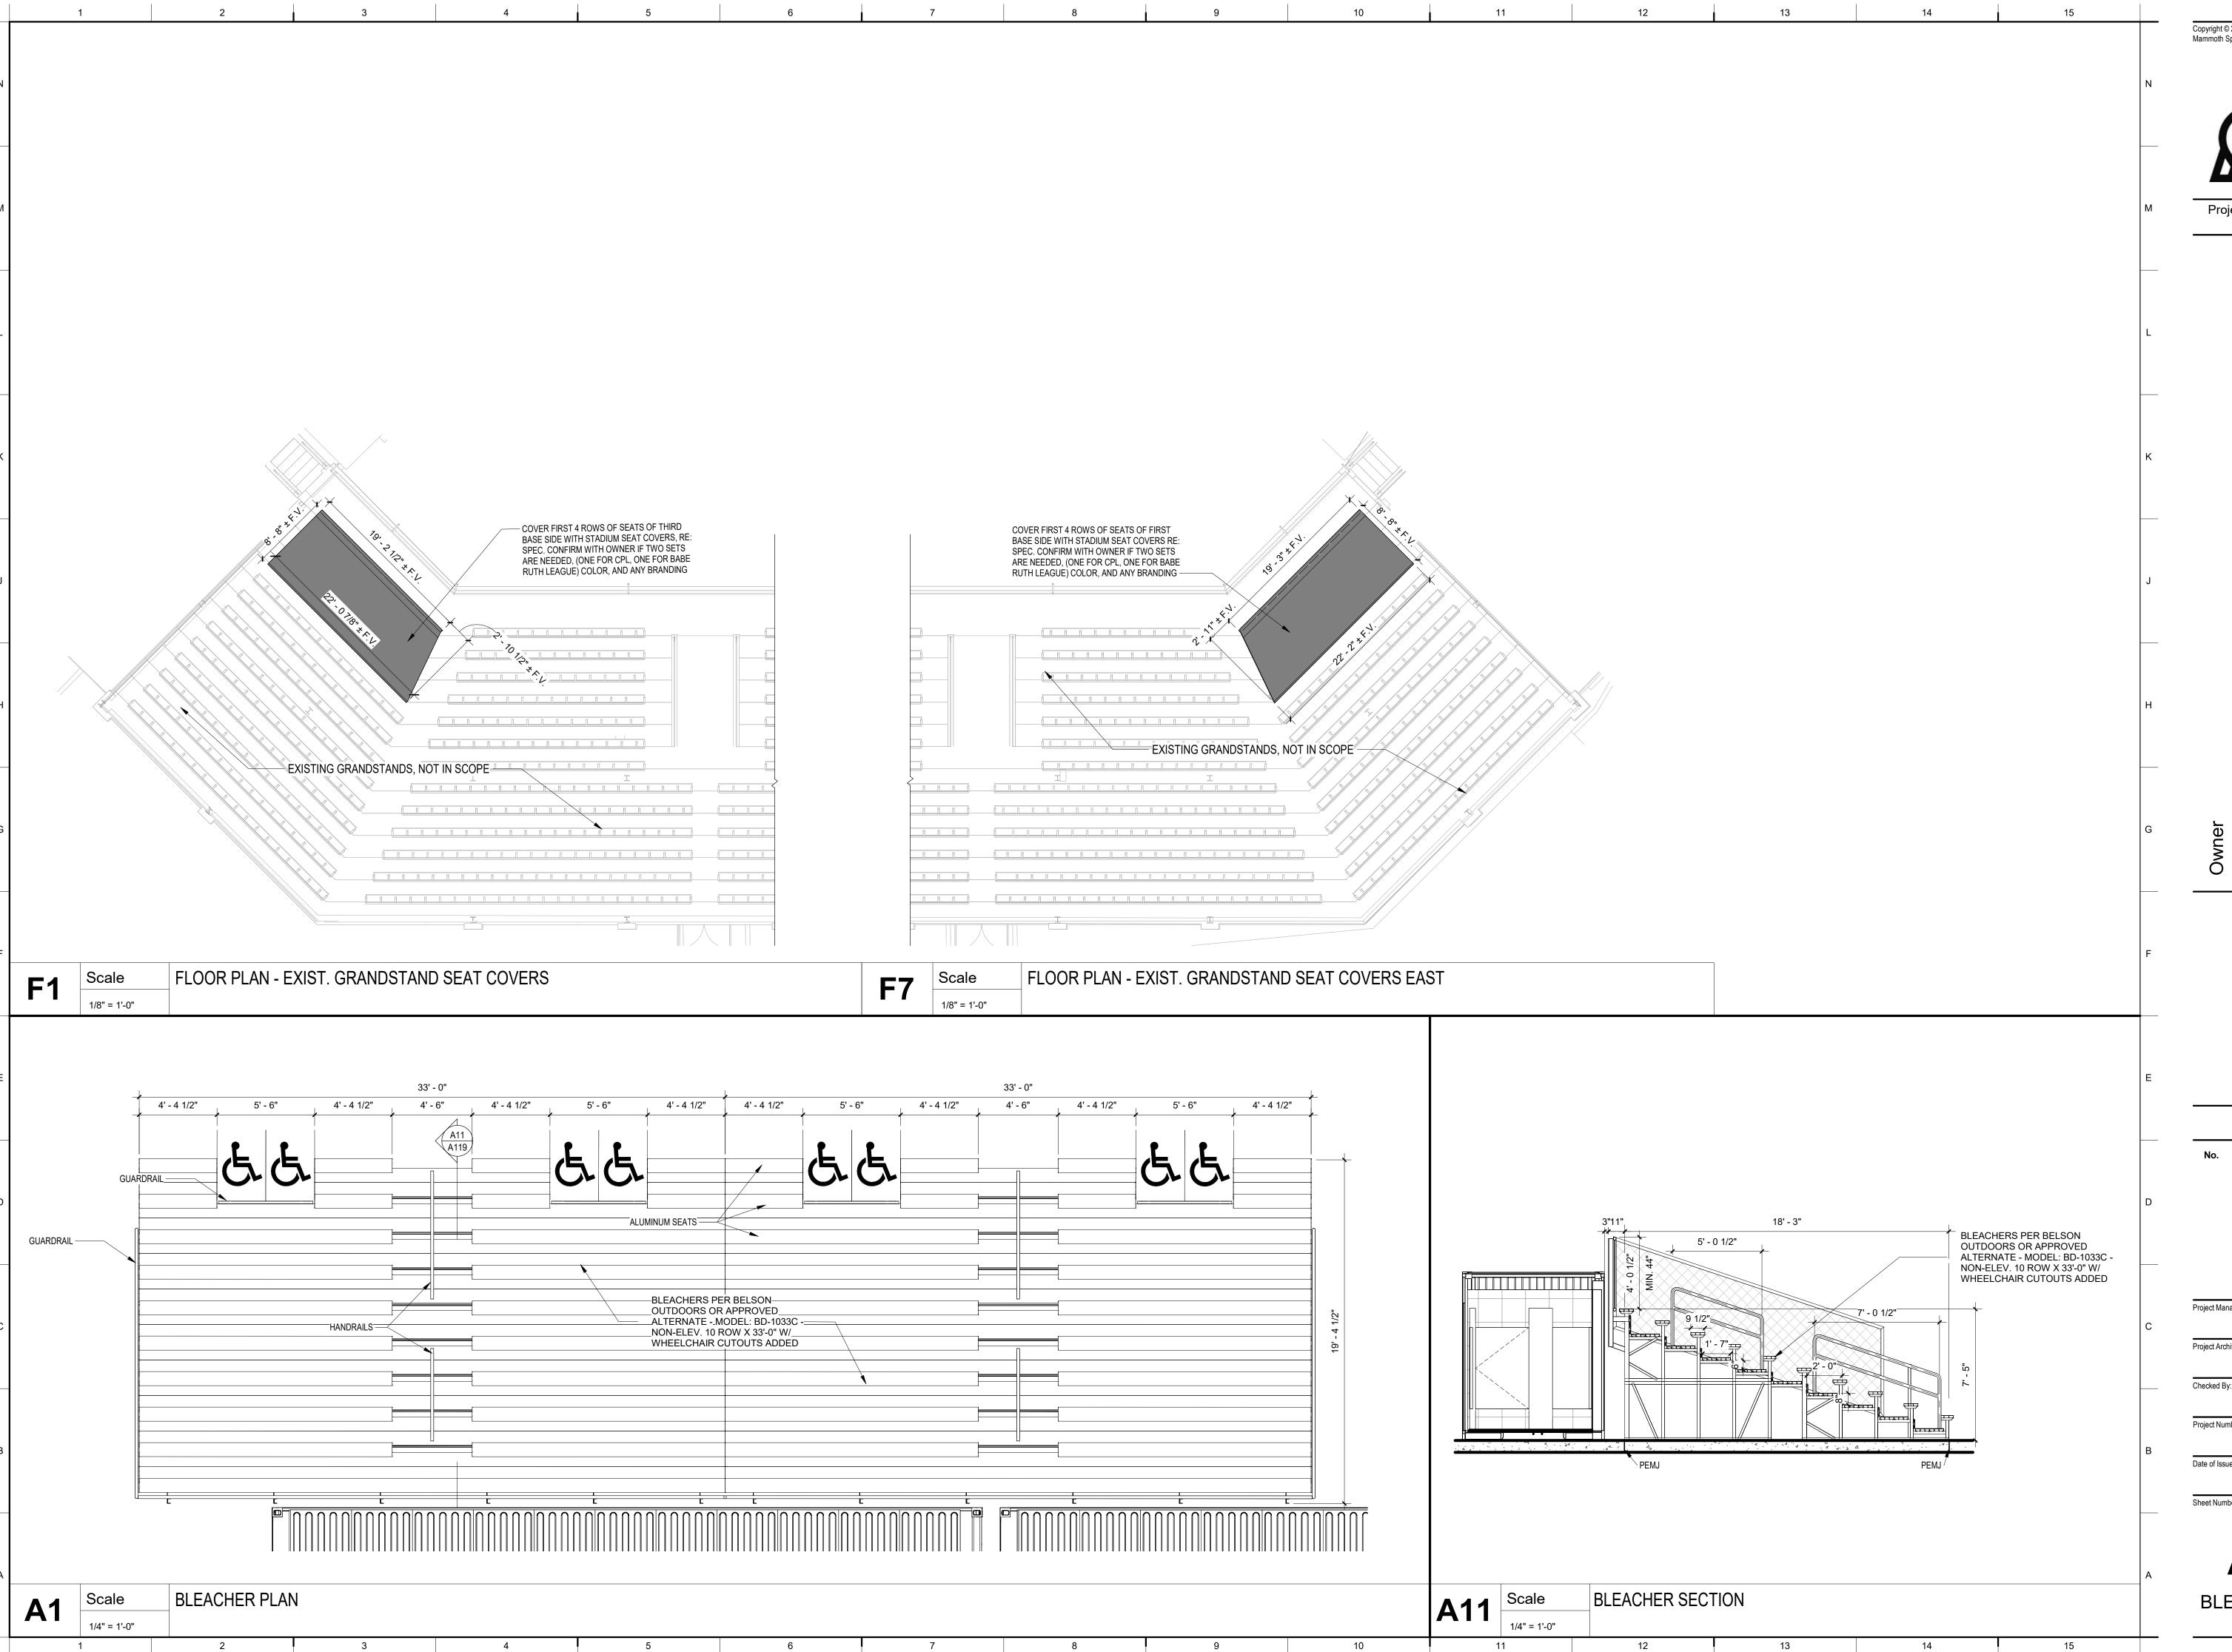



DOCUMENTS

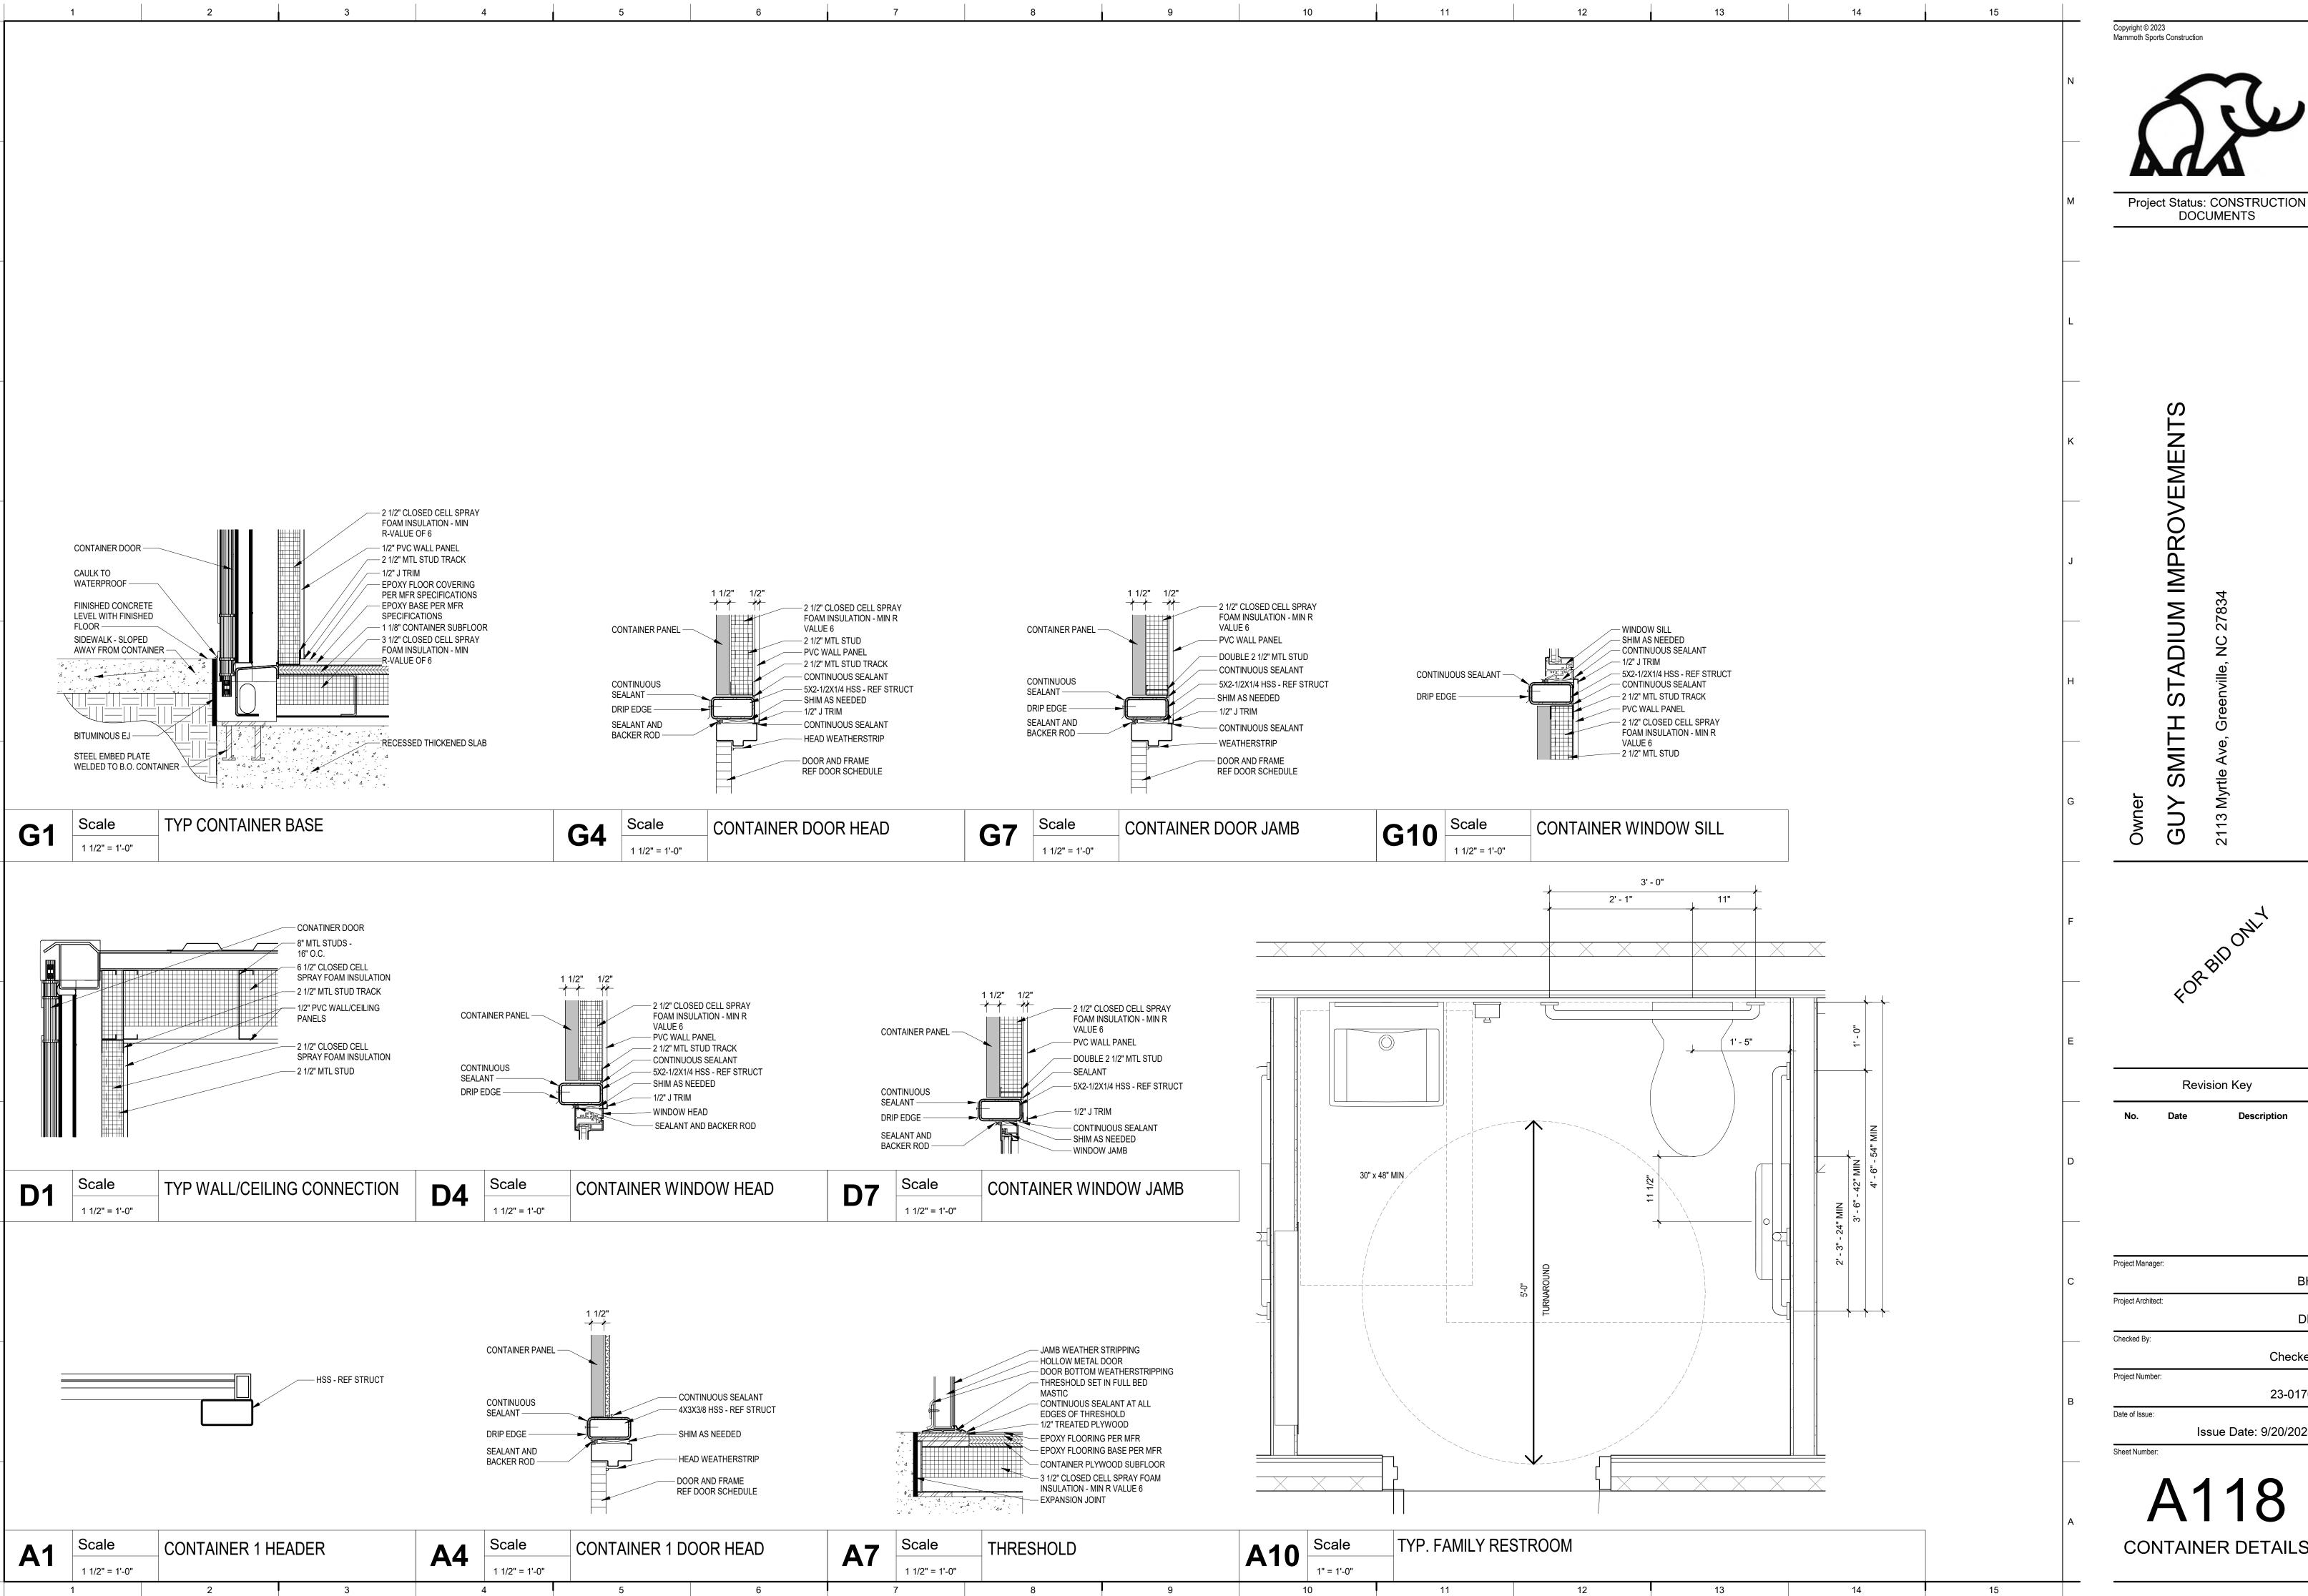Revision Key Description

Project Manager: Project Architect: Checker 23-0176 Issue Date: 9/20/2023

**CONTAINER DETAILS** 



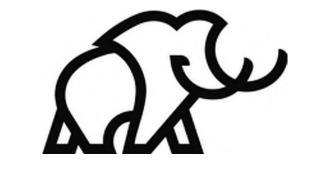


Project Status: CONSTRUCTION DOCUMENTS

Revision Key

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Issue Date: 9/20/2023

BLEACHER PLAN AND SECTION

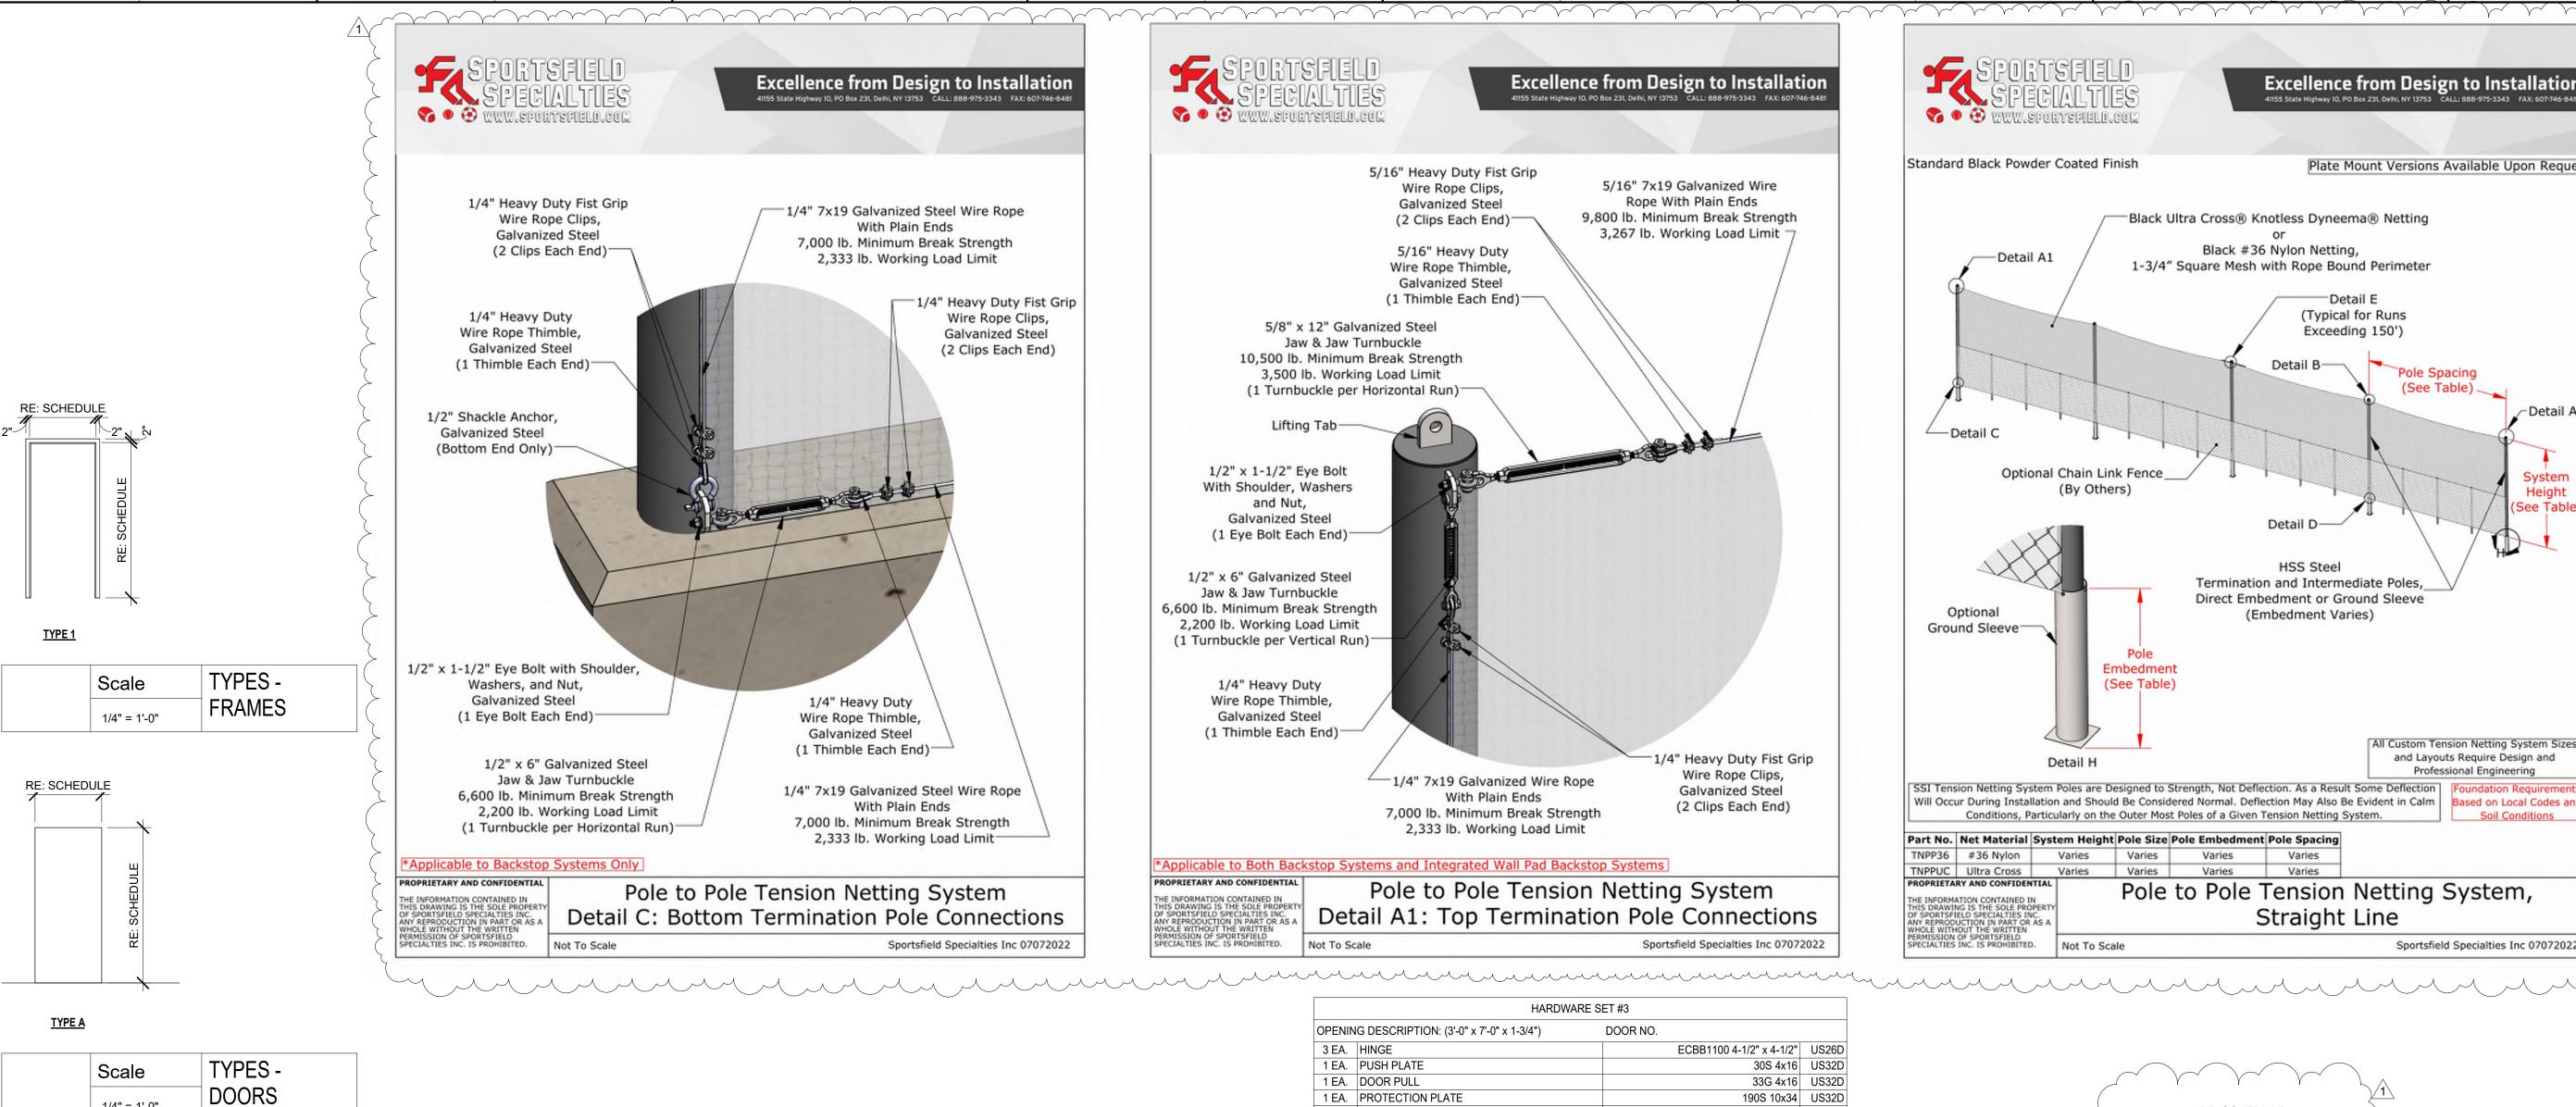

METAL

METAL

METAL

N/A

N/A

N/A

N/A

N/A

**THICKNESS** 

1 3/4"

1 3/4"

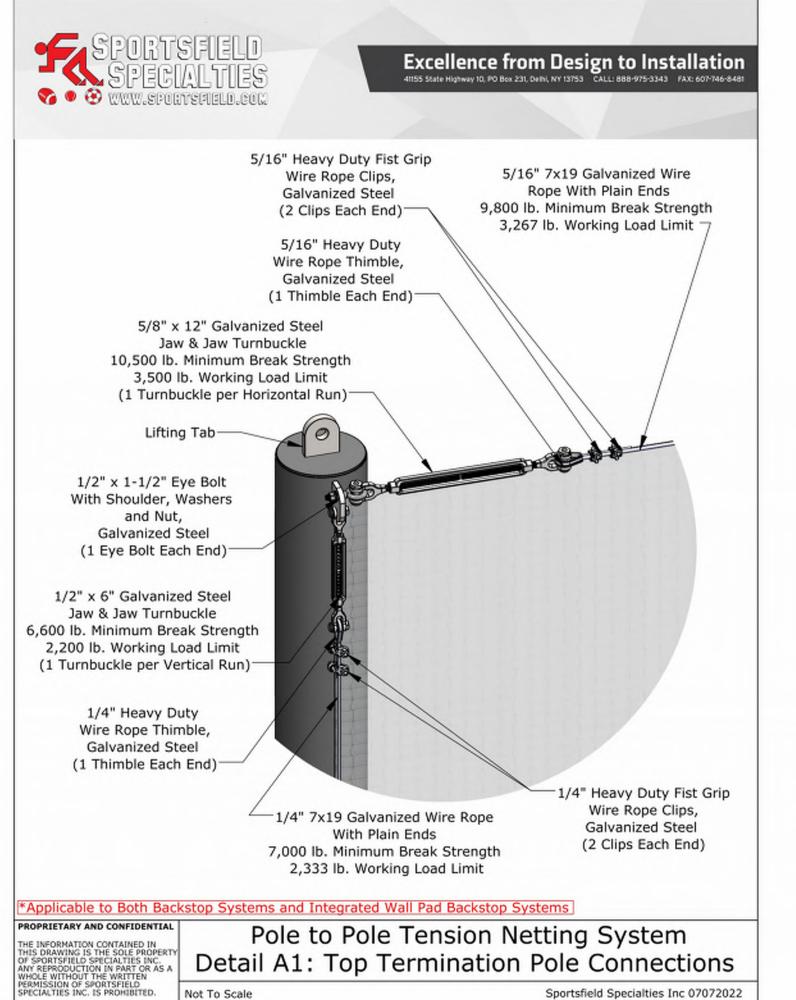

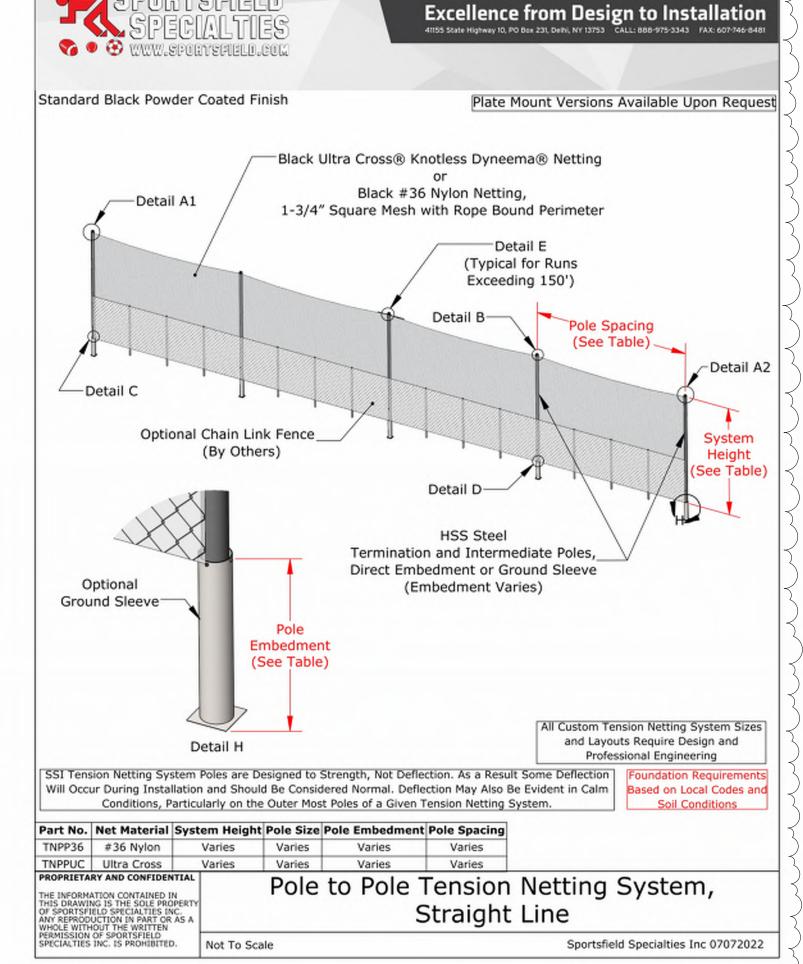

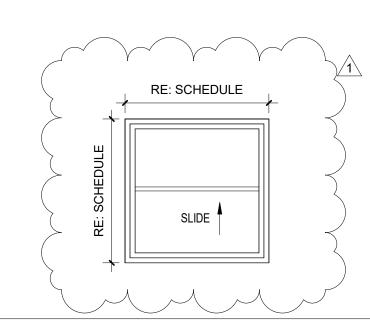

WINDOW SCHEDULE						
Type Mark	Width	Height	Manufacturer	Description		
4-1	3' - 0"	3' - 0"	JELD-WEN	35.5" X 35.5" V-2500 SERIES WHITE VINYL SINGLE HUNG WINDOW WITH FIBERGLASS MESH SCREEN		
4-1	3' - 0"	3' - 0"	JELD-WEN	35.5" X 35.5" V-2500 SERIES WHITE VINYL SINGLE HUNG WINDOW WITH FIBERGLASS MESH SCREEN		
4-1	3' - 0"	3' - 0"	JELD-WEN	35.5" X 35.5" V-2500 SERIES WHITE VINYL SINGLE HUNG WINDOW WITH FIBERGLASS MESH SCREEN		
4-1	3' - 0"	3' - 0"	JELD-WEN	35.5" X 35.5" V-2500 SERIES WHITE VINYL SINGLE HUNG WINDOW WITH FIBERGLASS MESH SCREEN		

DOOR &	DOOR & FRAME SCHEDULE							
	FRAME							
GLASS			GLASS					
TYPE	MATERIAL	TYPE	TYPE	HARDWARE	REFERENCED GENERAL NOTES			
/A	METAL	1	N/A	3				
/A	METAL	1	N/A	3				
/A	METAL	1	N/A	3				
/A	METAL	1	N/A	3				
/A	METAL	1	N/A	10				
/A	METAL	1	N/A	3				
/A	METAL	1	N/A	3				

	HARDWARE SET #10						
OPENIN	IG DESCRIPTION: (4'-0" x 7'-0" x 1-3/4")	DOOR NO. 101, 200, & 203					
3 EA.	HINGE	ECBB1100 4-1/2" x 4-1/2" NRP	US26D				
1 EA.	LOCKSET (STOREROOM)	W581BD D	US26D				
1 EA.	CONSTRUCTION CORE	80-035	GRN				
1 EA.	BEST PERMANENT CORE BY OTHERS						
1 EA.	PROTECTION PLATE	194S 10x34	US32D				
1 EA.	DRIP CAP	810S x 40	MIL				
1 EA.	THRESHOLD	412S 36	MIL				
1 EA.	DOOR SWEEP	754S N 36	CLR				
1 SET	WEATHERSTRIPPING	891S V 1x36", 2x84"	MIL				

HARDWARE SET #3

ECBB1100 4-1/2" x 4-1/2" US26D

368M-W3 / 368W-W3

30S 4x16 US32D

33G 4x16 US32D

236W US32D

80-035 GRN

307D GRAY

412S 36 MIL

754S N 36 CLR

W581BD D US26D

190S 10x34 US32D

SC81 RW/PA

891S V 1x36", 2x84" MIL

OPENING DESCRIPTION: (3'-0" x 7'-0" x 1-3/4")

1 EA. BEST PERMANENT CORE BY OTHERS

3 EA. HINGE

1 EA. PUSH PLATE

1 EA. PROTECTION PLATE

1 EA. SIGN (ADA MEN/WOMEN)

1 EA. CONSTRUCTION CORE

1 EA. WEATHERSTRIPPING

1 EA. DOOR PULL

1 EA. CLOSER

1 EA. LOCKSET

1 EA. WALL STOP

3 EA. SILENCERS

1 EA. THRESHOLD

1 EA. DOOR SWEEP

	10"		8"		8"		8"	
8	11	6" MIN. PICTOGRAM FIELD 3/4"	1 4	6" MIN. PICTOGRAM FIELD -3/4" 8"	İ	6" MIN. PICTOGRAM FIELD -3/4" 8"		6" MIN. PICTOGRAM FIELD -3/4"
	RESTROOM	3/8"	WOMEN	3/8"	MEN	3/8"	WOMEN	3/8"
	(doi pos	ts only for ition of Braille)	(do: pos	ts only for ition of Braille)	(do pos	ots only for sition of Braille)	(dc pos	ts only for sition of Braille)
	SIGN TYPE 1		SIGN TYPE 2		SIGN TYPE 3		SIGN TYPE 4	

N/A

1	Scale	SIGNAGE GRAPHICS
	3" = 1'-0"	

**DOOR** 

HEIGHT

7' - 0"

7' - 0"

WIDTH

3' - 0"

3' - 0"

1/4" = 1'-0"

NUMBER TYPE MATERIAL

A H.M.

5-1A

5-1B

		WORKSHEET - I	ROOM OCCUPANCY			
				Occupant	(Round Up to whole # for Calculated Load. Addt'l Occupants may be added per Building Official's Approval)	
Number	Name	Function of Space	Area	Load Factor	Occupant Load - Calculated	Occupants
1-1	TEAM STORE	Business Areas	149 SF	100 SF	2	
2-1	WOMEN'S ADA	N/A	129 SF	0 SF		
2-2	MEN'S ADA	N/A	129 SF	0 SF		
3-1	WOMEN'S RR 1	N/A	127 SF	0 SF		
3-2	WOMEN'S RR 2	N/A	127 SF	0 SF		
4-1	CONTAINER 2 CONCESSION	Kitchens, Commercial	111 SF	200 SF	1	
4-2	FAMILY RR 1	N/A	49 SF	0 SF		
4-3	FAMILY RR 2	N/A	49 SF	0 SF		
4-4	FAMILY RR 3	N/A	49 SF	0 SF		
5-1	KITCHEN	Kitchens, Commercial	267 SF	200 SF	2	

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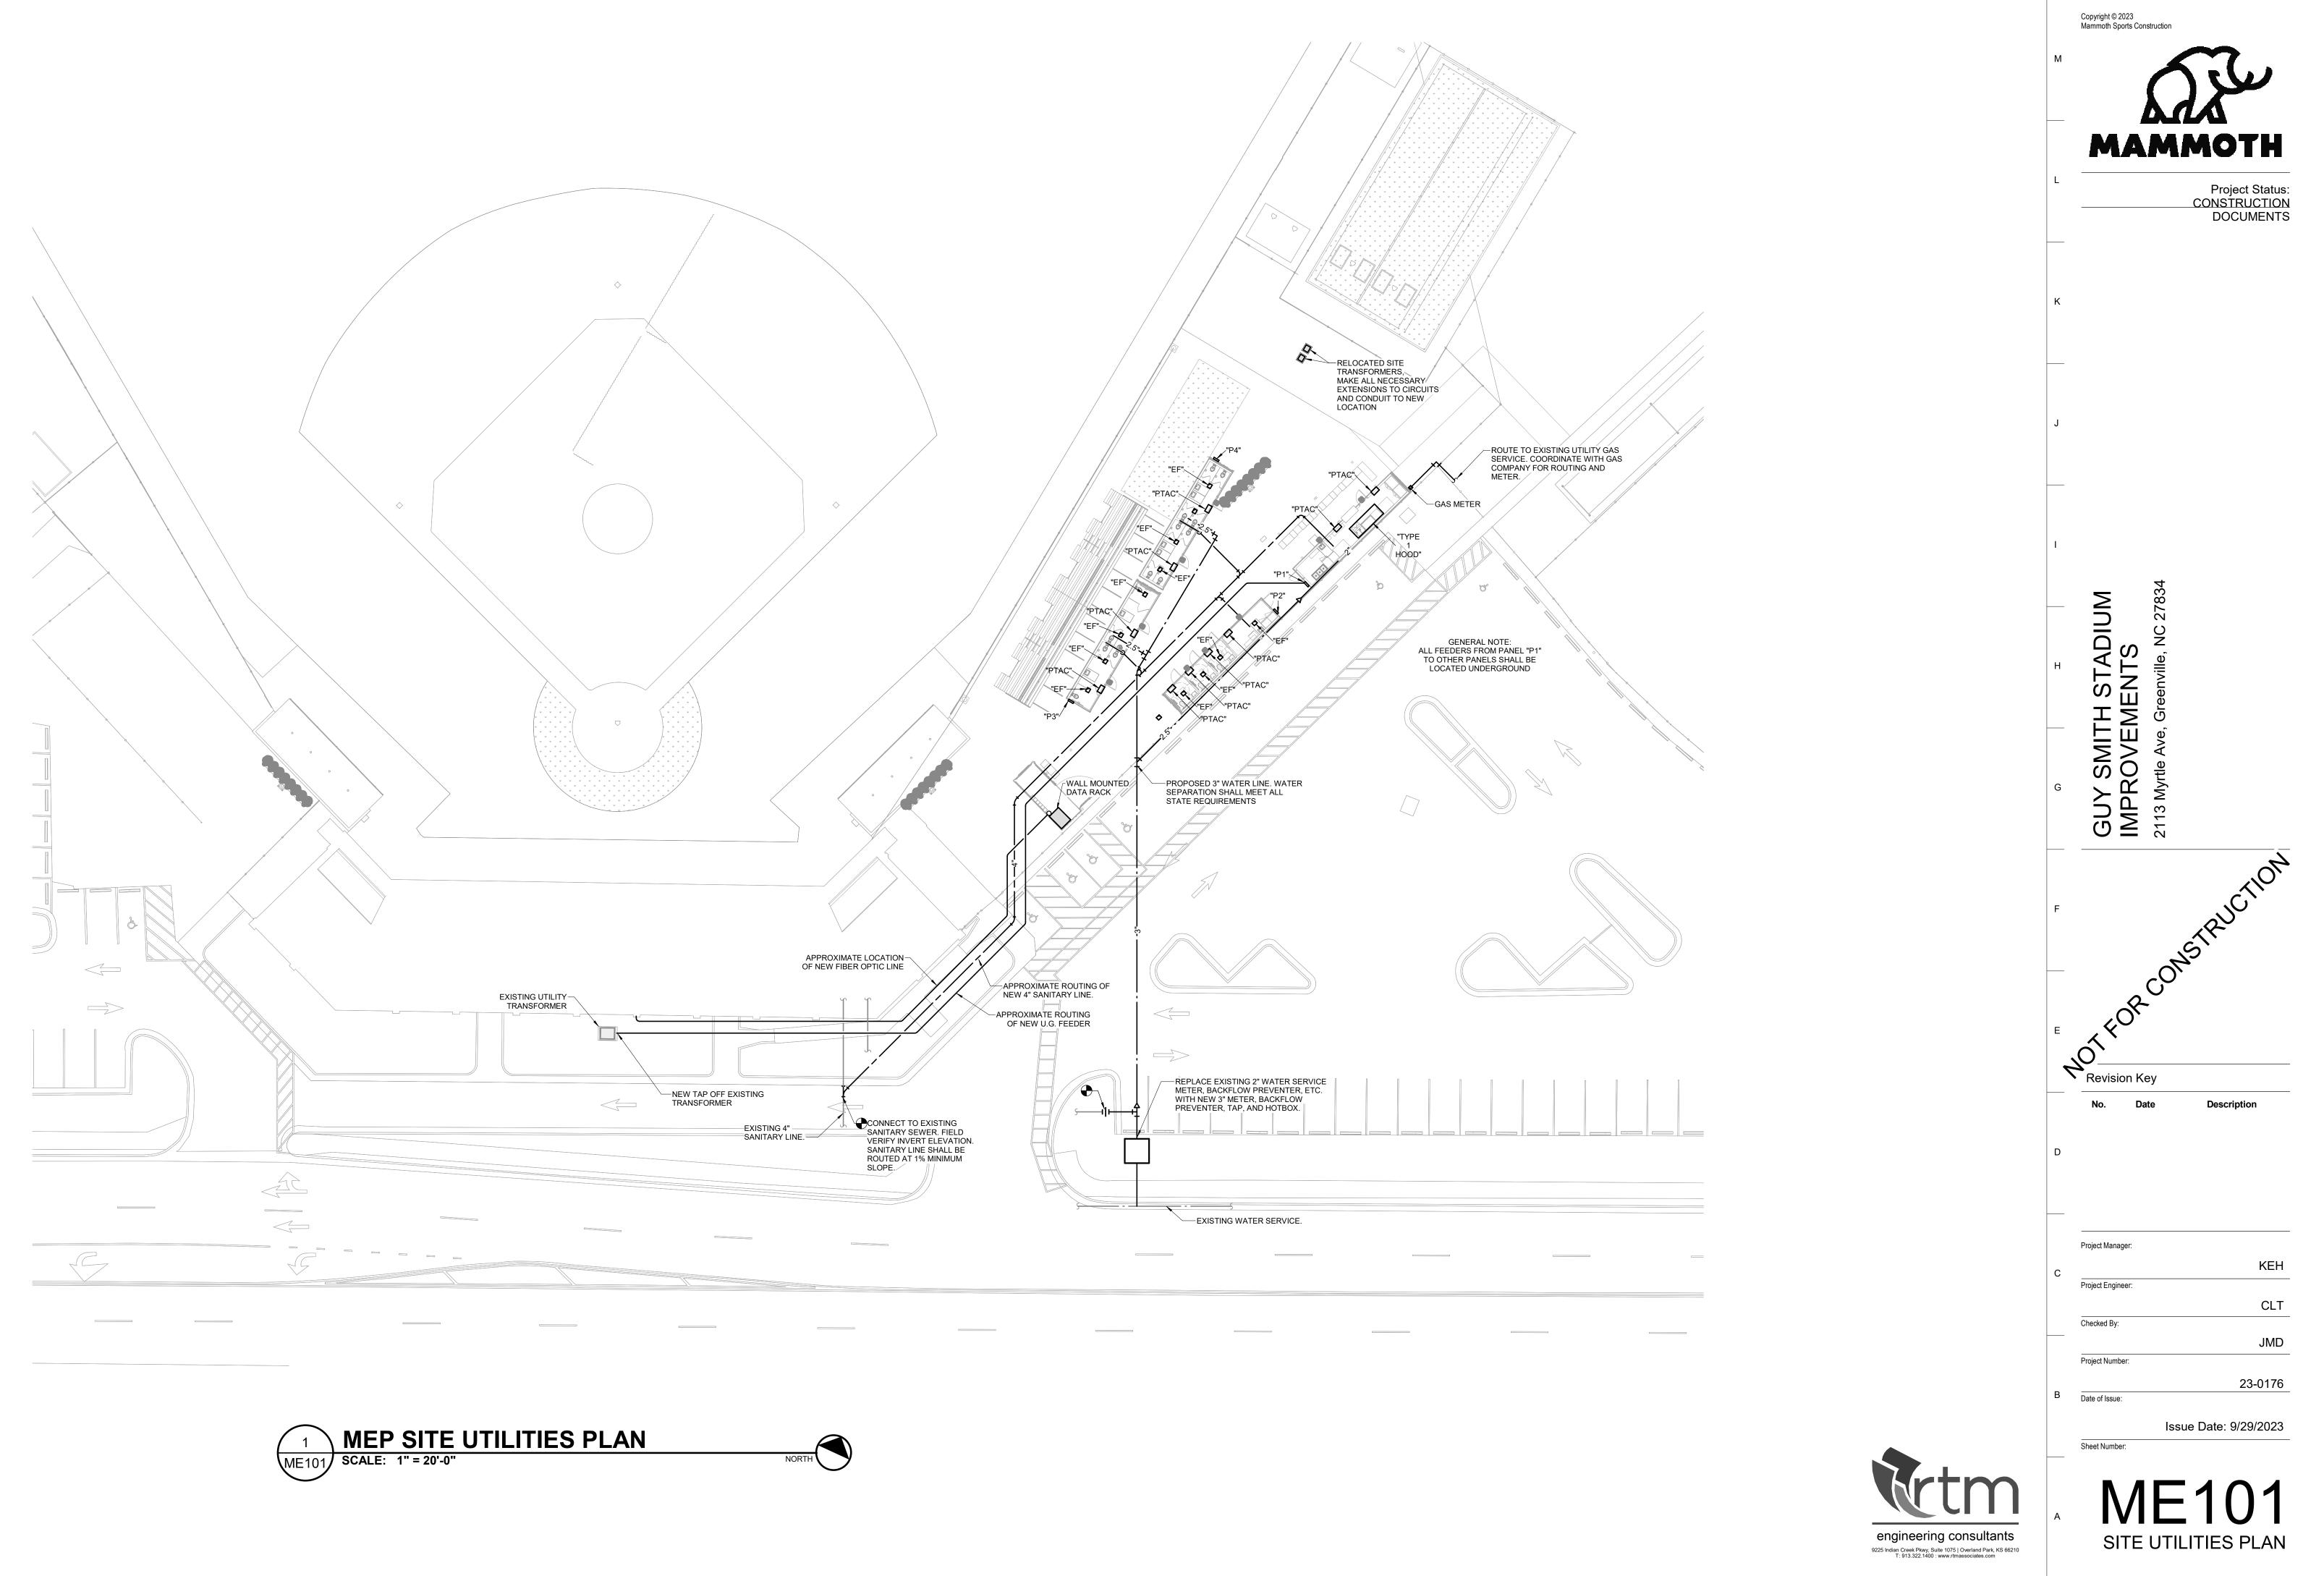
Project Status: CONSTRUCTION

DOCUMENTS

Revision Key 1 9/29/23 REV #1

Project Manager: Project Architect Checked By: Checker Project Number: 23-0176 Date of Issue: Issue Date: 9/22/2023

SCHEDULES, SIGNAGE, **NETTING DETAILS** 



KEH CLT

JMD

SITE UTILITIES PLAN