GUY SMITH STADIUM IMPROVEMENTS

2113 Myrtle Ave, Greenville, NC 27834

Issue Date: 9/22/2023

Project Type: Stadium Improvements

Project No. 23-0176

Project Status: CONSTRUCTION DOCUMENTS

PROJECT DIRECTORY

OWNER

City of Greenville, NC 200 West Fifth St. Greenville, NC 27858 Mark Nottingham Mnottingham@greenvillenc.gov

ARCHITECTURE

Mammoth Sports Construction 601 E Wyandotte St. Meriden, KS 66512

David Devore, Head of Design and Architecture

David@mammothbuilt.com

<u>CIVIL</u>

Mammoth Sports Construction

601 E Wyandotte St. Meriden, KS 66512 Dylan Medlock, Director of Engineering Dmedlock@mammothbuilt.com

<u>MEP</u>

RTM Engineering Consultants
9225 Indian Creek Pkwy. Suite 1075
Overland Park, KS 66210
Keith Hammerschmidt
Keith.Hammerschmidt@rtmec.com

SCOPE OF WORK

Phase 1 - Relocate foul line field fences, warning track, and bullpens. Remove and build new batting cages and hitting net system. Phase 2 - Build new bleachers, restrooms, concessions, and merchandise structures.

SHEET INDEX

G003 CODE SUMMARY
G004 CODE AND PARKING SITE PLAN
C101B PH2 SITE PLAN
C201 PH.2 GRADE PLAN

G001 GENERAL NOTES

G002 SURVEY CONTROL

C201 PH.2 GRADE PLAN
C501 STANDARD DETAILS
C502 STANDARD DETAILS

ASD102 DEMO. SITE PLAN - PHASE 2 AS102 ARCH. SITE PLAN - PHASE 2

- A111 ENLARGED SITE PLAN PHASE 2
 A112 CONTAINER 1 PLANS/ELEVATIONS
 A113 CONTAINER 2 PLANS/ELEVATIONS
 A114 CONTAINER 3 PLANS/ELEVATIONS
 A115 CONTAINER 4 PLANS/ELEVATIONS
- A115 CONTAINER 4 PLANS/ELEVATIONS
 A116 ADD ALT CONTAINER 5 PLANS/ELEVATIONS
 A117 ADD ALT PERGOLA PLANS
- A118 CONTAINER DETAILS
 A119 BLEACHER PLAN AND SECTION
 A120 SCHEDULES, SIGNAGE, NETTING DETAILS

 ME101 SITE UTILITIES PLAN


my y my

SITE MAP

LOCATION MAP



Copyright © 2023

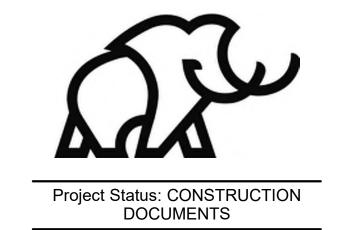

SMITH STADIUM IMPROVEMENTS



Revision Key

Date Revision

Project Manager:

BH

Project Architect:

DF

Checked By:

DD

Project Number:

23-0176

Date of Issue:

Issue Date: 9/22/2023

G000 COVER SHEET

1.0 GENERAL CIVIL CONSTRUCTION NOTES:

1.1 SCOPE OF THE WORK

A. SITE WORK, INCLUDING FINE GRADING, CHAINLINK FENCE INSTALLATION, AND ATHLETIC FIELD APPURTENANCES.

1.2 SPECIFICATIONS WHICH APPLY:

A. CONTRACTOR SHALL FOLLOW THE PROJECT MANUAL FOR GUY SMITH STADIUM DOCUMENTS INCLUDED AS PART OF THIS PROJECT.

1.3 OVERALL PROJECT GENERAL NOTES

- A. ALL WORK SHALL CONFORM TO THE CONTRACT DOCUMENTS, WHICH INCLUDE, BUT ARE NOT LIMITED TO, THE OWNER CONTRACTOR AGREEMENT, DRAWINGS OF ALL DISCIPLINES AND ALL ADDENDA, MODIFICATIONS AND CLARIFICATIONS ISSUED BY THE ENGINEER ALL WORK PRESENTED SHALL CONFORM TO ANY CONTRACT DOCUMENTS, INCLUDING THE PROJECT MANUAL FOR GUY SMITH STADIUM.
- B. WRITTEN DIMENSIONS TAKE PRECEDENCE OVER SCALED DIMENSIONS. NOTIFY ENGINEER OF ANY DISCREPANCIES OR CONDITIONS REQUIRING INFORMATION OR CLARIFICATION BEFORE PROCEEDING WITH THE WORK.
- C. FIELD VERIFY ALL EXISTING CONDITIONS AND DIMENSIONS. NOTIFY ENGINEER OF ANY DISCREPANCIES OR CONDITIONS REQUIRING INFORMATION OR CLARIFICATION BEFORE PROCEEDING WITH THE WORK.
- D. RESTORE ALL EXISTING AREAS AFFECTED BY DEMOLITION AND RELATED NEW CONSTRUCTION TO THEIR ORIGINAL CONDITION.

2.0 SITE WORK

2.1 GENERAL

A. THE SCOPE OF THE WORK WILL INCLUDE FINE GRADING, CONCRETE WORK, INSTALLATION OF ATHLETIC RELATED FURNISHINGS, AND GENERAL SITE RESTORATION UPON COMPLETION.

2.2 CLEARING AND GRUBBING

A. ALL CLEARING AND GRUBBING SHALL BE CONSIDERED INCIDENTAL.

2.3 GRADING:

- A. WORK SHALL INCLUDE STRIPPING AND REMOVAL OF TOPSOIL AND UNSUITABLE SOILS AND REGRADING OF SITE TO INDICATED GRADES. TOPSOIL REMOVAL AND SUBGRADE PREPARATION FOR LIGHTLY LOADED PAVEMENT; BATTING CAGE OR SIMILAR INSTALLATION.
- B. THE CONTRACTOR SHALL MAINTAIN DRAINAGE THROUGH THE PROJECT AREA AT ALL TIMES. ALL MATERIALS AND LABOR NECESSARY TO MAINTAIN DRAINAGE (DEWATERING) SHALL BE CONSIDERED INCIDENTAL TO THE PROJECT, UNLESS OTHERWISE SPECIFIED.
- C. TOPSOIL AND UNSUITABLE SOILS SHALL BE EXCAVATED AS NEEDED. THE SUBGRADE SHALL BE APPROVED BY THE CIVIL ENGINEER OF RECORD OR A GEOTECHNICAL ENGINEER PRIOR TO PLACEMENT OF FILL / AGGREGATE. THE EXCAVATION SHALL ALWAYS BE MAINTAINED FREE OF WATER.
- D. SALVAGED MATERIAL SHALL BE USED TO FILL GRASSED AREAS THAT WERE DISTURBED, AS REQUIRED, LEAVING ROOM FOR 6" MINIMUM OF TOPSOIL IN THE LANDSCAPED AREAS. UNSUITABLE MATERIALS SUCH AS ROCKS, BOULDERS, TREE ROOTS, ETC. SHALL BE REMOVED FROM THE BACKFILL MATERIAL AND DISPOSED OF OFF-SITE. EXCESS EXCAVATED MATERIAL SHALL BE HAULED FROM THE SITE OR TO A SUITABLE PLACE ON SITE DESIGNATED BY OWNER.

2.5 SUBGRADE:

- A. EXECUTION:
- 1. SUBGRADE SHALL BE PREPARED IN ACCORDANCE WITH NCDOT SPECIFICATIONS.

B. FINAL RESULT

1. LOW SPOTS OR POCKETS FROM WHICH WATER WILL NOT DRAIN ARE NOT ACCEPTABLE.

2.6 SITE SOILS:

A. AS PER THE USDA WEB SOIL SURVEY TOOL, THE SITE CONSISTS OF EXUM FINE SANDY LOAM (0-1%) AND GOLDSBORO SANDY LOAM (0-1%).

2.7 AGGREGATES AND STRUCTURAL FILL:

- A. GRANULAR STRUCTURAL FILL: THE GRANULAR STRUCTURAL FILL SHOULD CONSIST OF A PIT-RUN OR PROCESSED SAND OR GRAVEL HAVING A MAXIMUM PARTICLE SIZE OF 3 INCHES WITH LESS THAN 15 PERCENT BY WEIGHT PASSING THE #200 SIEVE. THE GRANULAR STRUCTURAL FILL SHOULD BE PLACED IN LIFTS OF UP TO 1 FOOT IN
- B. <u>SELECT GRANULAR FILL</u>: THE SELECT GRANULAR FILL SHOULD CONSIST OF A MEDIUM TO COARSE GRAINED, FREE-DRAINING SAND OR ROCK HAVING A MAXIMUM PARTICLE SIZE OF 1 INCH WITH LESS THAN 5 PERCENT BY WEIGHT PASSING THE #200 SIEVE. THE SELECT GRANULAR FILL SHOULD BE PLACED IN LIFTS OF UP TO 1 FOOT IN

2.8 SITE RESTORATION:

A. ALL SITE WORK THAT IS NOT ATHLETIC FIELD RELATED TO BE SEEDED AS SHOWN ON THE SITE RESTORATION PLAN. ALL SEEDING OPERATIONS TO FOLLOW NCDOT SPECIFICATIONS.

Copyright © 2023

Mammoth Sports Construction



ISSUED FOR BID



JY SMITH STADI PROVEMENTS

FORBIDON

Revision Key

No. Date Revision

Project Manager:

Project Engineer:

DM

Checked By:

DR

Project Number:

23-0176

Date of Issue:

09-20-2023

G - 001

Sheet Number:

GENERAL NOTES

SURVEY CONTROL MAP



ISSUED FOR CONSTRUCTION



Revision Key

Project Manager: Project Engineer:

23-0176

Date of Issue: 08-14-2023

Sheet Number:

G - 002

SURVEY CONTROL AND INFORMATION

DESCRIPTION: ATHLETIC FACILITY IMPROVEMENTS IN GREENVILLE, NC GREENVILLE, PITT COUNTY, NORTH CAROLINA

LAT: 35.602525° N

LONG: 77.395133° W

BASED ON NAD83, STATE PLANE NORTH CAROLINA (3200) AND NAVD88. NO BENCHMARK FOUND - ASSUMED VERTICAL W/ AUTONOMOUS GPS SHOT. ALL PLAN ELEVATIONS ARE RELATIVE TO THE CONTROL.

CP #1000 N: 2477300.268 E: 678095.014

CP #1001 N: 2477172.647 E: 677944.194 ELEV: 63.172

CP #1004 N: 2477378.924 E: 678577.334 E: 678429.476 ELEV: 62.310

CP #1005 N: 2477744.654 E: 677949.053 ELEV: 61.701

ELEV: 62.432 CP #1003 N: 2476884.845

ELEV: 61.945

CP #1002

N: 2476808.883


E: 678040.352

ELEV: 63.037



Checked By: Project Number:

SURVEY CONTROL

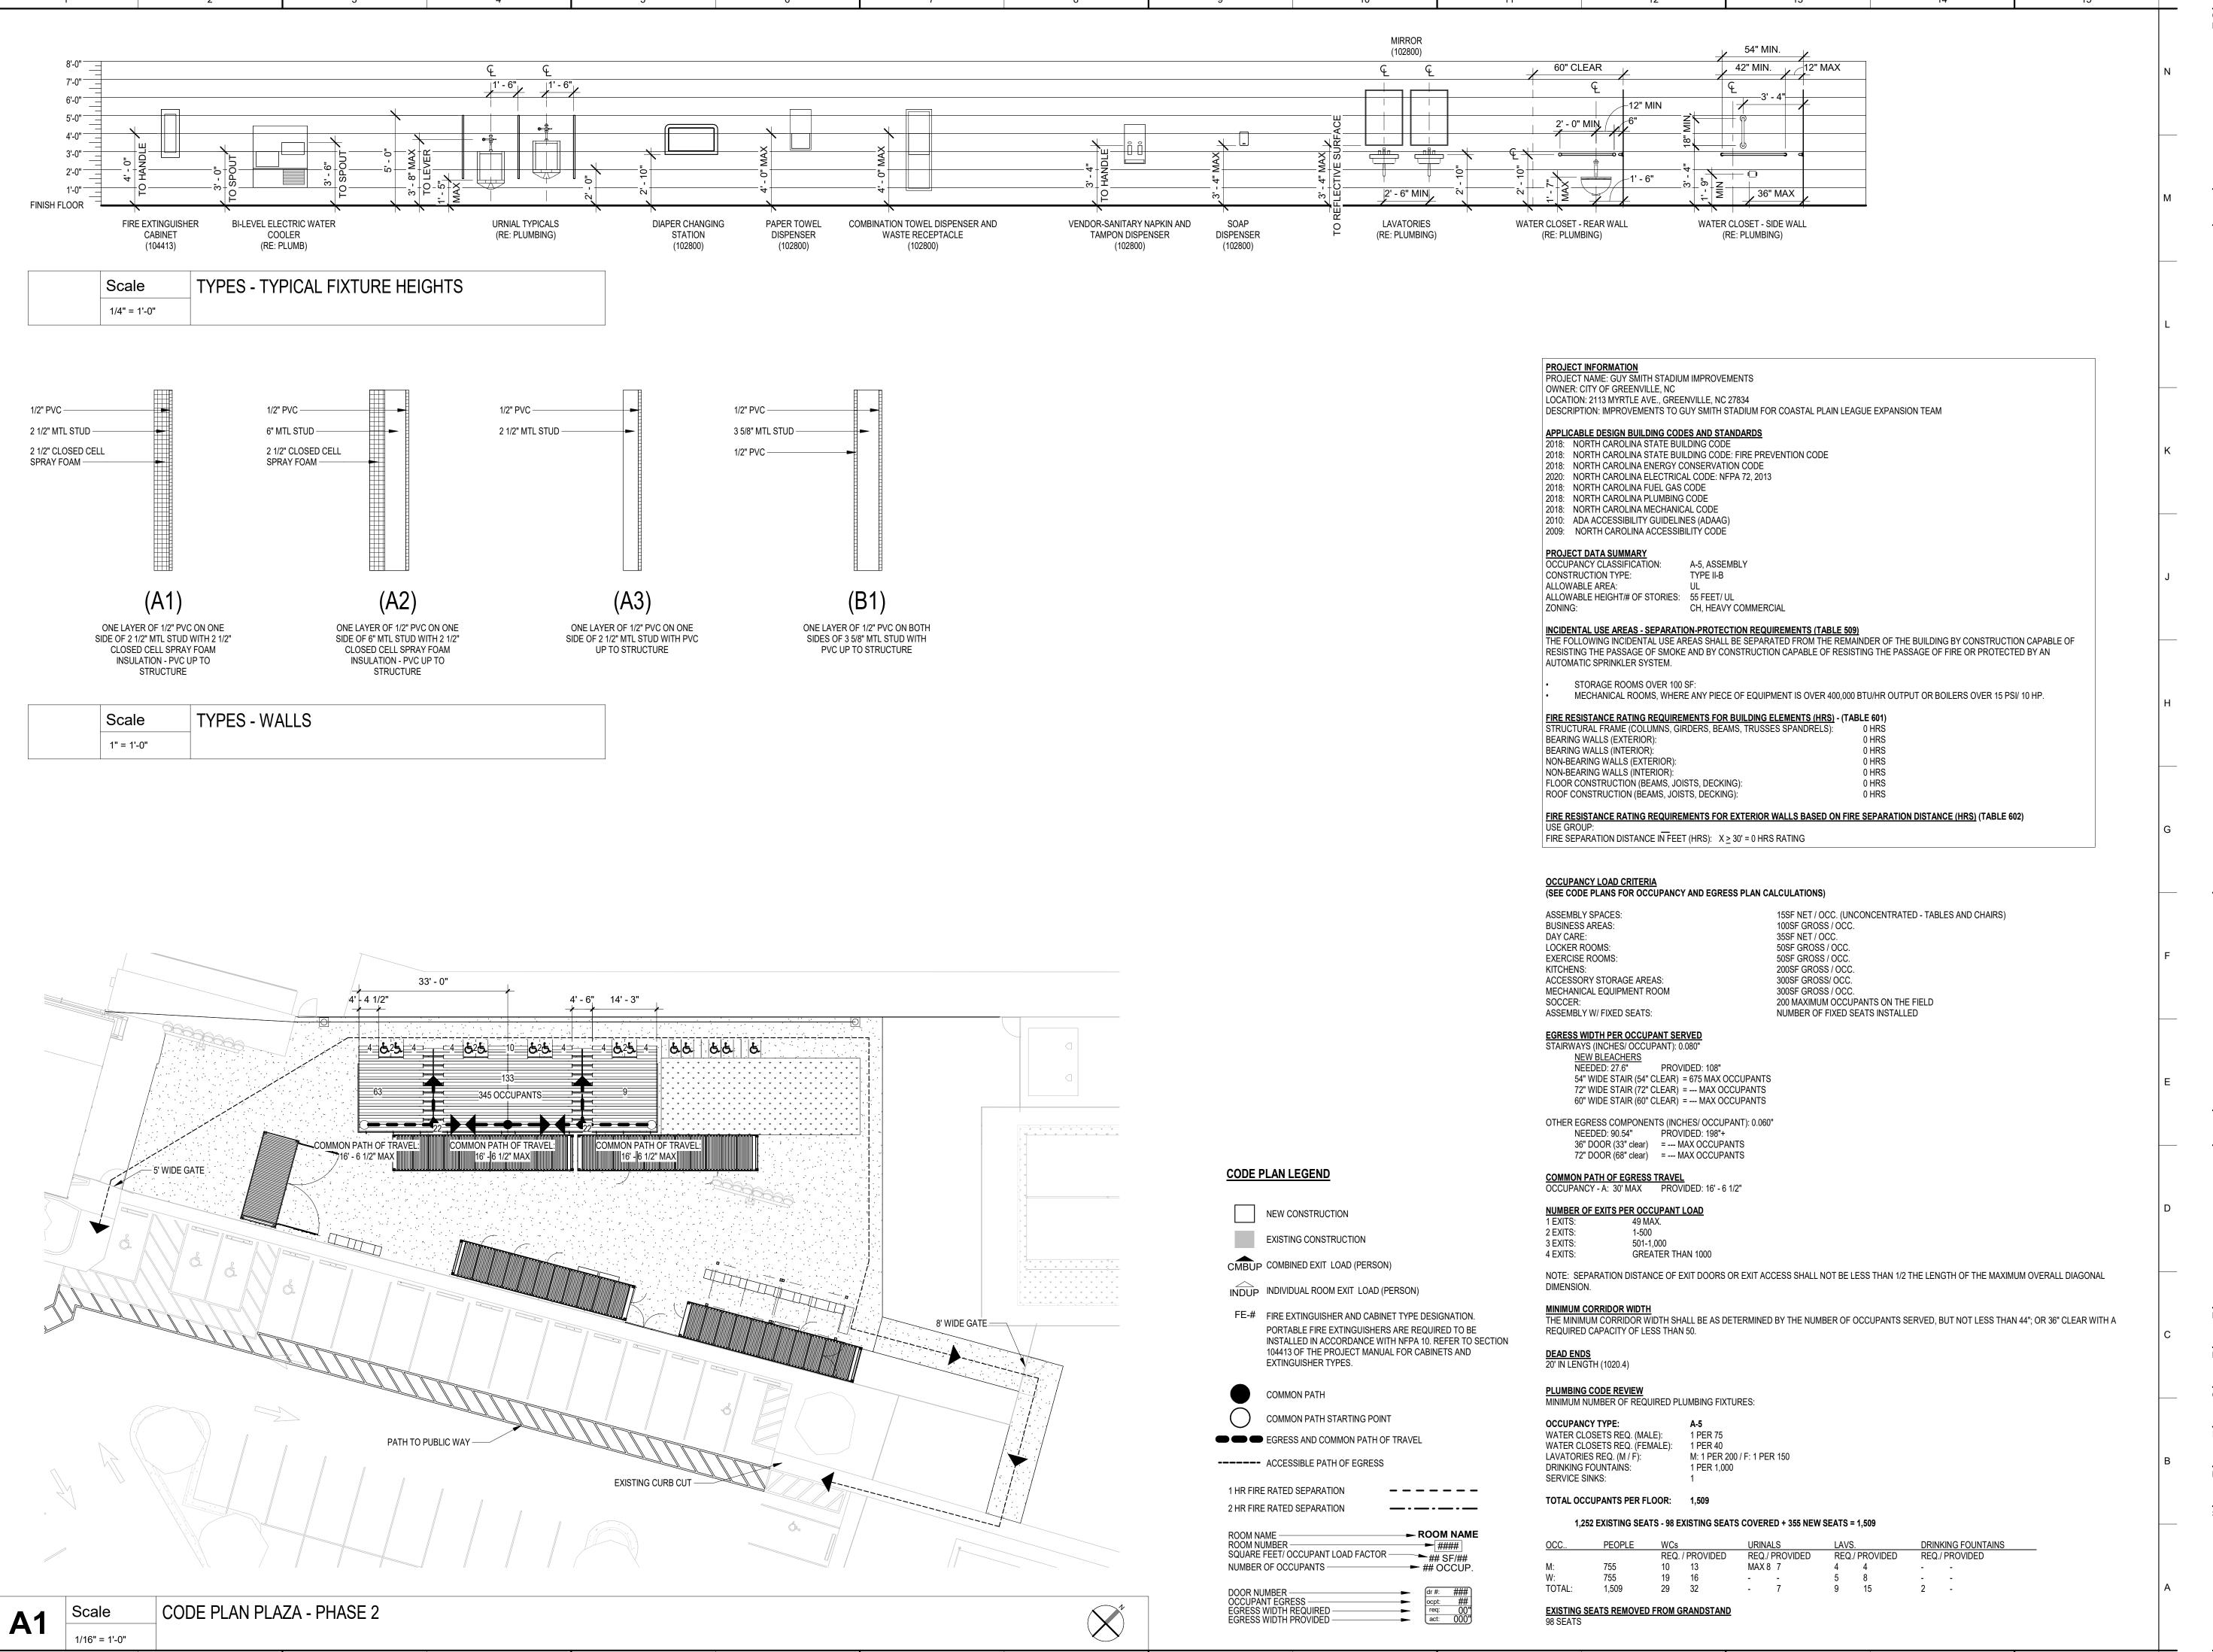



Project Status: CONSTRUCTION DOCUMENTS

'SMITH STADIUM IMPROVEMENTS

O D 7



Revision Key

No. Date Description

Project Manager:

BH

Project Architect:

DF

Checked By:

DD


Project Number:

Date of Issue:

Issue Date: 9/20/2023

Sheet Number:

CODE SUMMARY

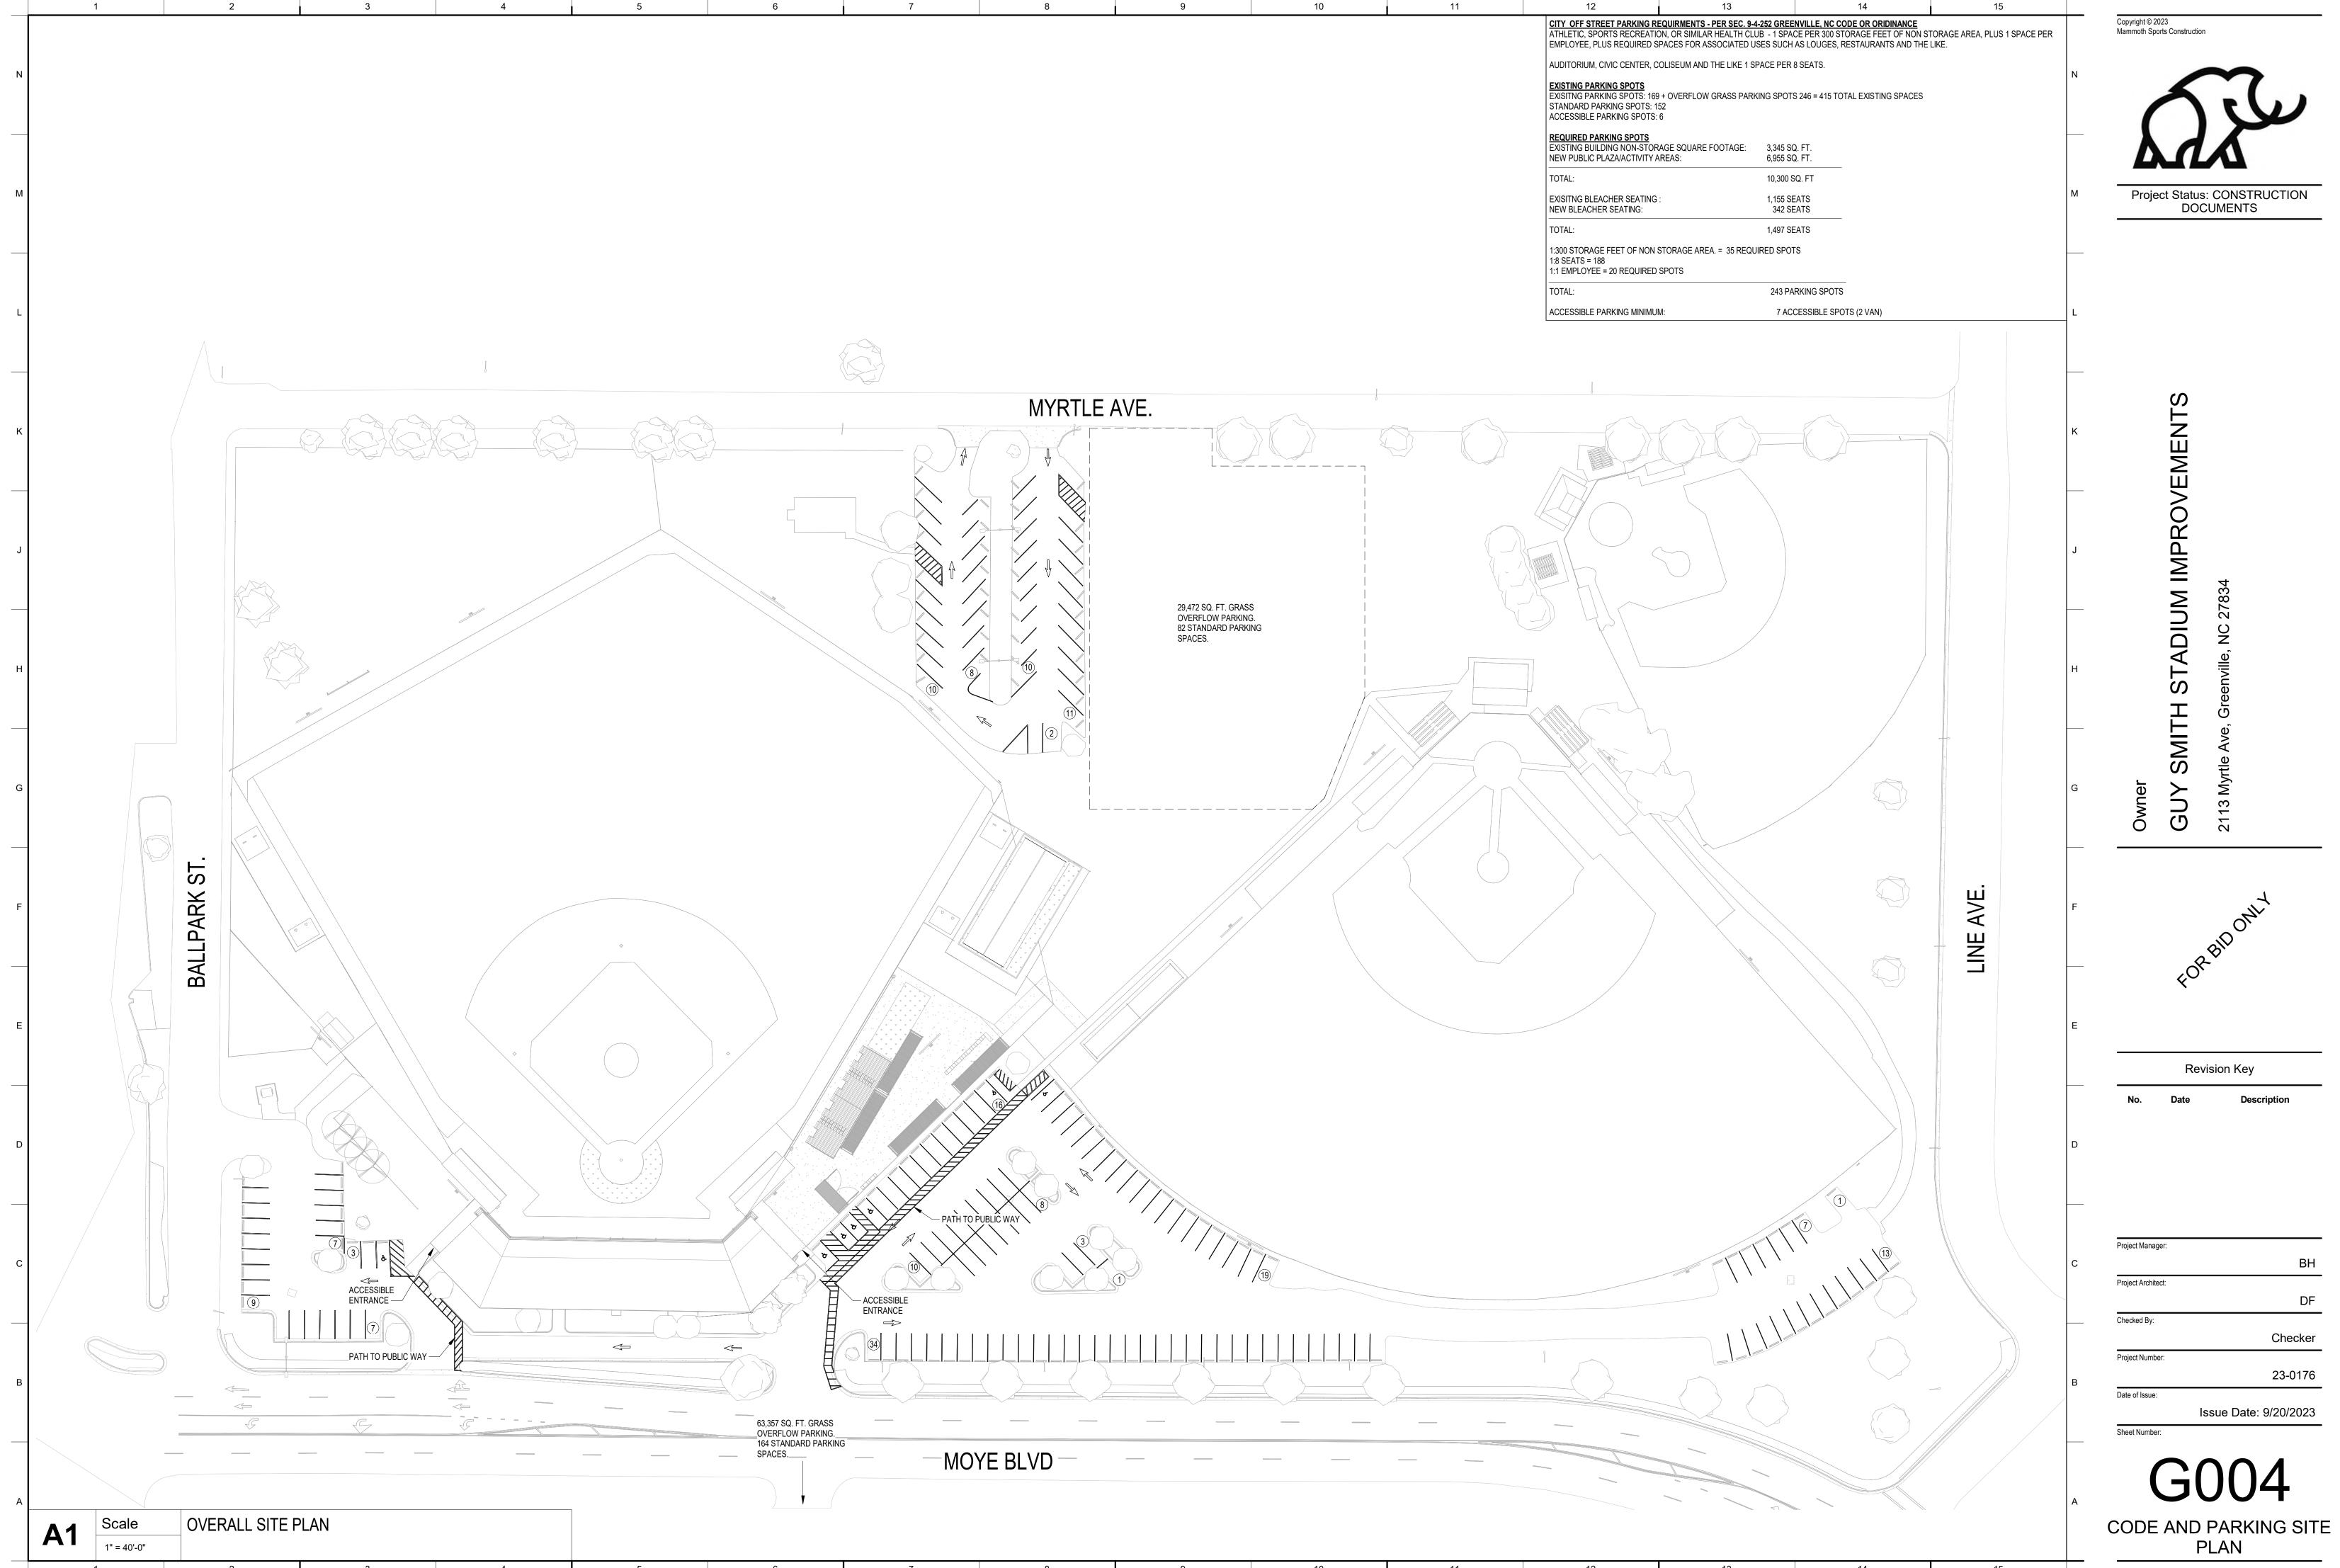

Checker 23-0176



ISSUED FOR BID



GUY SMITH STADIU MPROVEMENTS

FORBIDONIX

Revision Key

Sheet Number:

No. Date Revision

ADD.1 09-29-23 ADDITIONAL DETAIL

Project Manager:

Project Engineer:

DM

Checked By:

DR

Project Number:

23-0176

Date of Issue:

09-20-2023

C - 101

SITE PLAN (PH. 2)





ISSUED FOR BID



IUY SMITH STADIUI

FORBIDONIT

Revision Key

No. Date Revision
ADD.1 09-29-23 ADDITIONAL DETAIL

Project Manager:

Project Engineer:

DM

Checked By:

DR

Project Number:

23-0176


Date of Issue:


09-20-2023

Sheet Number:

C - 201

PH. 2 GRADE PLAN

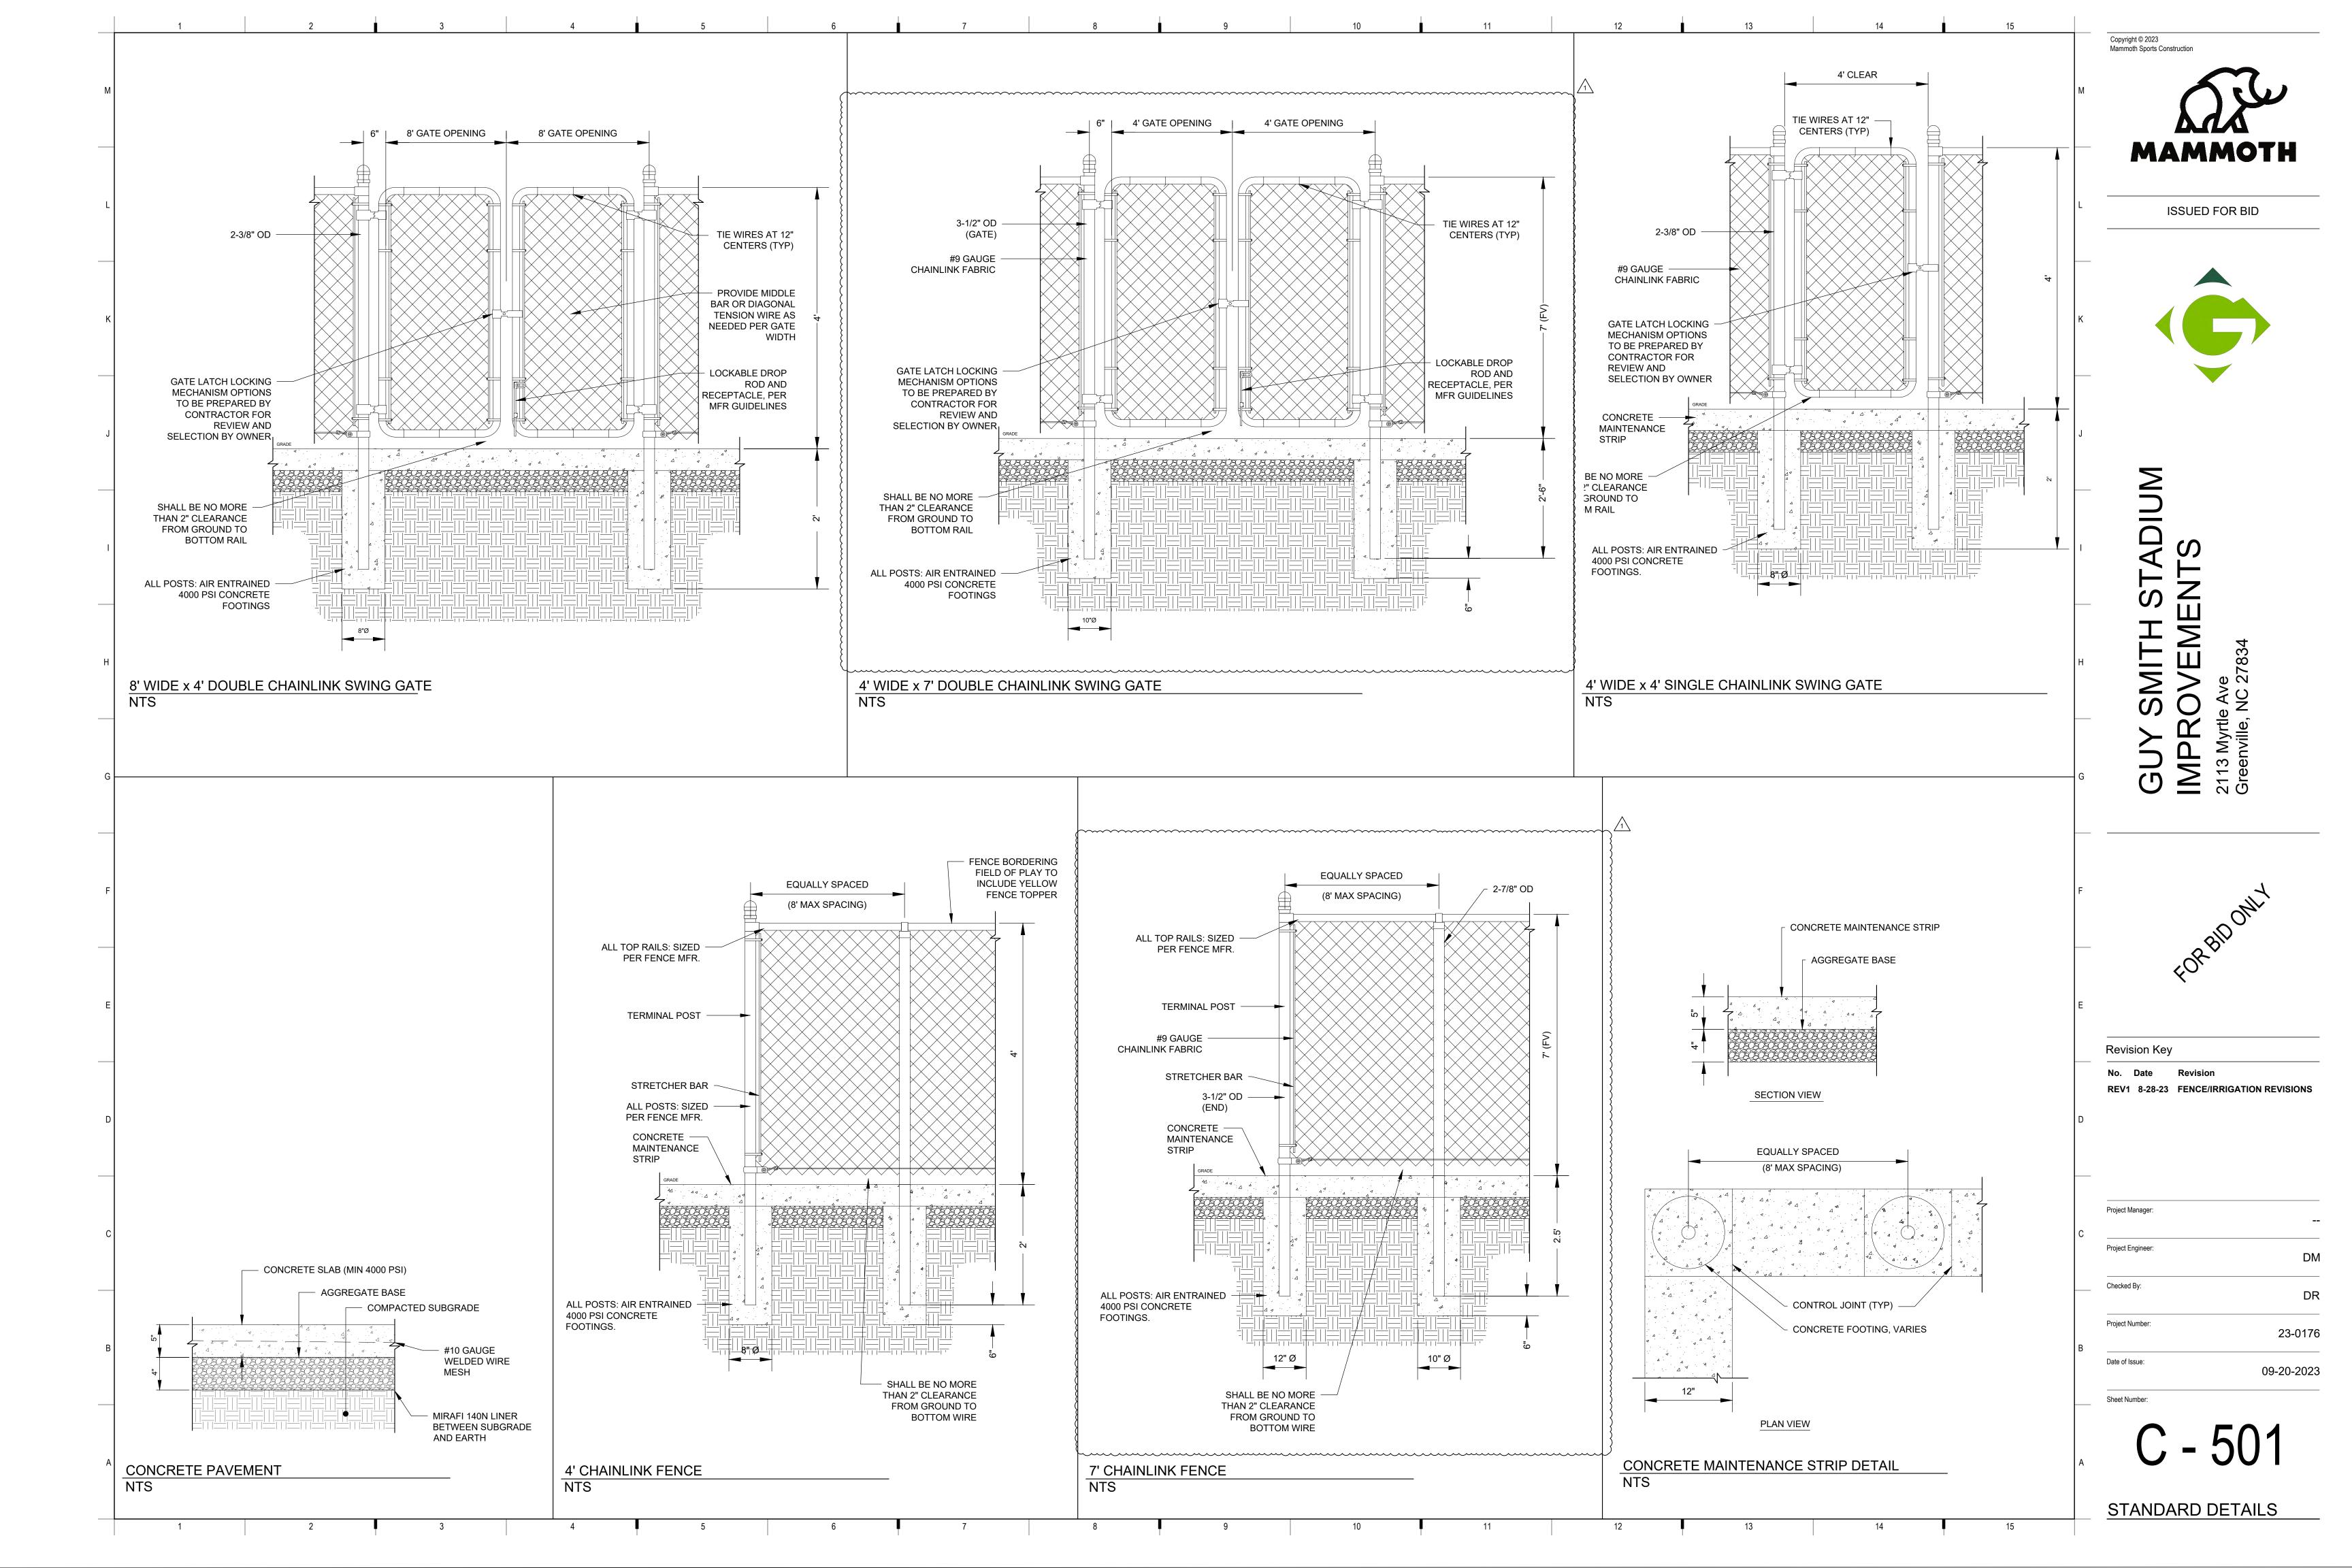

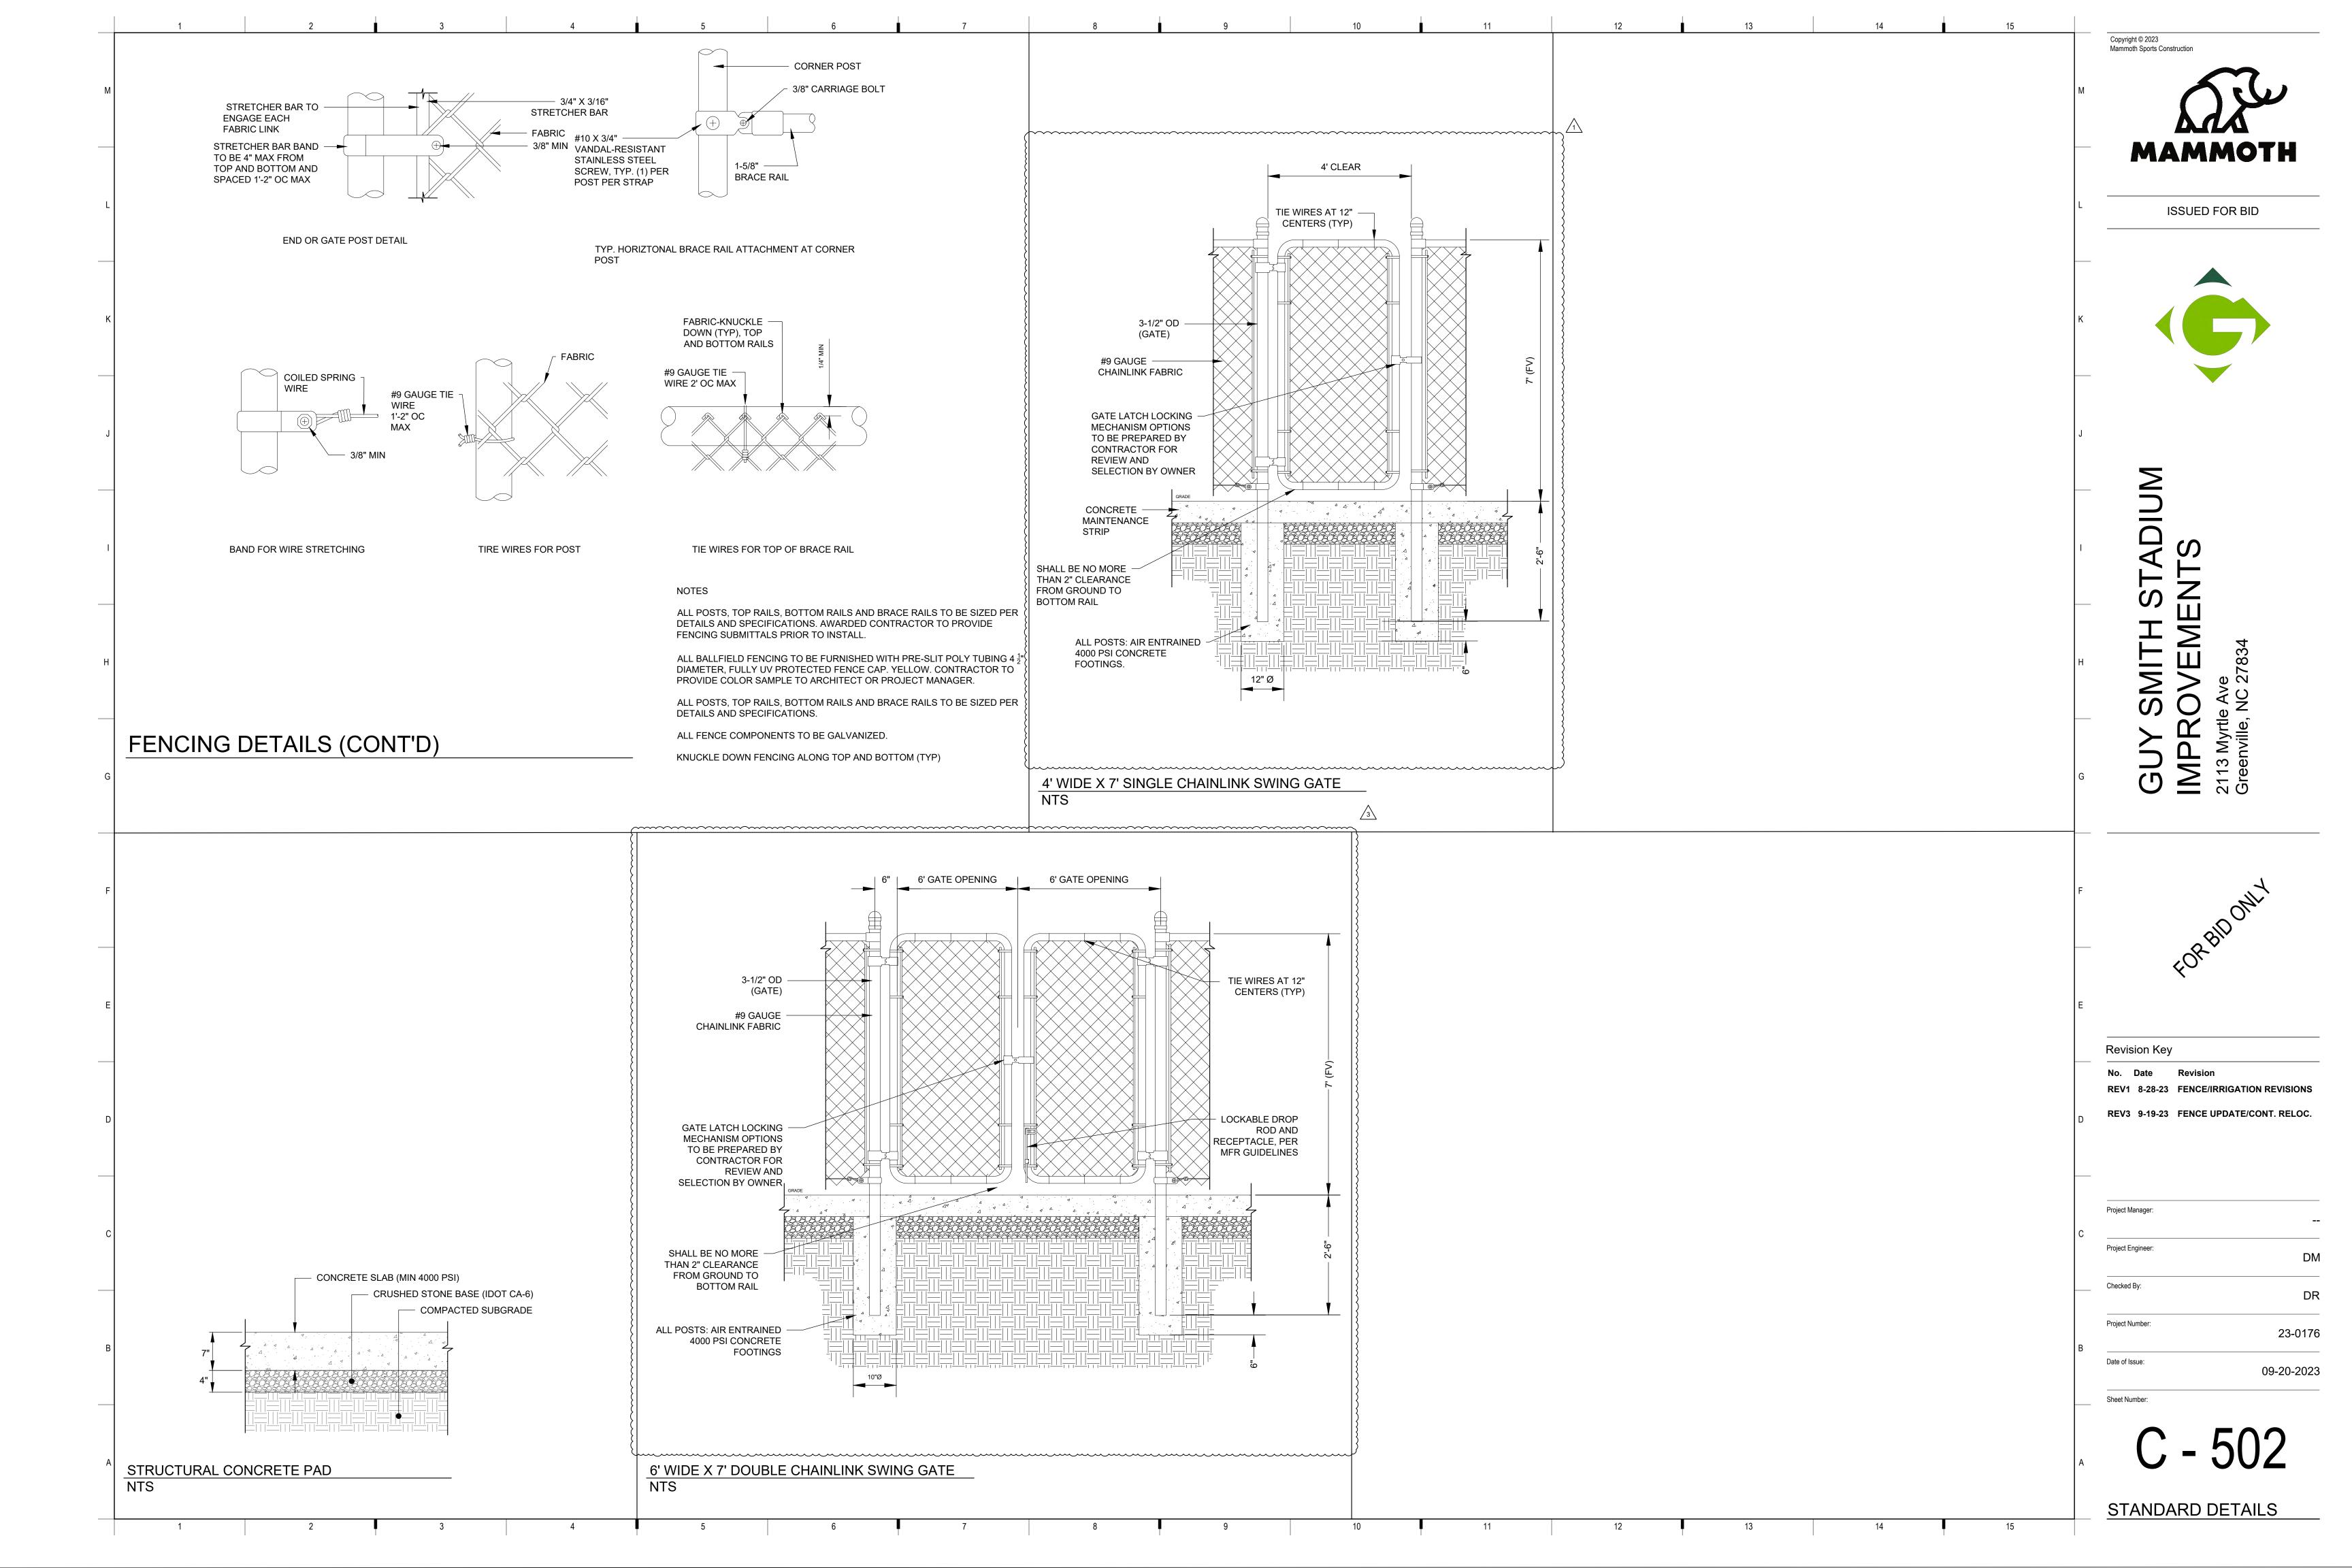



GENERAL NOTES - SITE DEMOLITION

CITY/COUNTY AGENCY.AT LOCATIONS

SITE DEMO PLAN - PHASE 2

THE CONTRACTOR, PRIOR TO ANY EXCAVATION OR NEW CONSTRUCTION, SHALL HAVE UTILITIES FIELD LOCATED BY THE APPROPRIATE UTILITY COMPANY AND/OR

THE CONTRACTOR SHALL SPOT DIG TO FIELD LOCATE EXISTING SITE UTILITIES PRIOR TO CONSTRUCTION. SERVICE LINES SHOWN IN EXISTING SURVEY WERE OBTAINED FROM RECORD DATA AND SURFACE STRUCTURES AND WERE NOT FIELD LOCATED. EXISTING UTILITIES MAY NOT BE SHOWN OR MAY BE SHOWN INCORRECTLY.

- THE SITE PLAN IS BASED ON A SURVEY OF THE SITE CONDITIONS AT THE TIME OF CONSTRUCTION AND MAY VARY FROM THE SURVEYED CONDITIONS. CONTRACTOR SHALL VERIFY EXISTING SITE CONDITIONS PRIOR TO CONSTRUCTION.
- 4. ALL MANHOLES, CATCH BASINS, UTILITY VALVES AND METER PITS SHALL BE ADJUSTED OR REBUILT TO GRADE AS REQUIRED.
- NO CHANGES TO THE APPROVED CONSTRUCTION PLANS WILL BE PERMITTED WITHOUT PRIOR WRITTEN APPROVAL OF THE ENGINEER.
- THE CONTRACTOR SHALL BE RESPONSIBLE FOR PRESERVING PROPERTY PINS AND SECTION CORNER MONUMENTS. THE CONTRACTOR WILL BE REQUIRED TO RE-ESTABLISH ANY PROPERTY PINS OR MONUMENTS WHICH ARE DAMAGED OR DESTROYED BY HIS CONSTRUCTION OPERATIONS, SUCH PINS SHALL BE RE-ESTABLISHED BY A LICENSED LAND SURVEYOR IN ACCORDANCE WITH STATE LAWS.
- 7. THE CONTRACTOR IS RESPONSIBLE FOR VERIFYING ALL QUANTITIES, DIMENSIONS, AND PLAN SCALES, AND SHALL IMMEDIATELY NOTIFY THE OWNER/ENGINEER/ARCHITECT OF ANY SUCH DISCREPANCIES. ALL QUANTITIES, DIMENSIONS, AND PLAN SCALES PROVIED ARE FOR GENERAL INFORMATION PURPOSES ONLY. THE CONTRACTOR IS RESPONSIBLE FOR DETERMINING ALL QUANTITIES NECESSARY FOR THE COMPLETION OF THE WORK AS DESCRIBED IN THE CONSTRUCTION DOCUMENTS. THE CONTRACTOR SHALL BE RESPONSIBLE TO PROVIDE THE WORK DESCRIBED IN THE CONSTRUCTION DOCUMENTS IRRESPECTIVE OF THE QUANTITIES, DIMENSIONS, AND PLAN SCALES NOTED, NOT NOTED, OR NOTED

- ALL REMOVALS SHALL BE REMOVED FROM THE SITE AND DISPOSED OF PER APPLICABLE STANDARDS UNLESS OTHERWISE NOTED.
- THE CONTRACTOR SHALL FAMILIARIZE HIMSELF WITH THE GEOTECHNICAL ENGINEERING SERVICES REPORT AND SHALL IMPLEMENT THE RECOMMENDATIONS NOTED IN THE REPORT FOR ALL SOILS AND FOUNDATION RELATED CONSTRUCTION.
- 10. THE PAVEMENT SECTIONS ARE BASED ON THE GEOTECHNICAL REPORT. THE GEOTECHNICAL REPORT RECOMMENDATIONS SHALL TAKE PRECEDENCE IN THE CASE OF ANY DISCREPANCIES. CONSEQUENTLY, THE ENGINEER WHOSE SEAL APPEARS ON THESE PLANS IS NOT RESPONSIBLE FOR THE DURABILITY OR SUITABILITY OF THE PAVEMENT SECTIONS.
- 11. CONTRACTOR SHALL TAKE APPROPRIATE MEASURES TO PROTECT ALL ADJACENT WORK NOT INDICATED TO BE DEMOLISHED PRIOR TO COMMENCEMENT OF DEMOLITION. CONTRACTOR SHALL BE RESPONSIBLE FOR DAMAGE AND REPAIR CAUSED BY CONTRACTOR'S NEGLIGENT PERFORMANCE.
- 12. REFER TO MECHANICAL, PLUMBING, AND ELECTRICAL DEMOLITION DRAWINGS FOR ASSOCIATED WORK.
- 13. CONTRACTOR SHALL PROVIDE TEMPORARY SHORING AND BRACING OF PARTIALLY DEMOLISHED CONSTRUCTION AND STRUCTURAL ELEMENTS AS REQUIRED TO MAINTAIN SAFE WORKING CONDITIONS.
- 14. CONTRACTOR TO CONFIRM WITH ARCHITECTECT SECTIONS OF FENCE TO BE DEMOLISHED PRIOR TO DEMOLITION.


LEGEND - KEYNOTES

KEY VALUE KEYNOTE TEXT

DEMOLISH SHADE STRUCTURE AND SOG D14 DEMOLISH EXISTING SIDEWALK


D17 RELOCATE TRANSFORMER AND ELECTRICAL BOX - RE: MEP DEMOLISH FENCE - AT END OF PHASE 2 CONSTRUCTION

DEMOLITION LEGEND

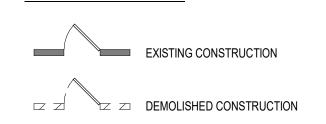

KEYNOTE IDENTIFIER

Copyright © 2023 Mammoth Sports Construction

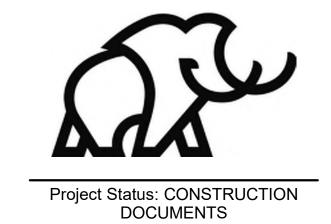


O D 7

Revision Key

Project Manager: Project Architect: Project Number: 23-0176 Date of Issue: Issue Date: 9/20/2023


DEMO. SITE PLAN -PHASE 2

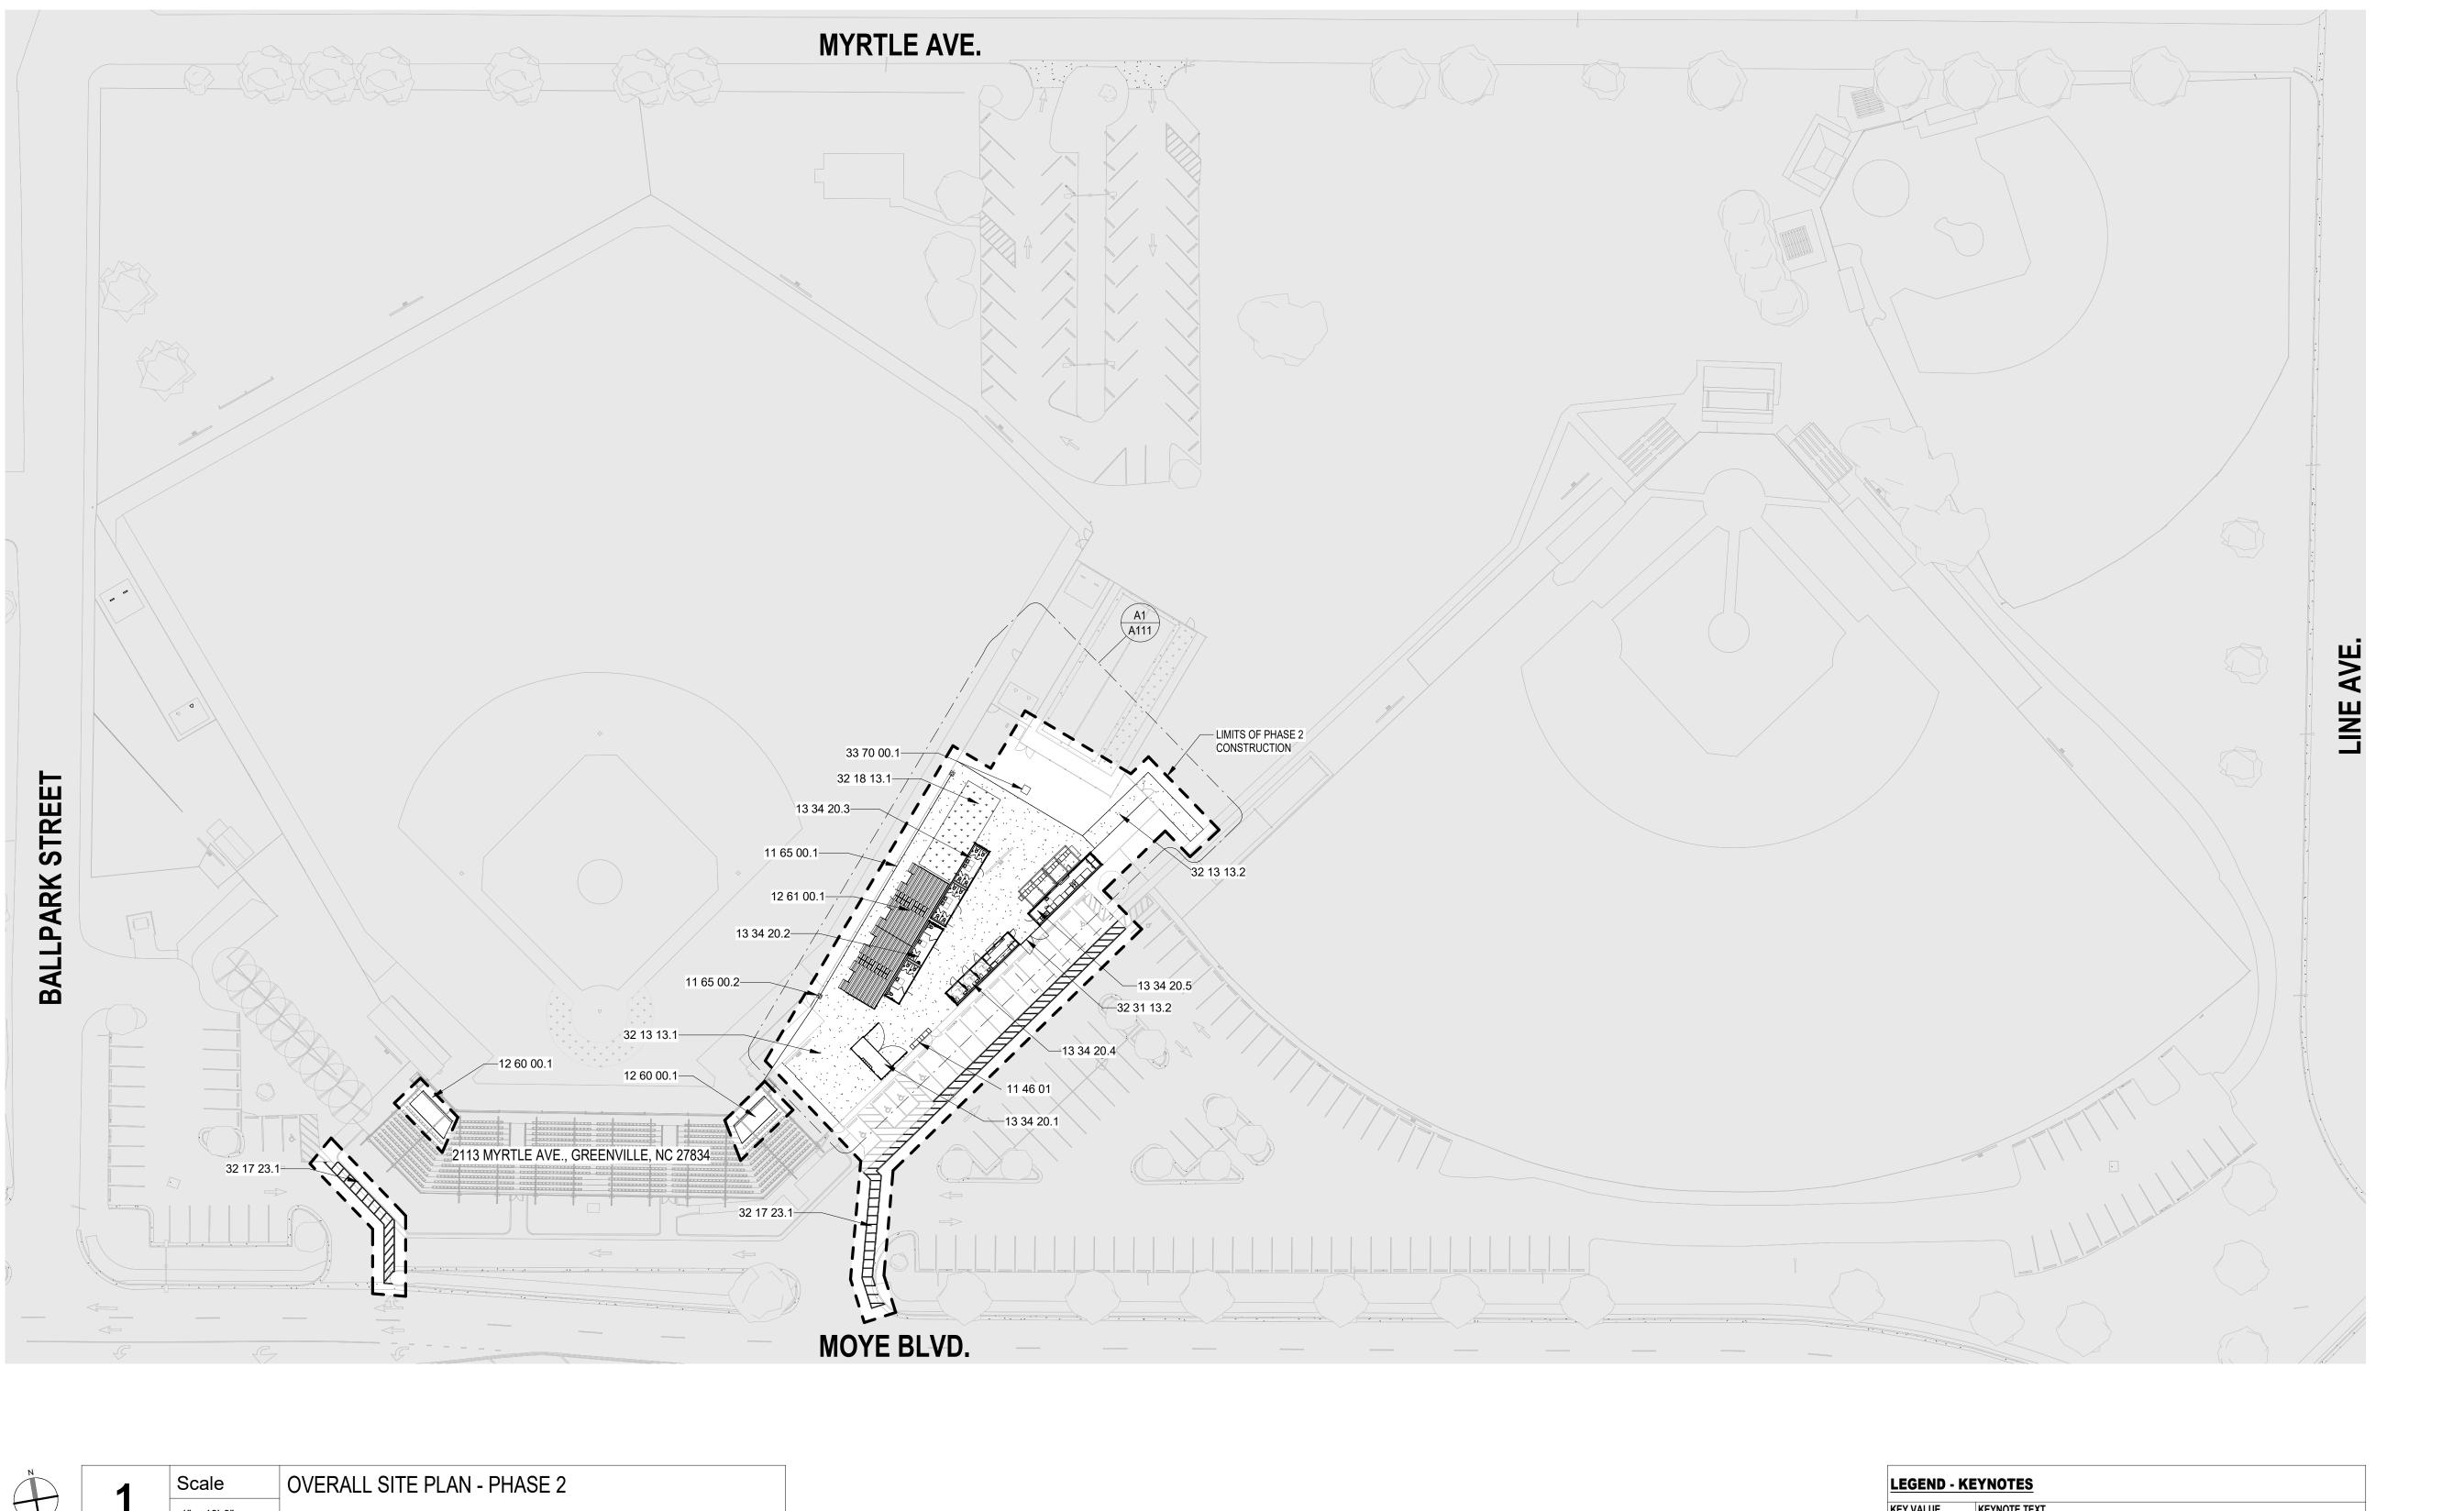

1" = 40'-0"

KEYNOTE TEXT MOBILE POS - DTG OPEN CONFIGURATION SPORTS NETTING 11 65 00.1 NETTING POLE PER MFG 11 65 00.2 SEAT COVERS - FIRST FOUR ROWS BLEACHERS PER BELSON OUTDOORS OR APPROVED ALTERNATE - MODEL:BD-1033C - NON-ELEV. 10 ROW X 33'-0" W/ WHEELCHAIR CUTOUTS ADDED CONTAINER 1 - 20' X 8' TEAM STORE CONTAINER 2 - 40' X 8' RESTROOM CONTAINER W/ 3 WOMEN'S, INCLUDING ADA TOILETS, 3 MEN'S, INCLUDING ADA, TOILETS, AND LAVATORIES CONTAINER 3 - 40' X 8' RESTROOM CONTAINER W/ 8 WOMEN'S TOILETS AND 4 CONTAINER 4 - 40' X 8' 3 FAMILY TOILETS AND CONCESSIONS W/ 2 POS CONTAINER 5 - 40' X 8' KITCHEN/PASS THROUGH RE: PHASE 2 CIVIL SITE PLAN FOR LOCATION AND SPECIFICATIONS OF SOG 32 13 13.2 RE: PHASE 2 CIVIL SITE PLAN FOR LOCATION AND SPECIFICATIONS OF NEW SIDE PATH TO PUBLIC WAY STRIPING 32 18 13.1 RE: CIVIL PHASE 2 - SYNTHETIC TURF AREA RE: CIVIL PHASE 2 - 12' FENCE GATE RE:CIVIL PHASE 2 - RELOCATE TRANSFORMER


Copyright © 2023 Mammoth Sports Construction

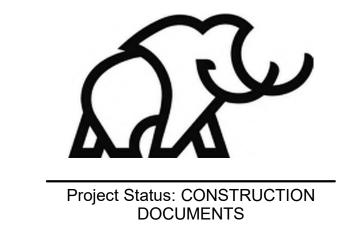


Revision Key

Project Manager: Project Architect: Checked By: Project Number: 23-0176 Date of Issue: Issue Date: 9/20/2023

ARCH. SITE PLAN - PHASE

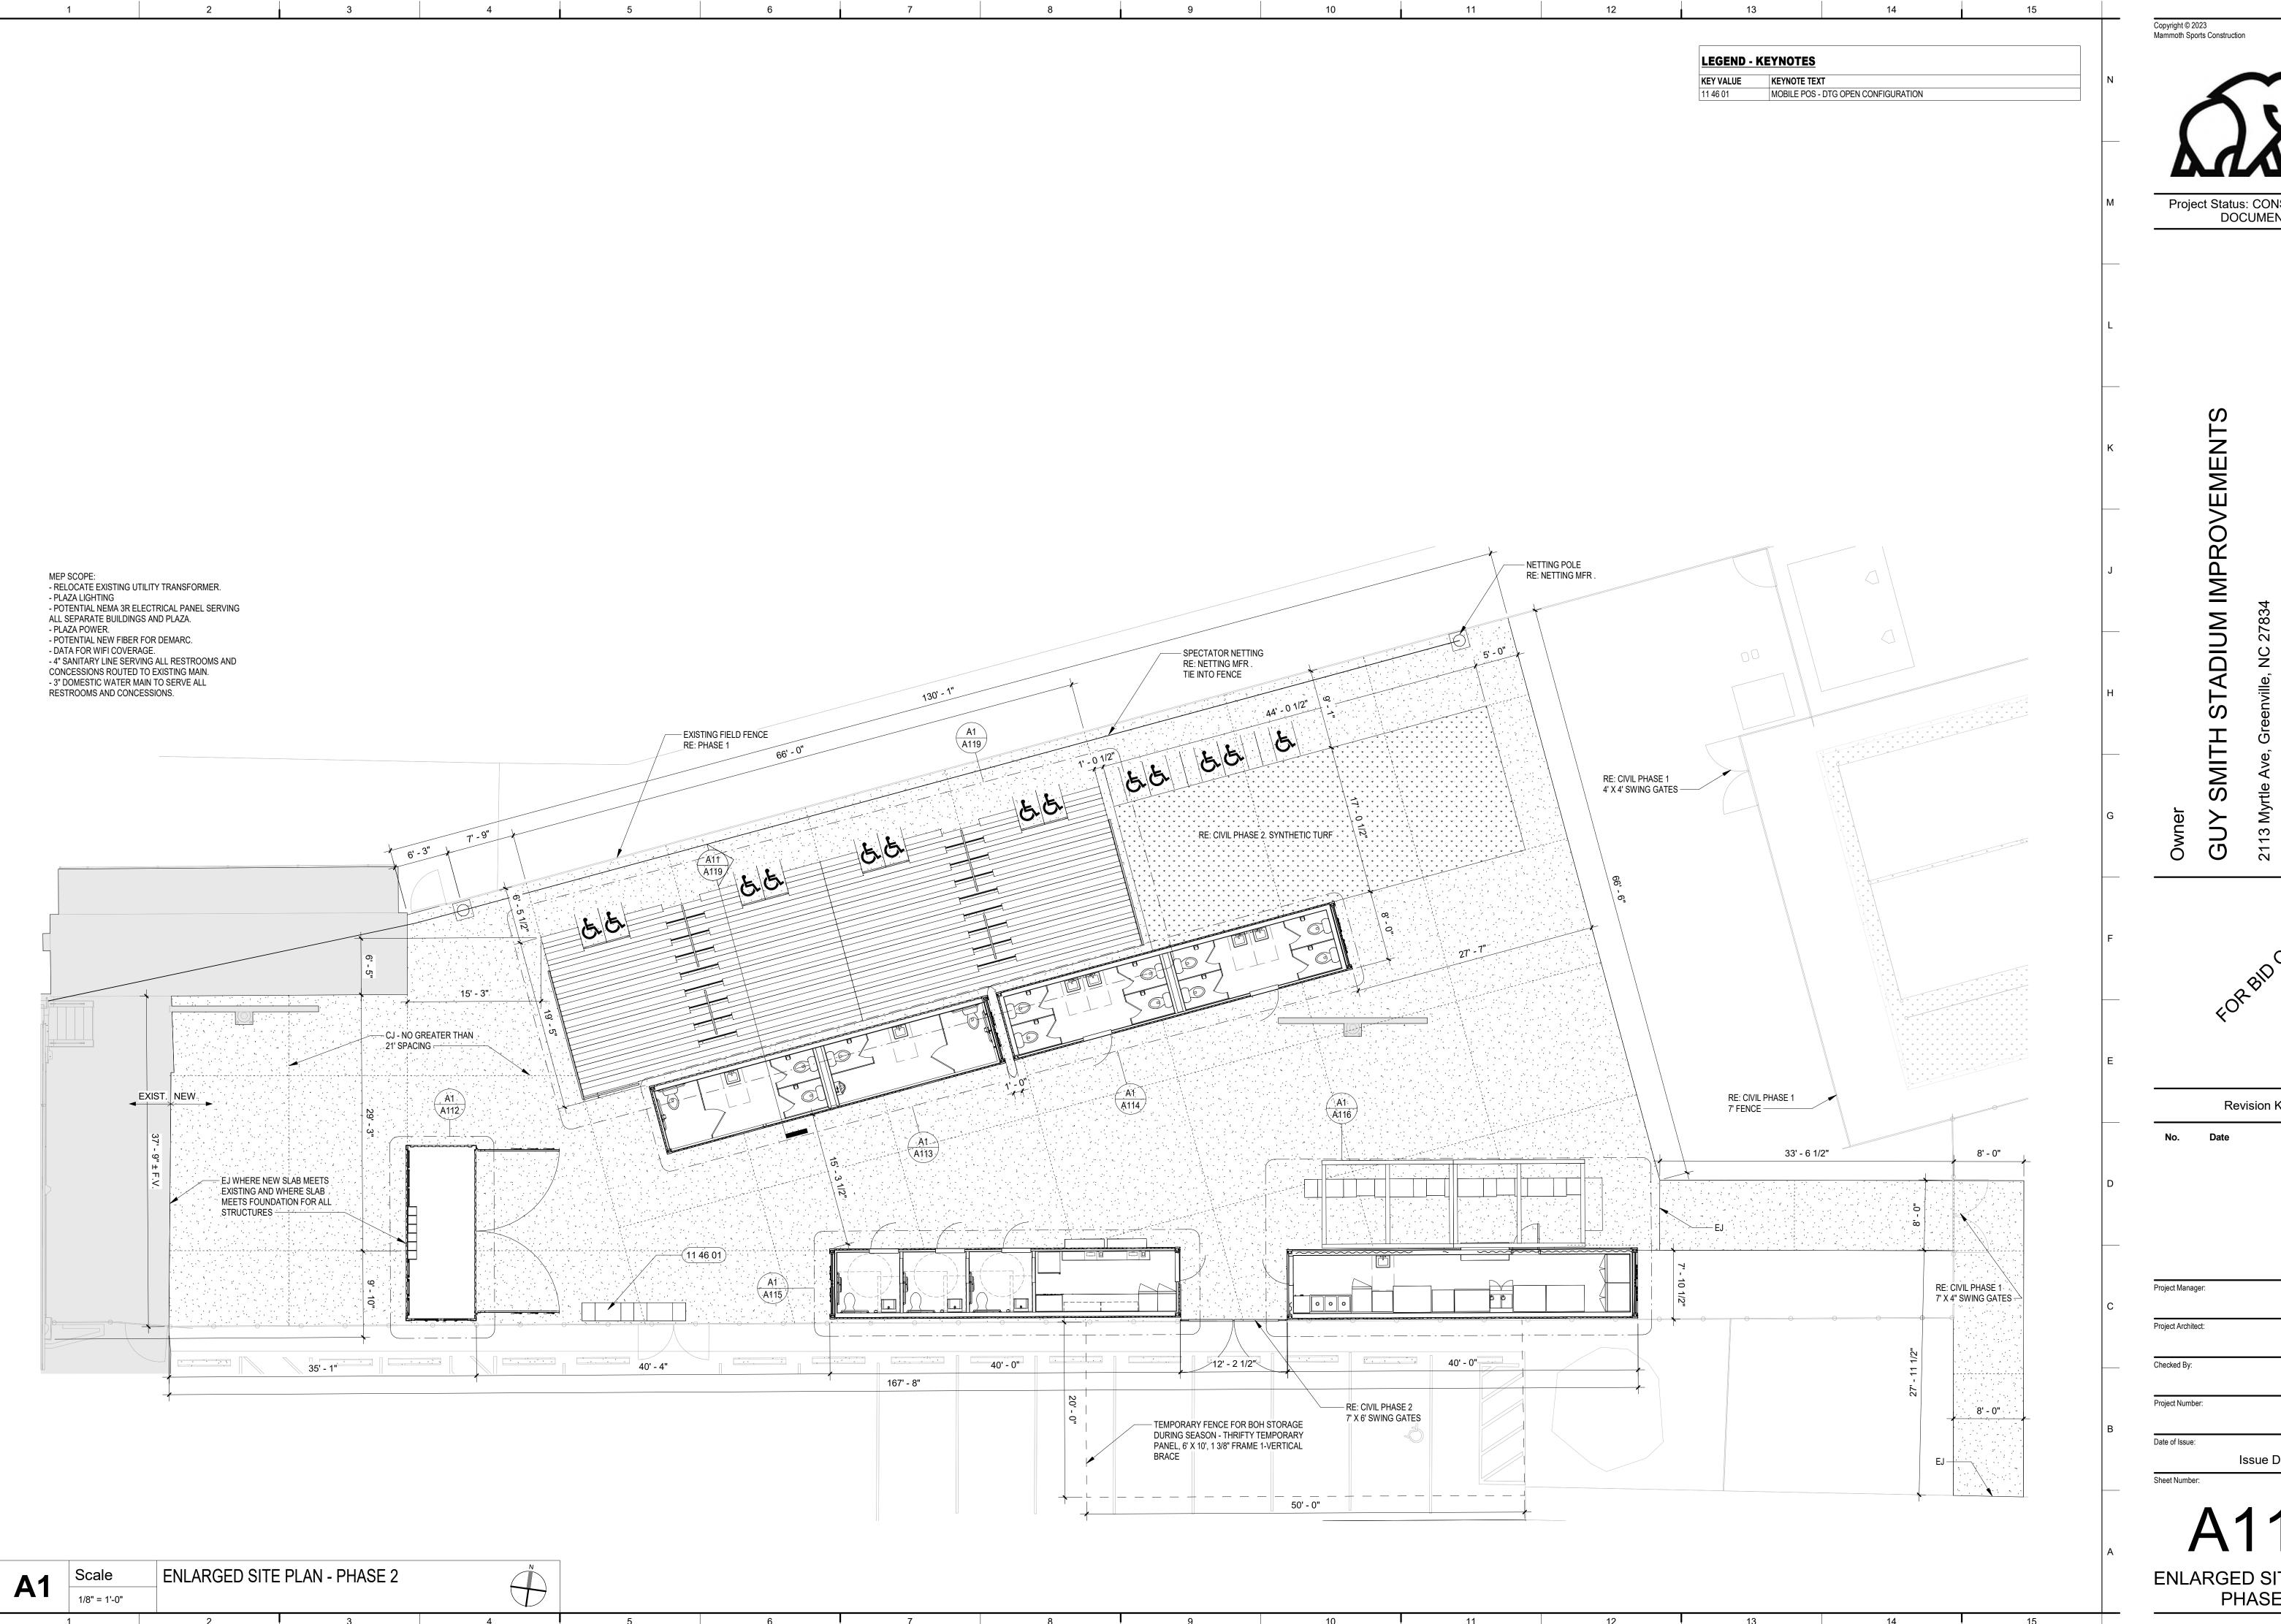

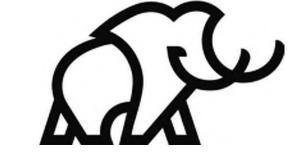


Project Status: CONSTRUCTION DOCUMENTS

Revision Key


Project Manager: Project Architect: Checked By: Checker Project Number: 23-0176 Date of Issue: Issue Date: 9/20/2023

ENLARGED SITE PLAN -PHASE 2

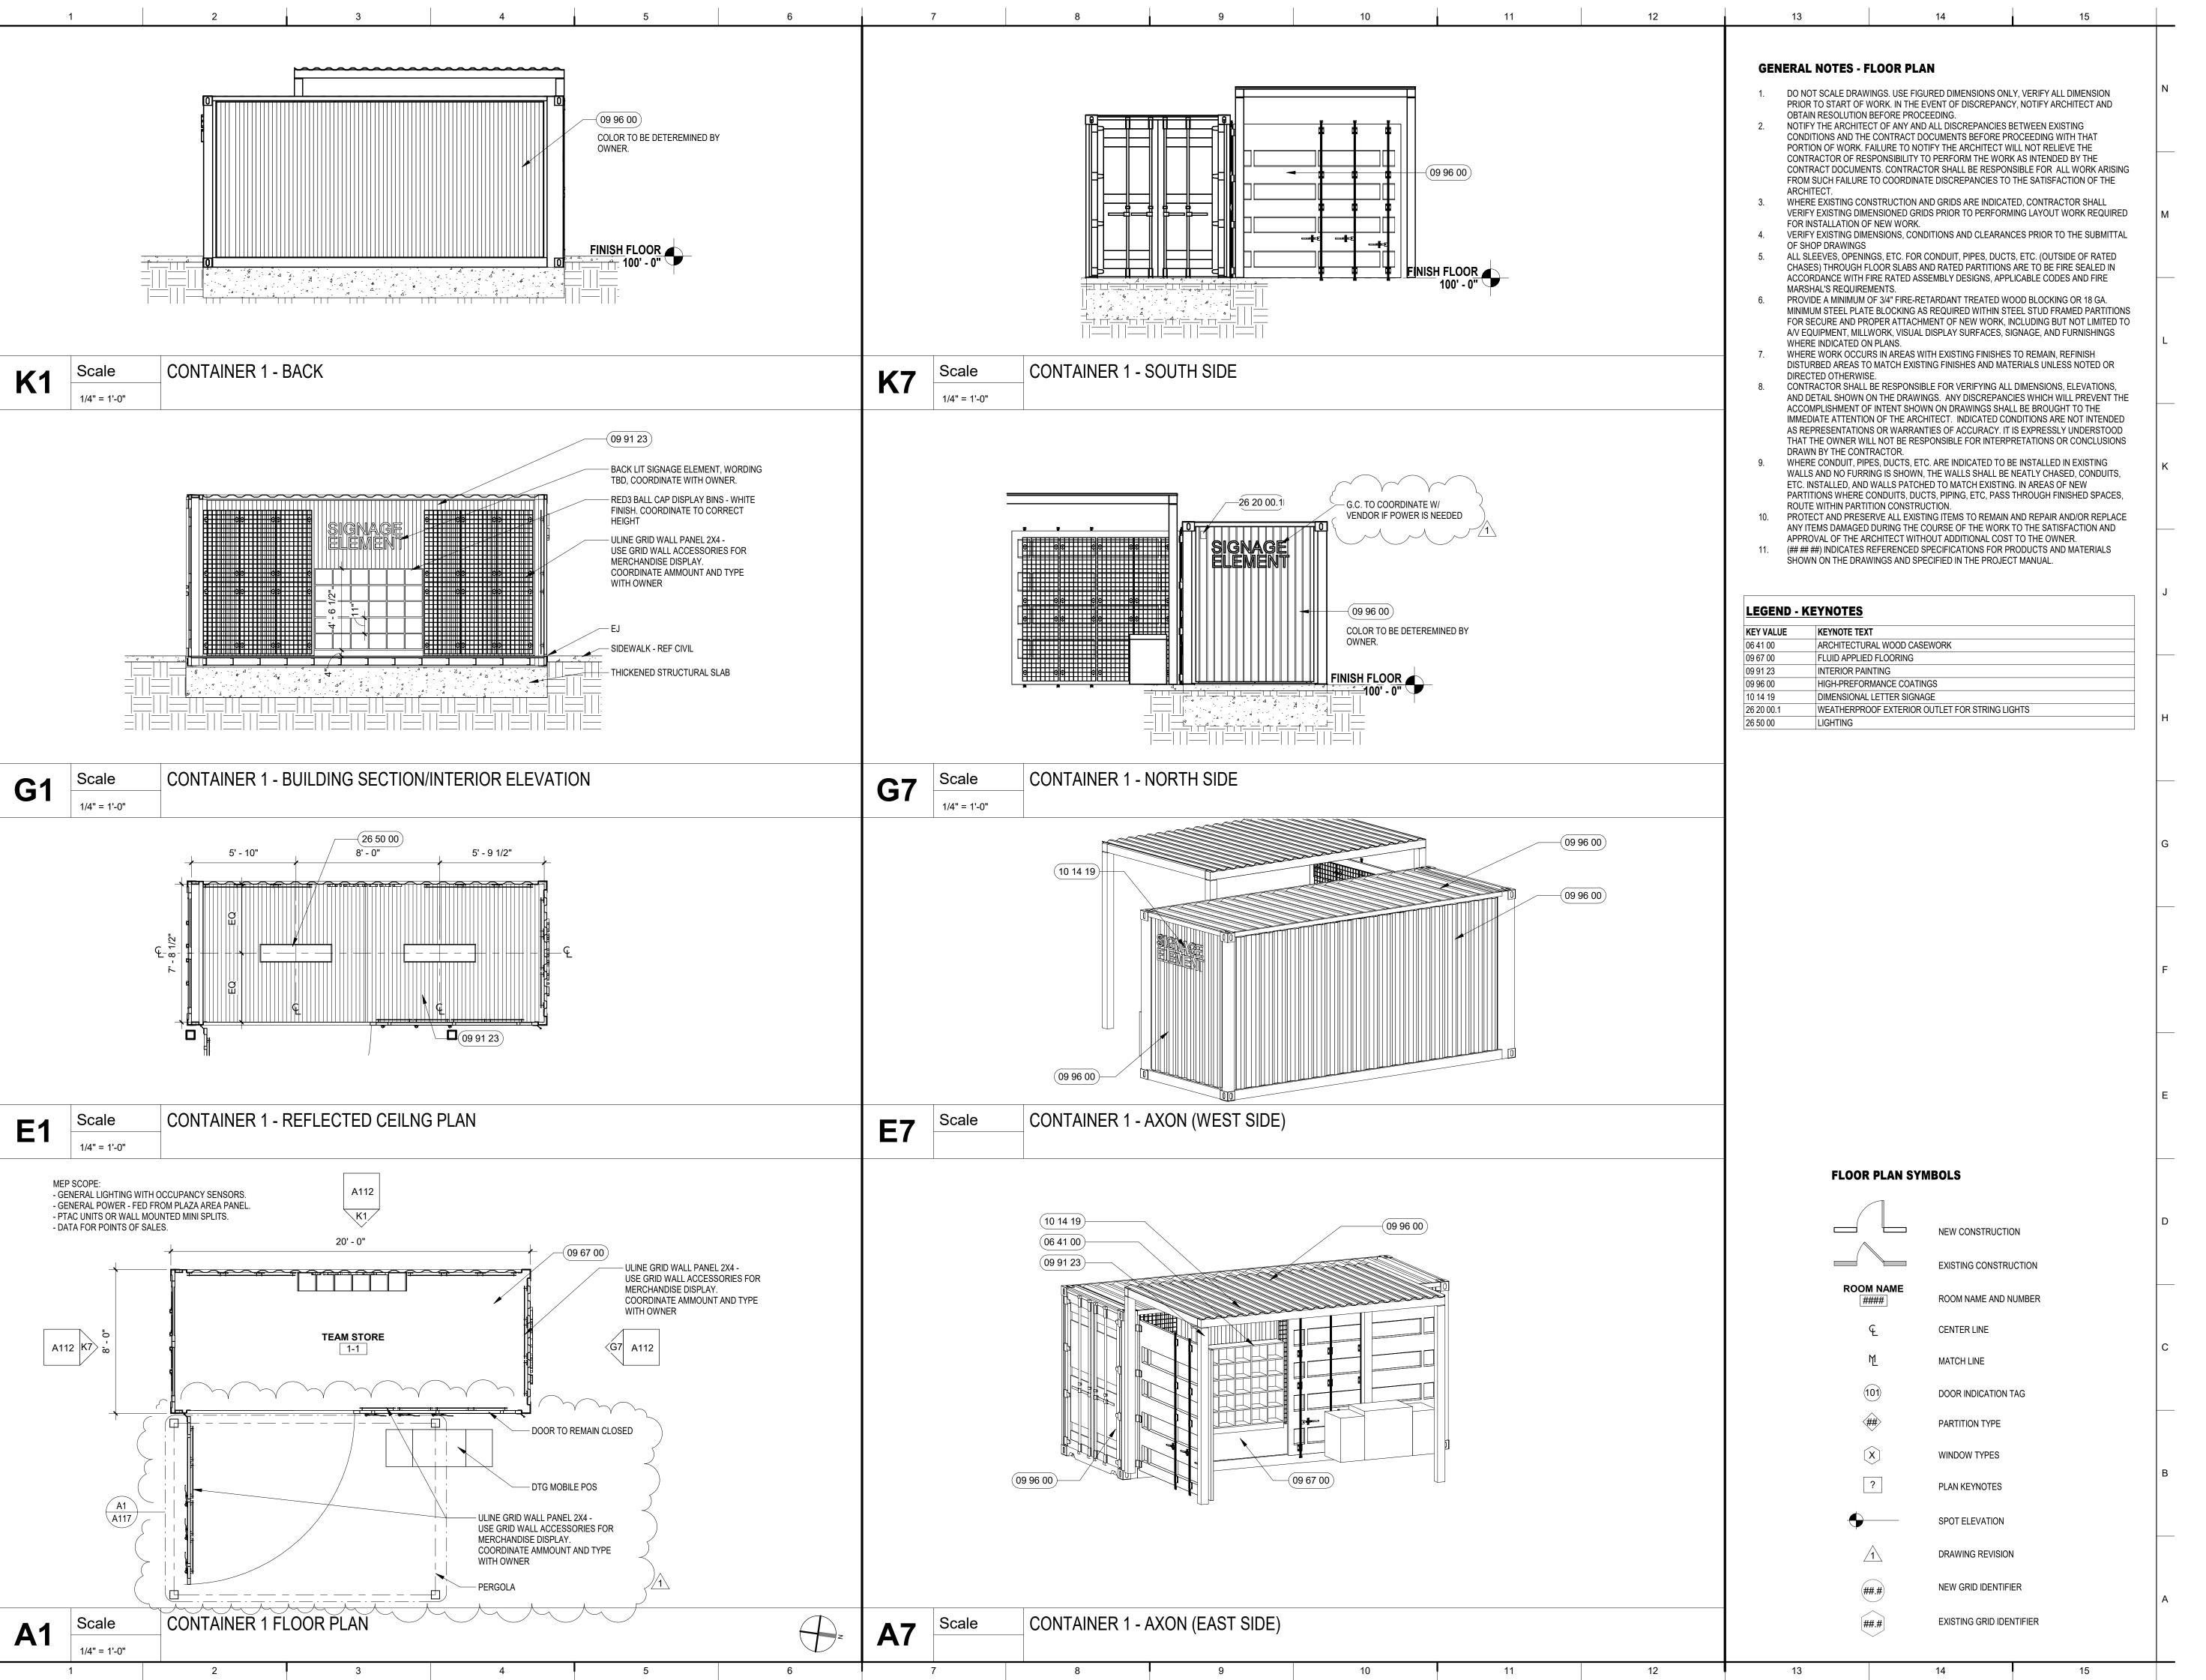

Mammoth Sports Construction

Copyright © 2023

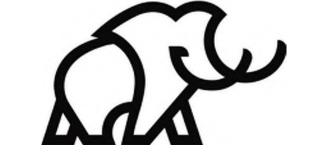

Project Status: CONSTRUCTION DOCUMENTS

3UY SMITH STADIUM IMPROVEMENT

FORBIDOMIX

No. Date Description
1 9/29/23 REV #1

Project Manager:

BH

Project Architect:

DF

Checked By:


DD

Project Number:

23-0176

Issue Date: 9/22/2023
Sheet Number:

CONTAINER 1
PLANS/ELEVATIONS

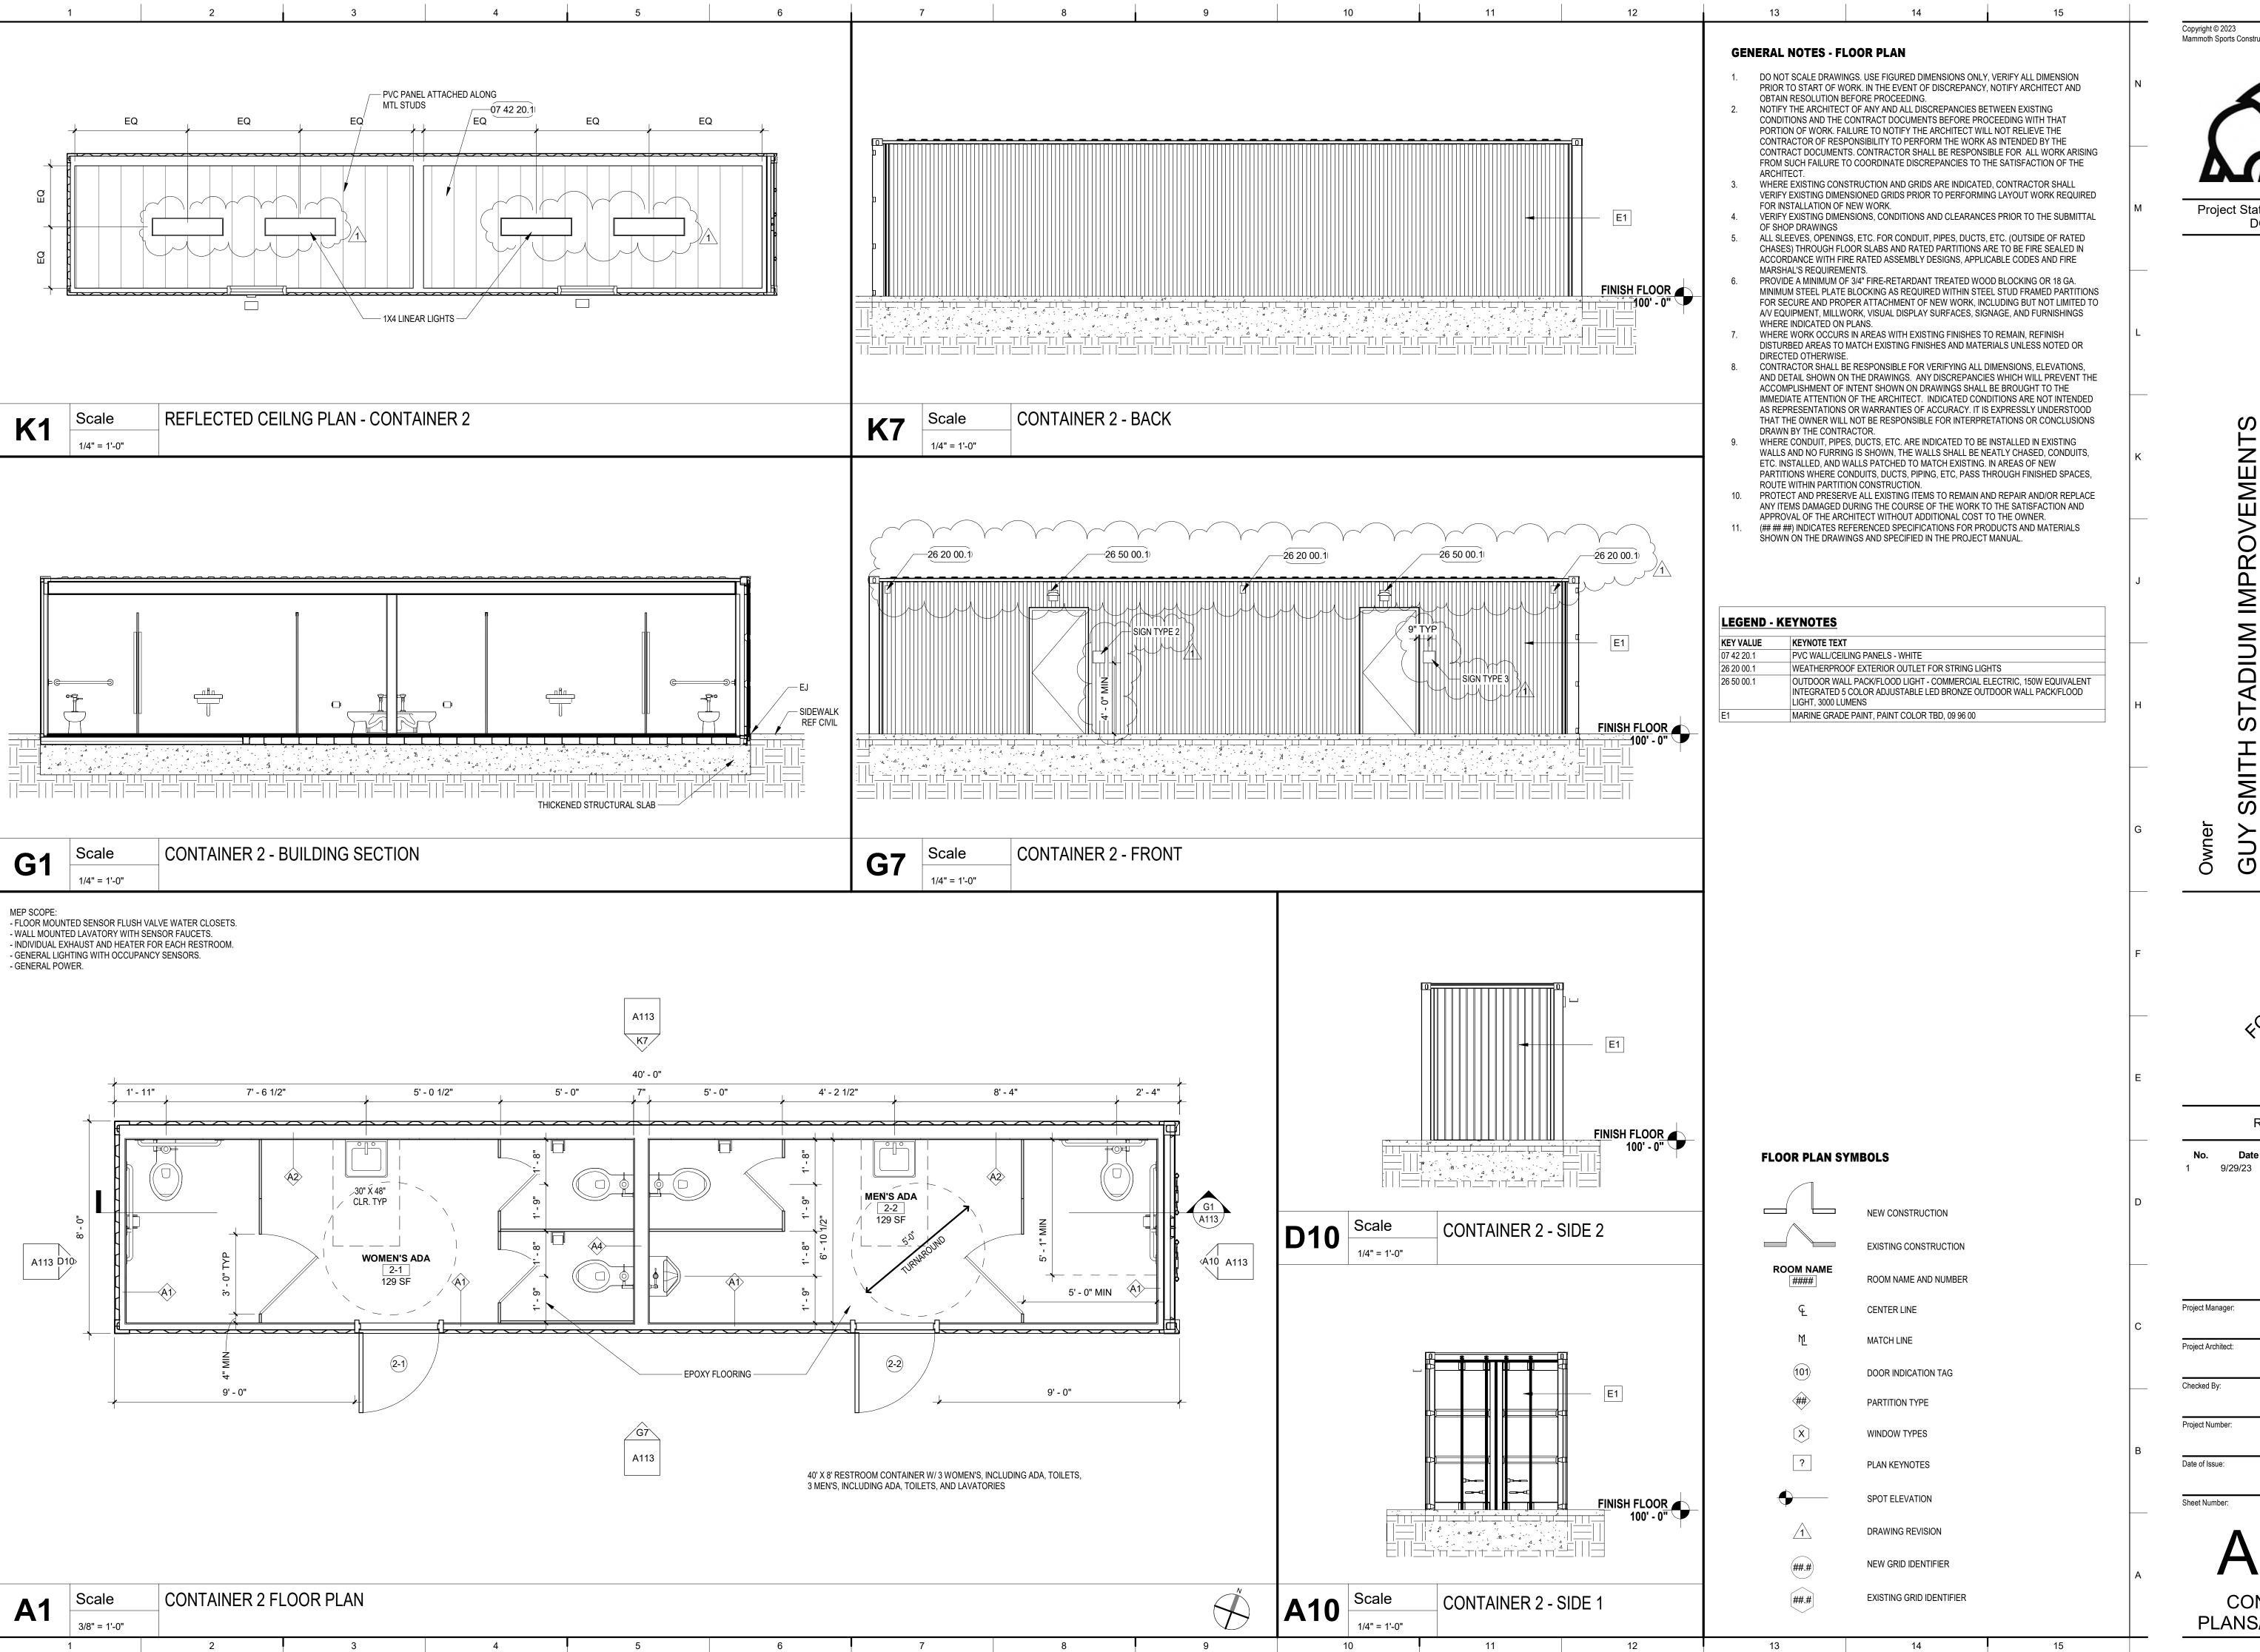




Project Status: CONSTRUCTION DOCUMENTS

Revision Key REV #1

Project Manager: Project Architect Checked By: Checker Project Number: 23-0176

Date of Issue: Issue Date: 9/22/2023

CONTAINER 2 PLANS/ELEVATIONS

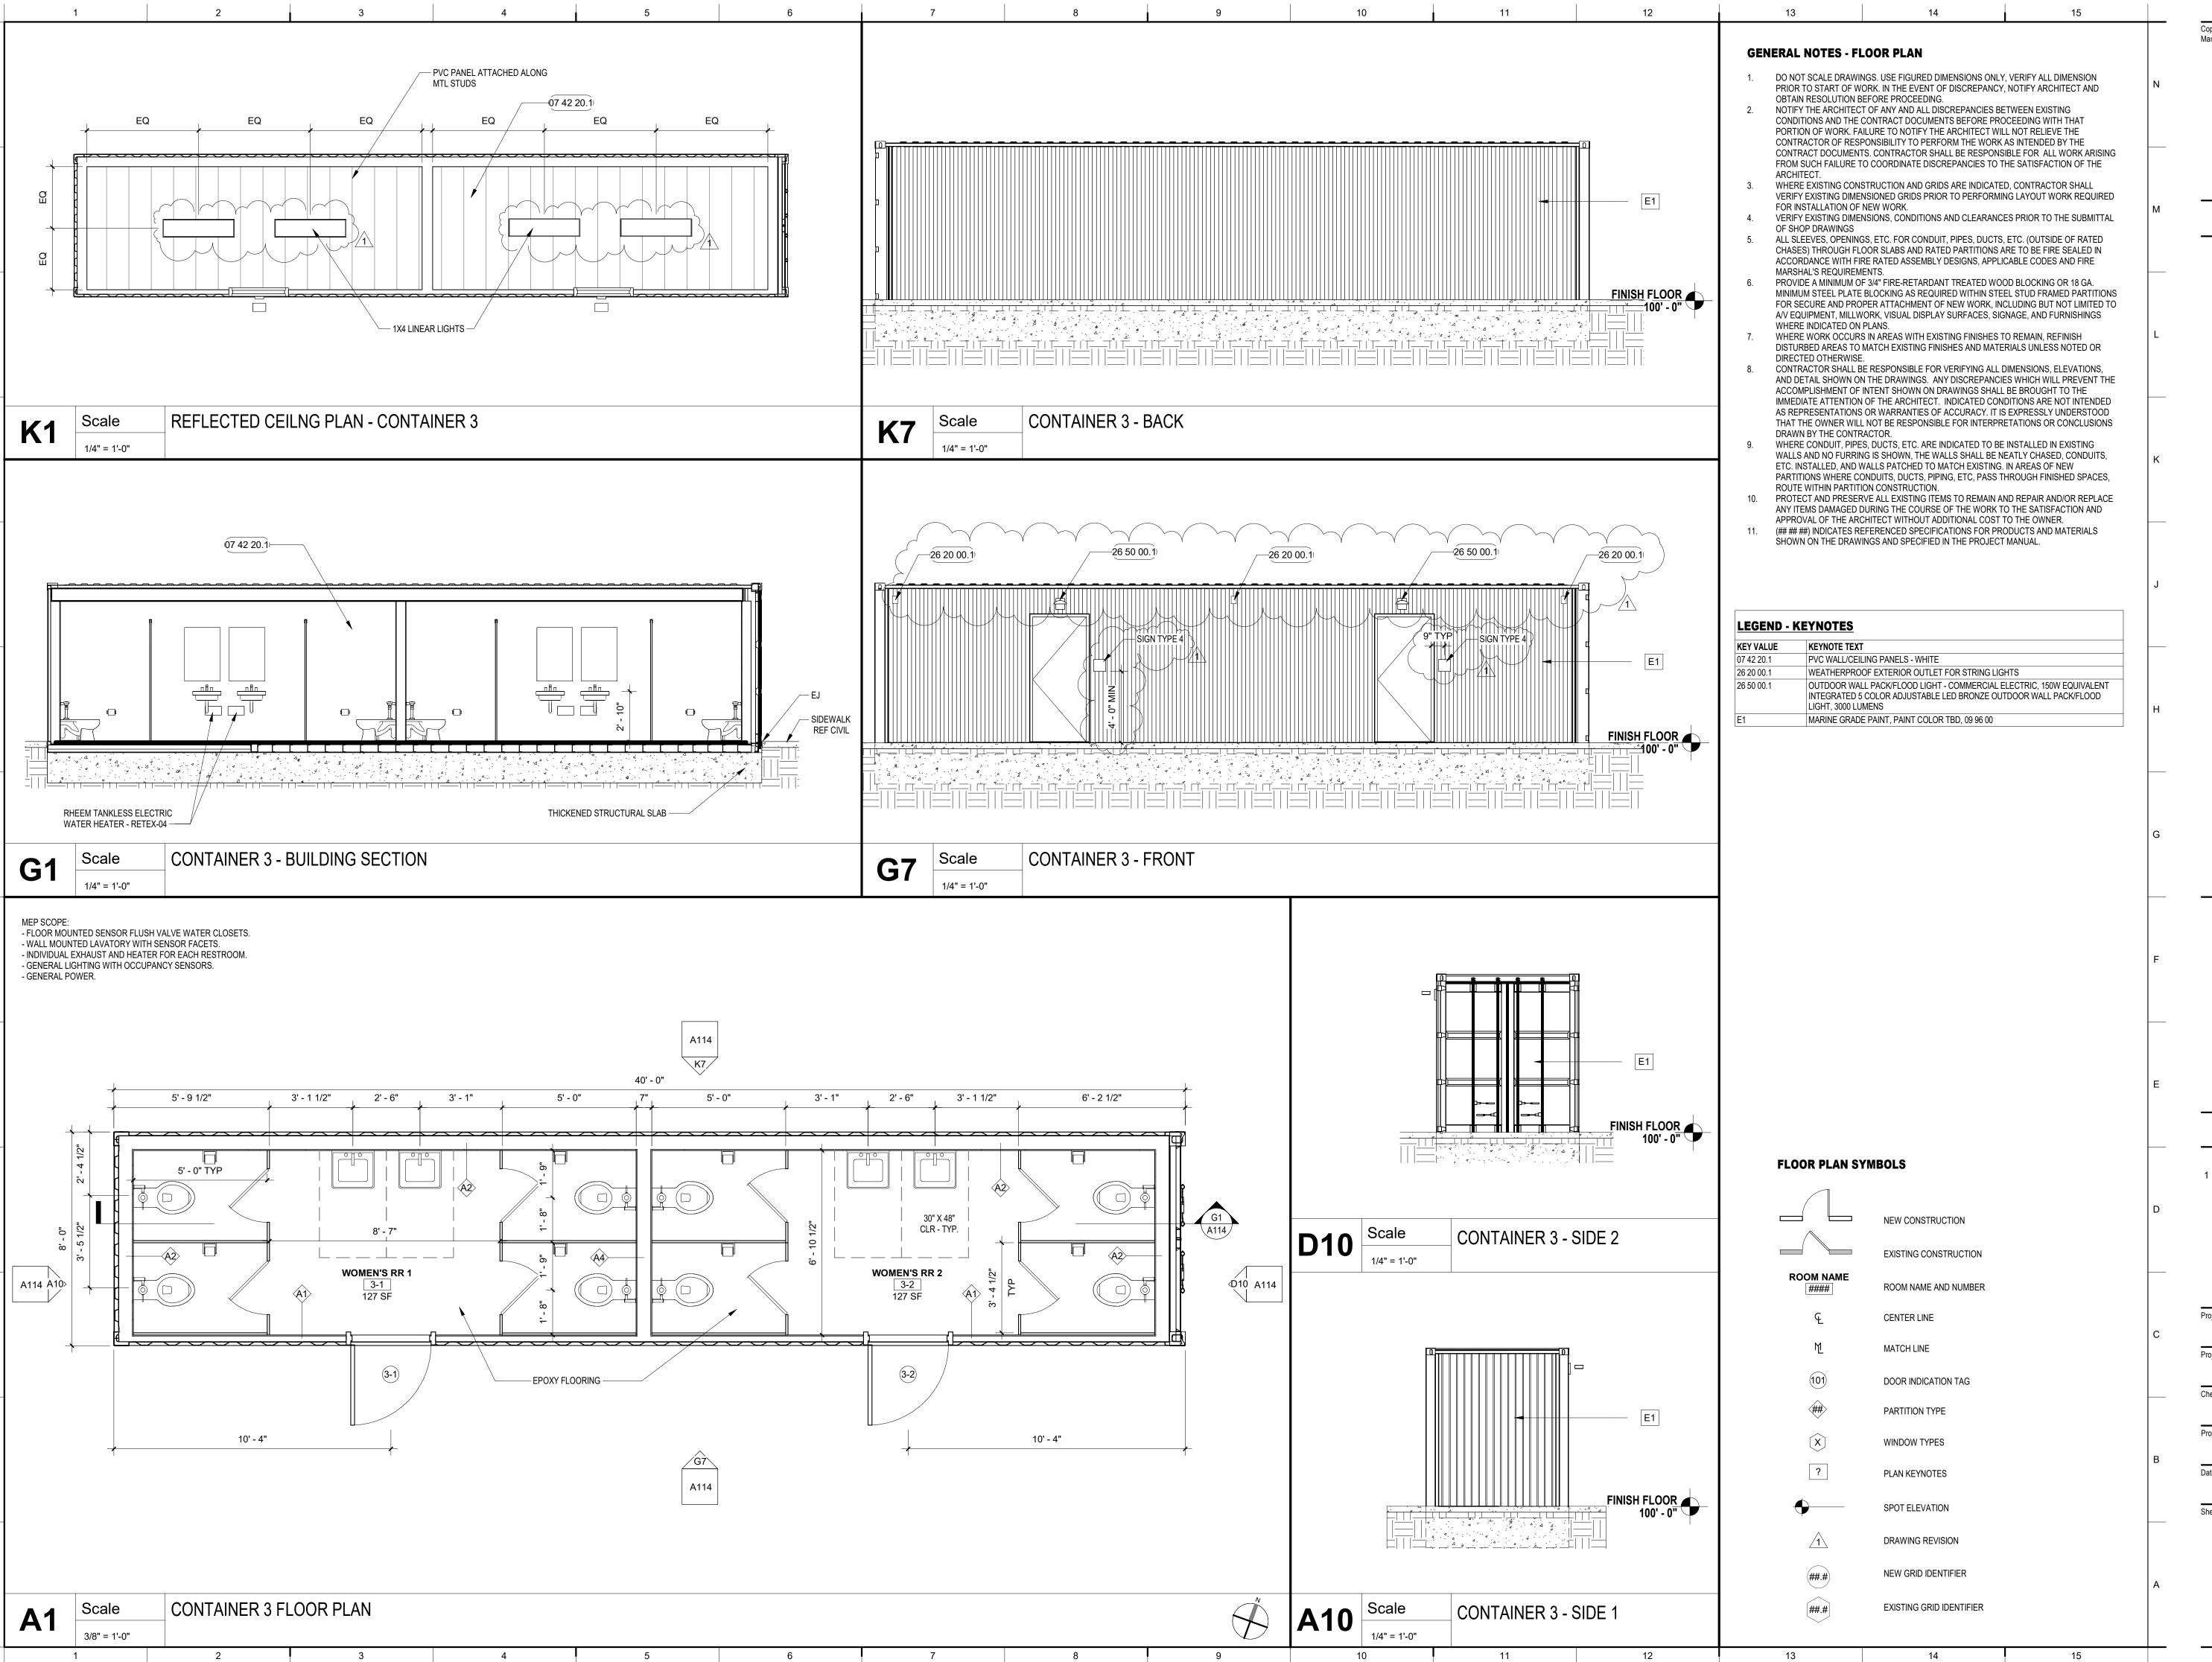



Project Status: CONSTRUCTION DOCUMENTS

UY SMITH STADIUM IMPROVEMENTS

FORBIDOMIX

Revision Key

No. Date Description

1 9/29/23 REV #1

Project Manager:

BH

Project Architect:

DF

Checked By:

Checker


Project Number:

23-0176

Date of Issue:

Issue Date: 9/22/2023
Sheet Number:

CONTAINER 3
PLANS/ELEVATIONS

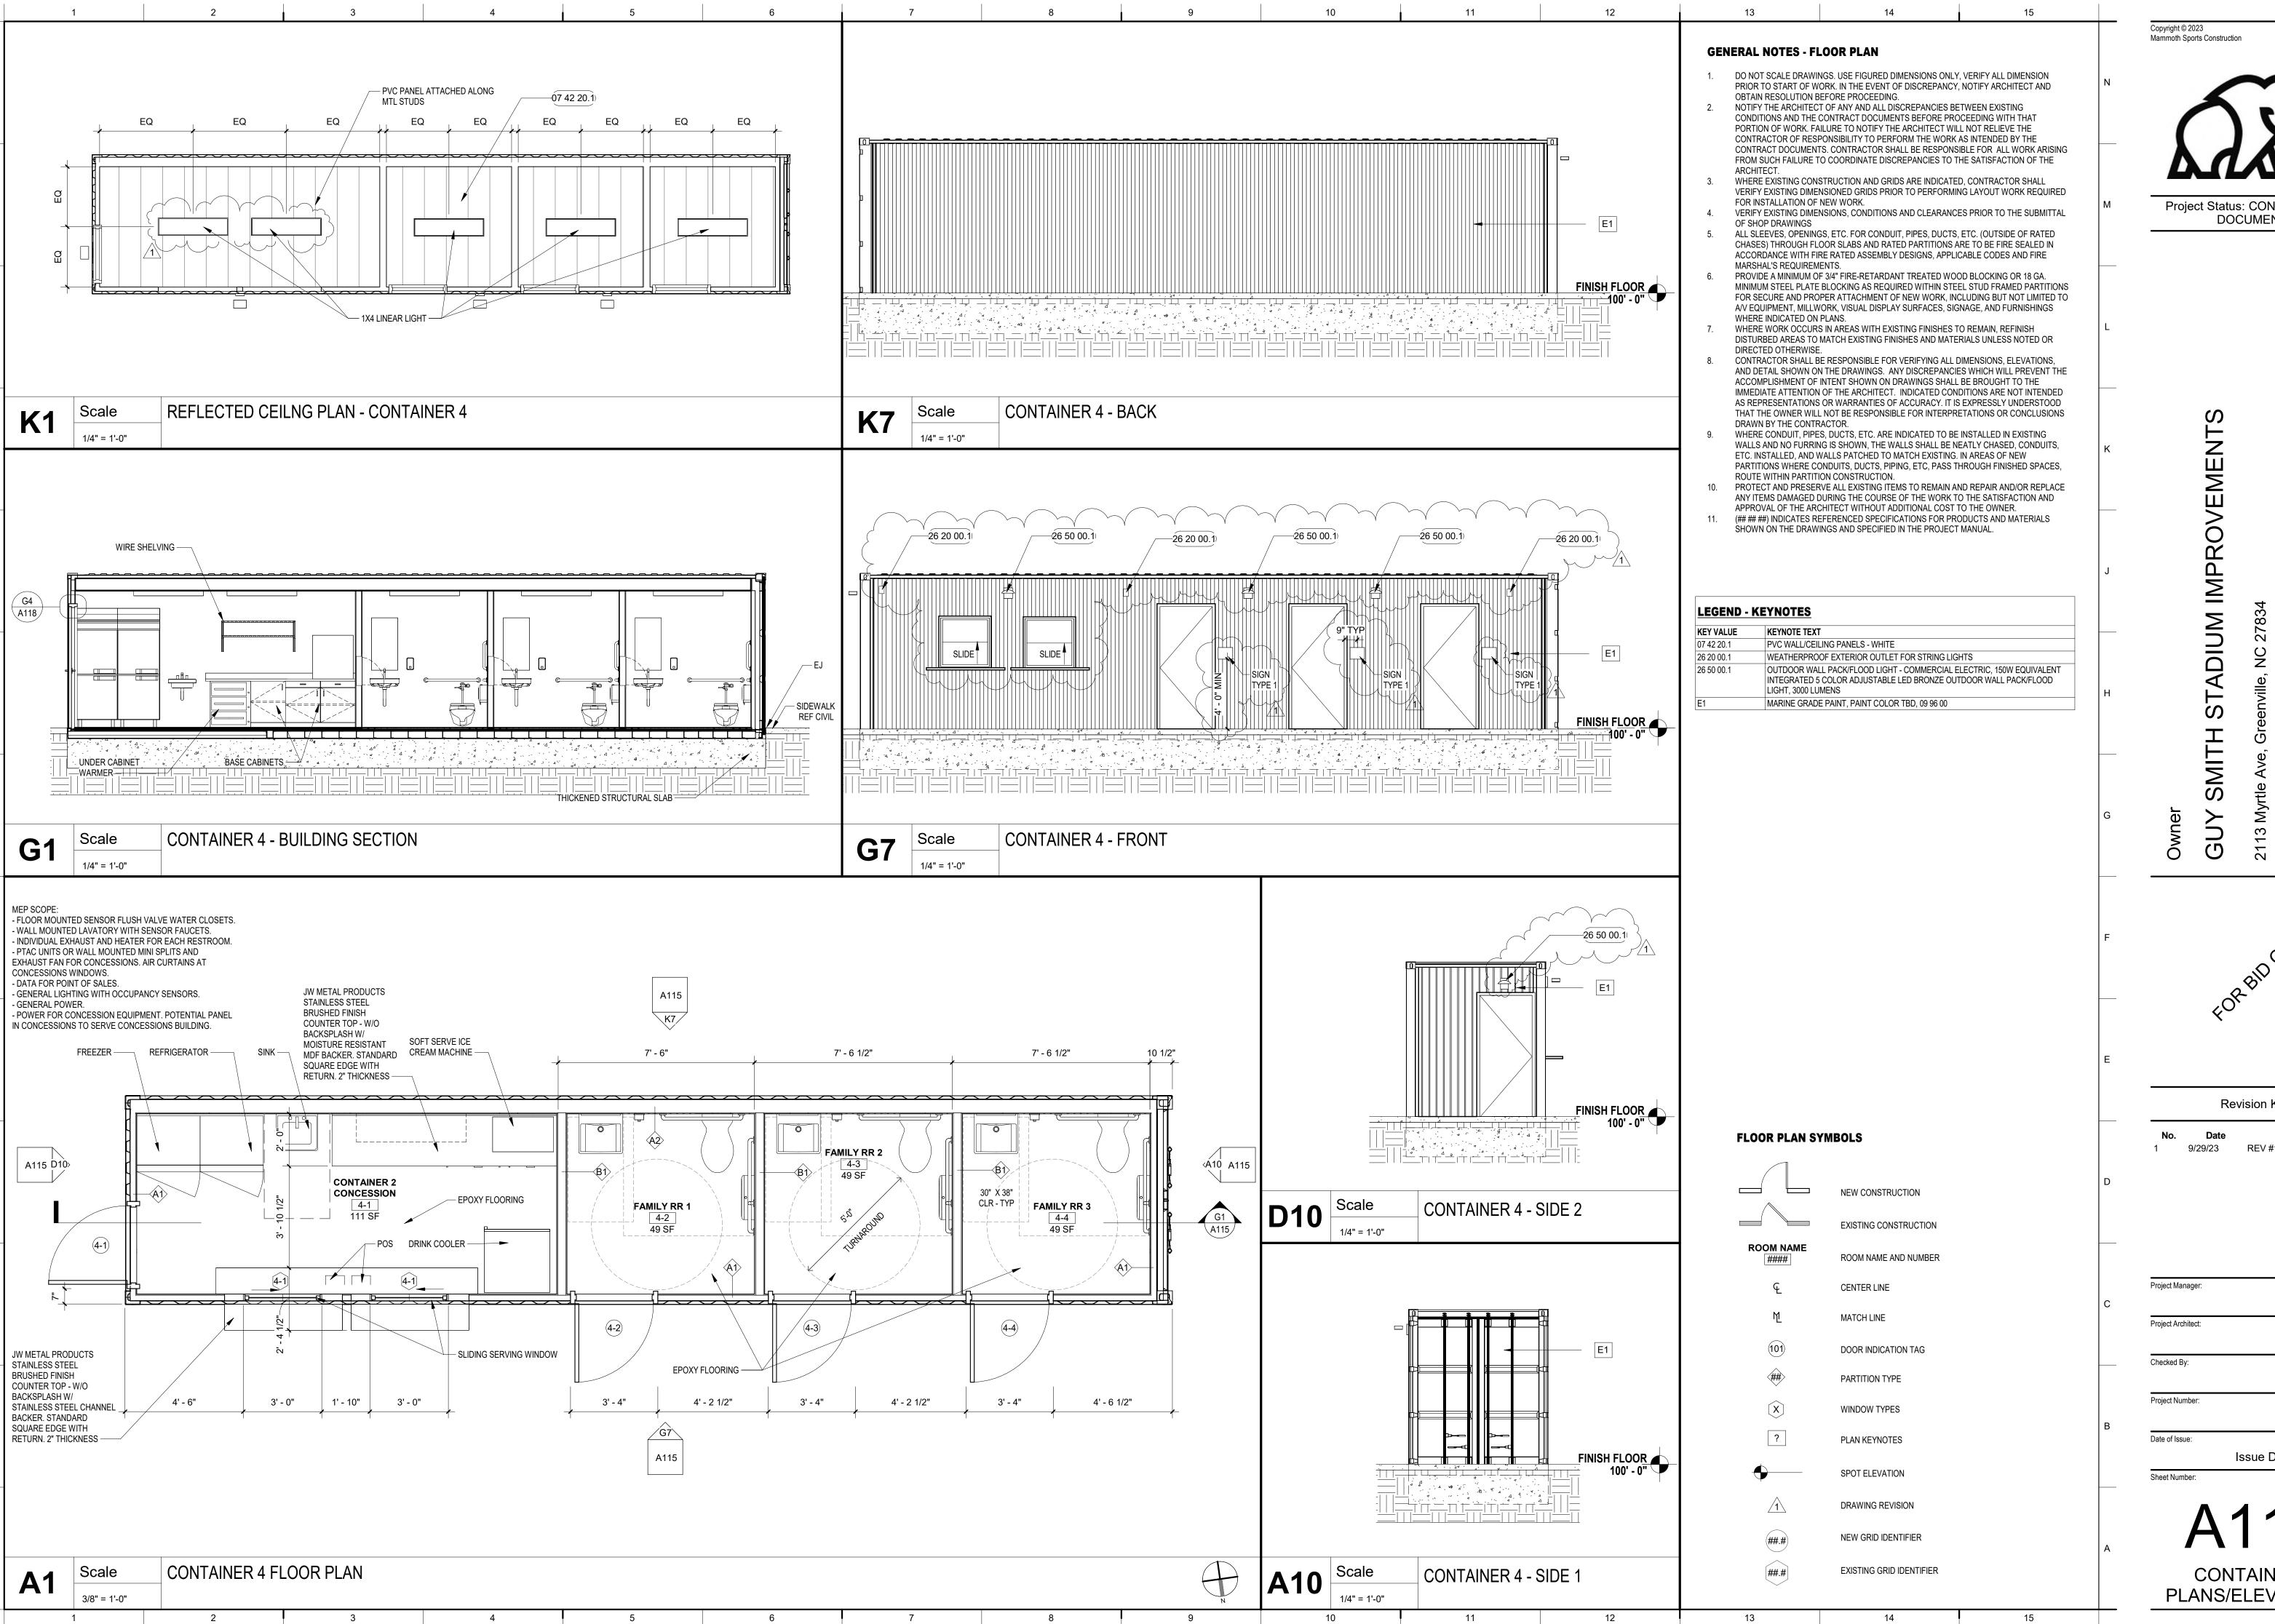





Project Status: CONSTRUCTION DOCUMENTS

Revision Key 1 9/29/23 REV #1

Project Manager: Project Architect Checked By: Checker Project Number: 23-0176 Date of Issue: Issue Date: 9/22/2023

CONTAINER 4 PLANS/ELEVATIONS

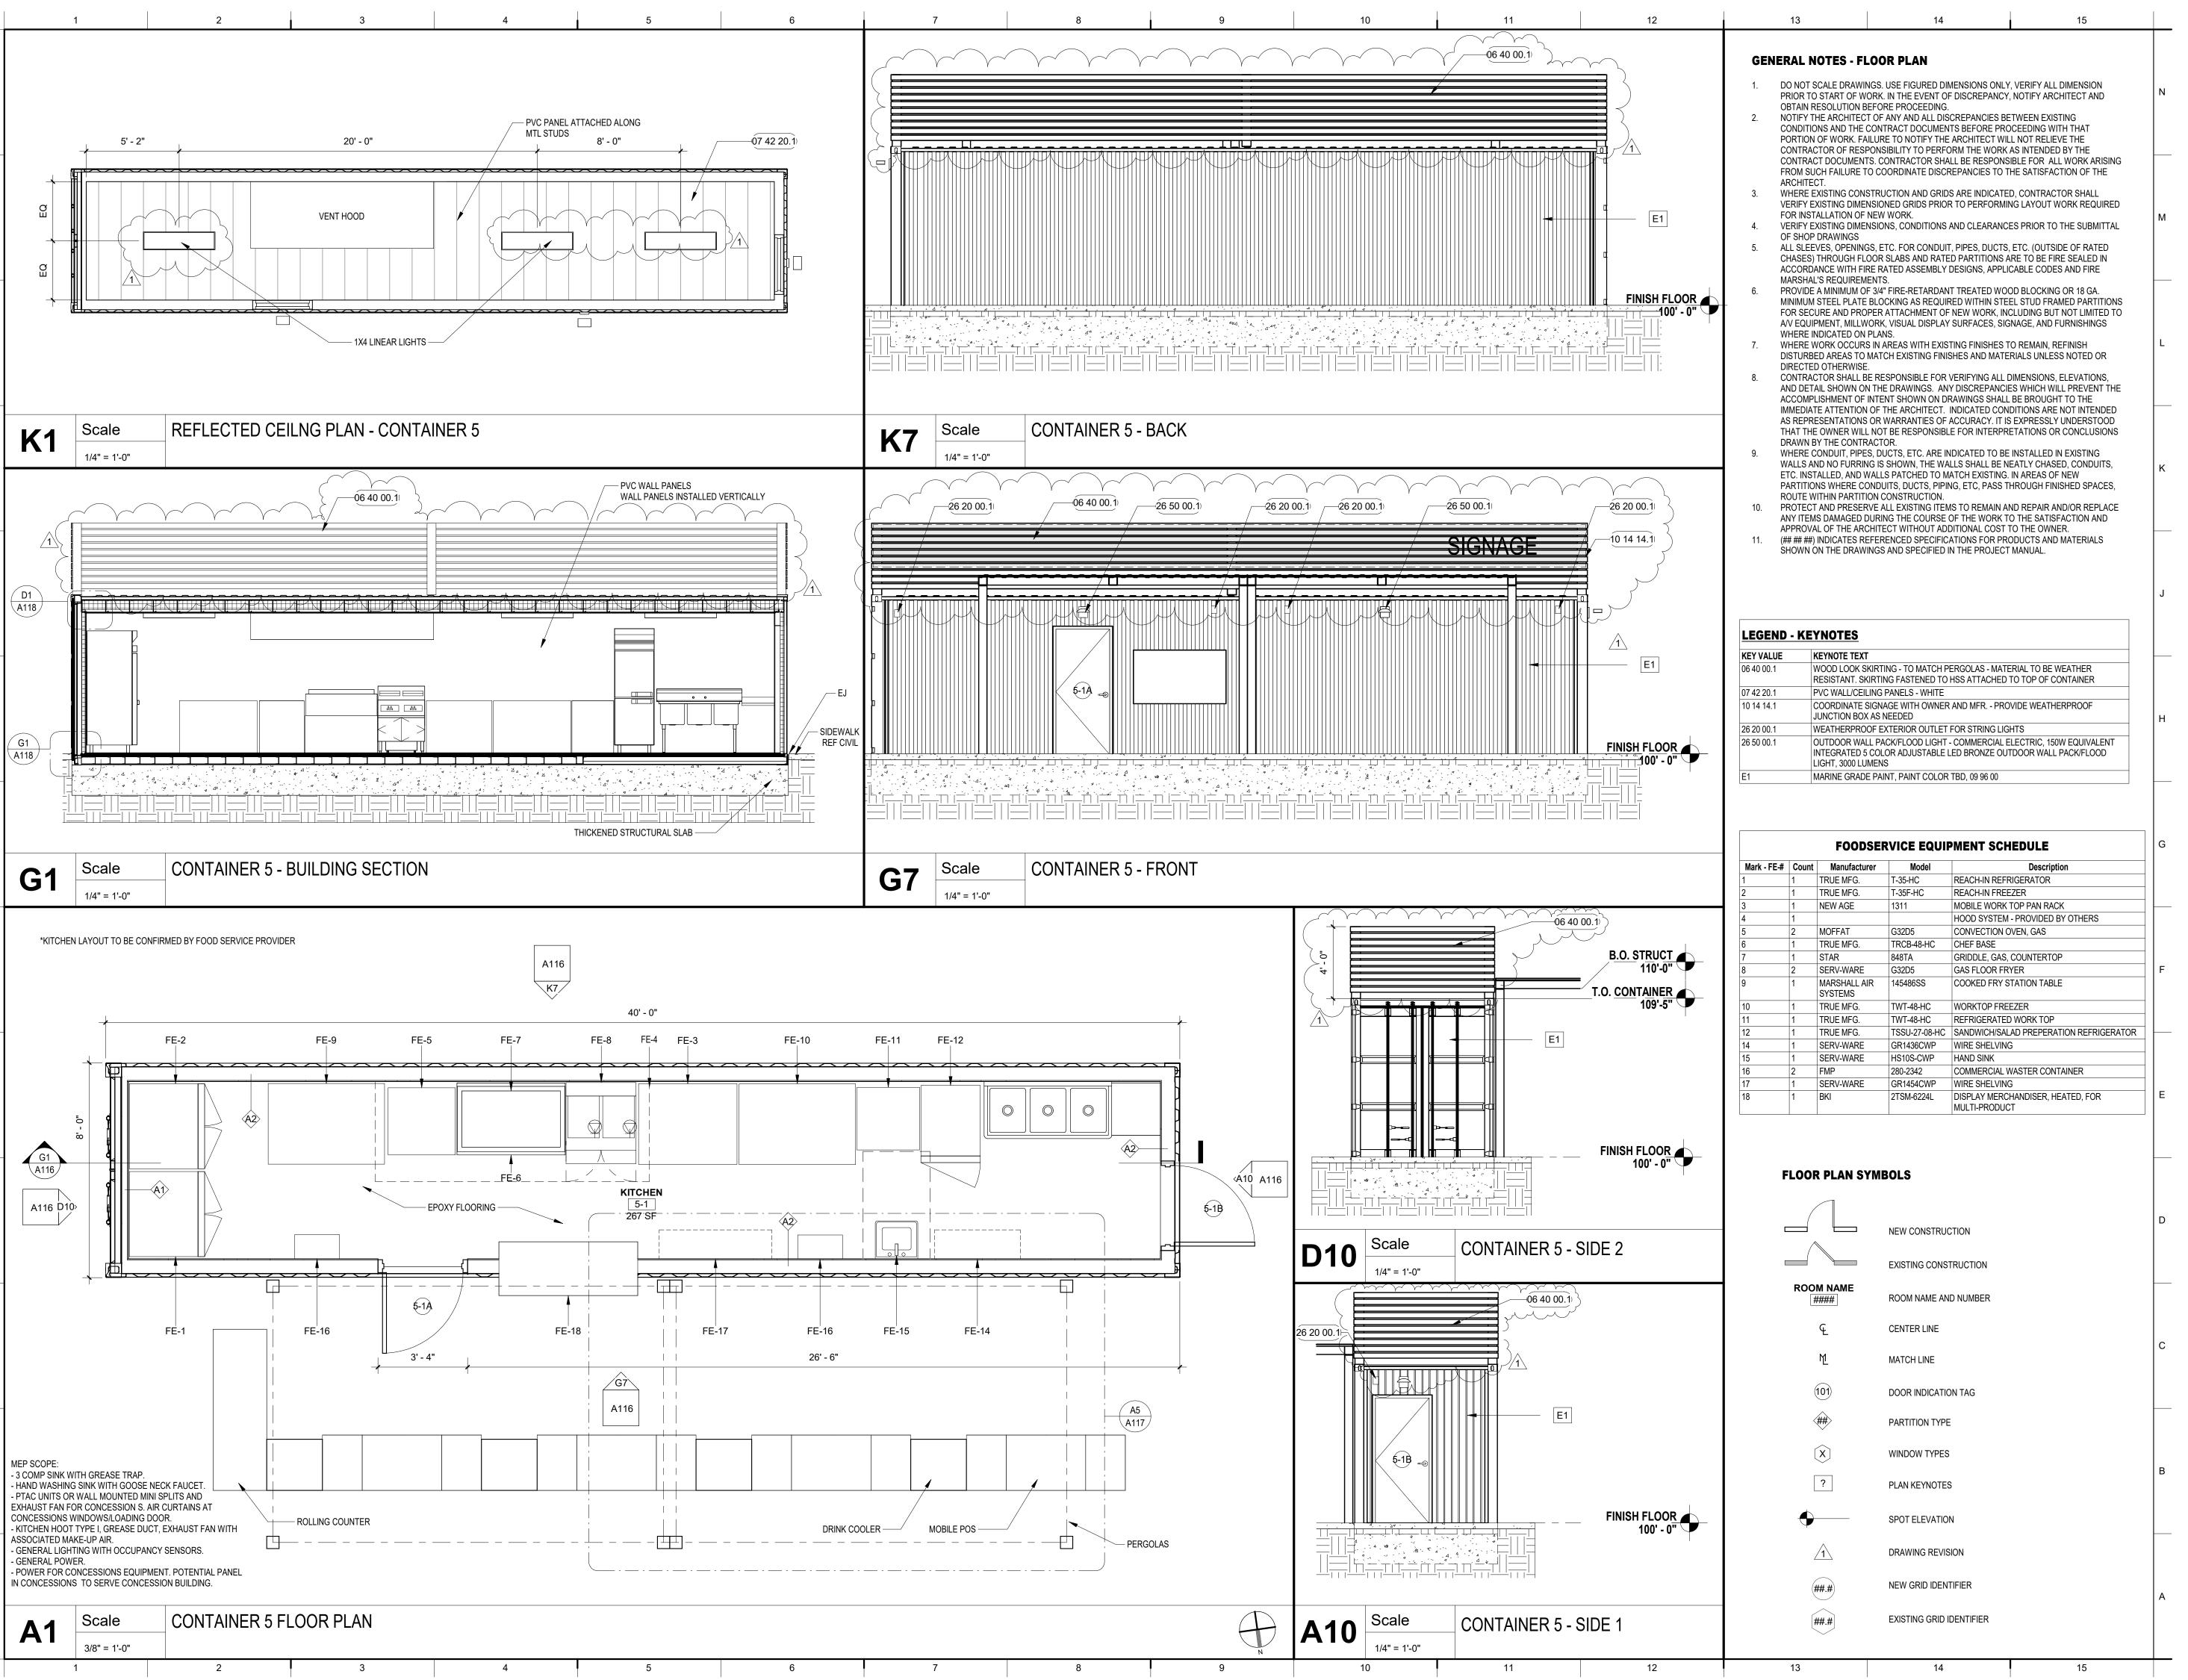

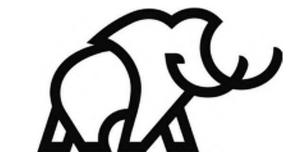

Project Status: CONSTRUCTION DOCUMENTS

JY SMITH STADIUM IMPROVEMENTS

O D 7

FORBIDOM

Revision Key

No. Date Description

1 9/29/23 REV #1

Project Manager:

BH

Project Architect:

DF

Checked By:

Checker

Project Number:


23-0176


Date of Issue:

Issue Date: 9/22/2023

A116

ADD ALT - CONTAINER 5 PLANS/ELEVATIONS

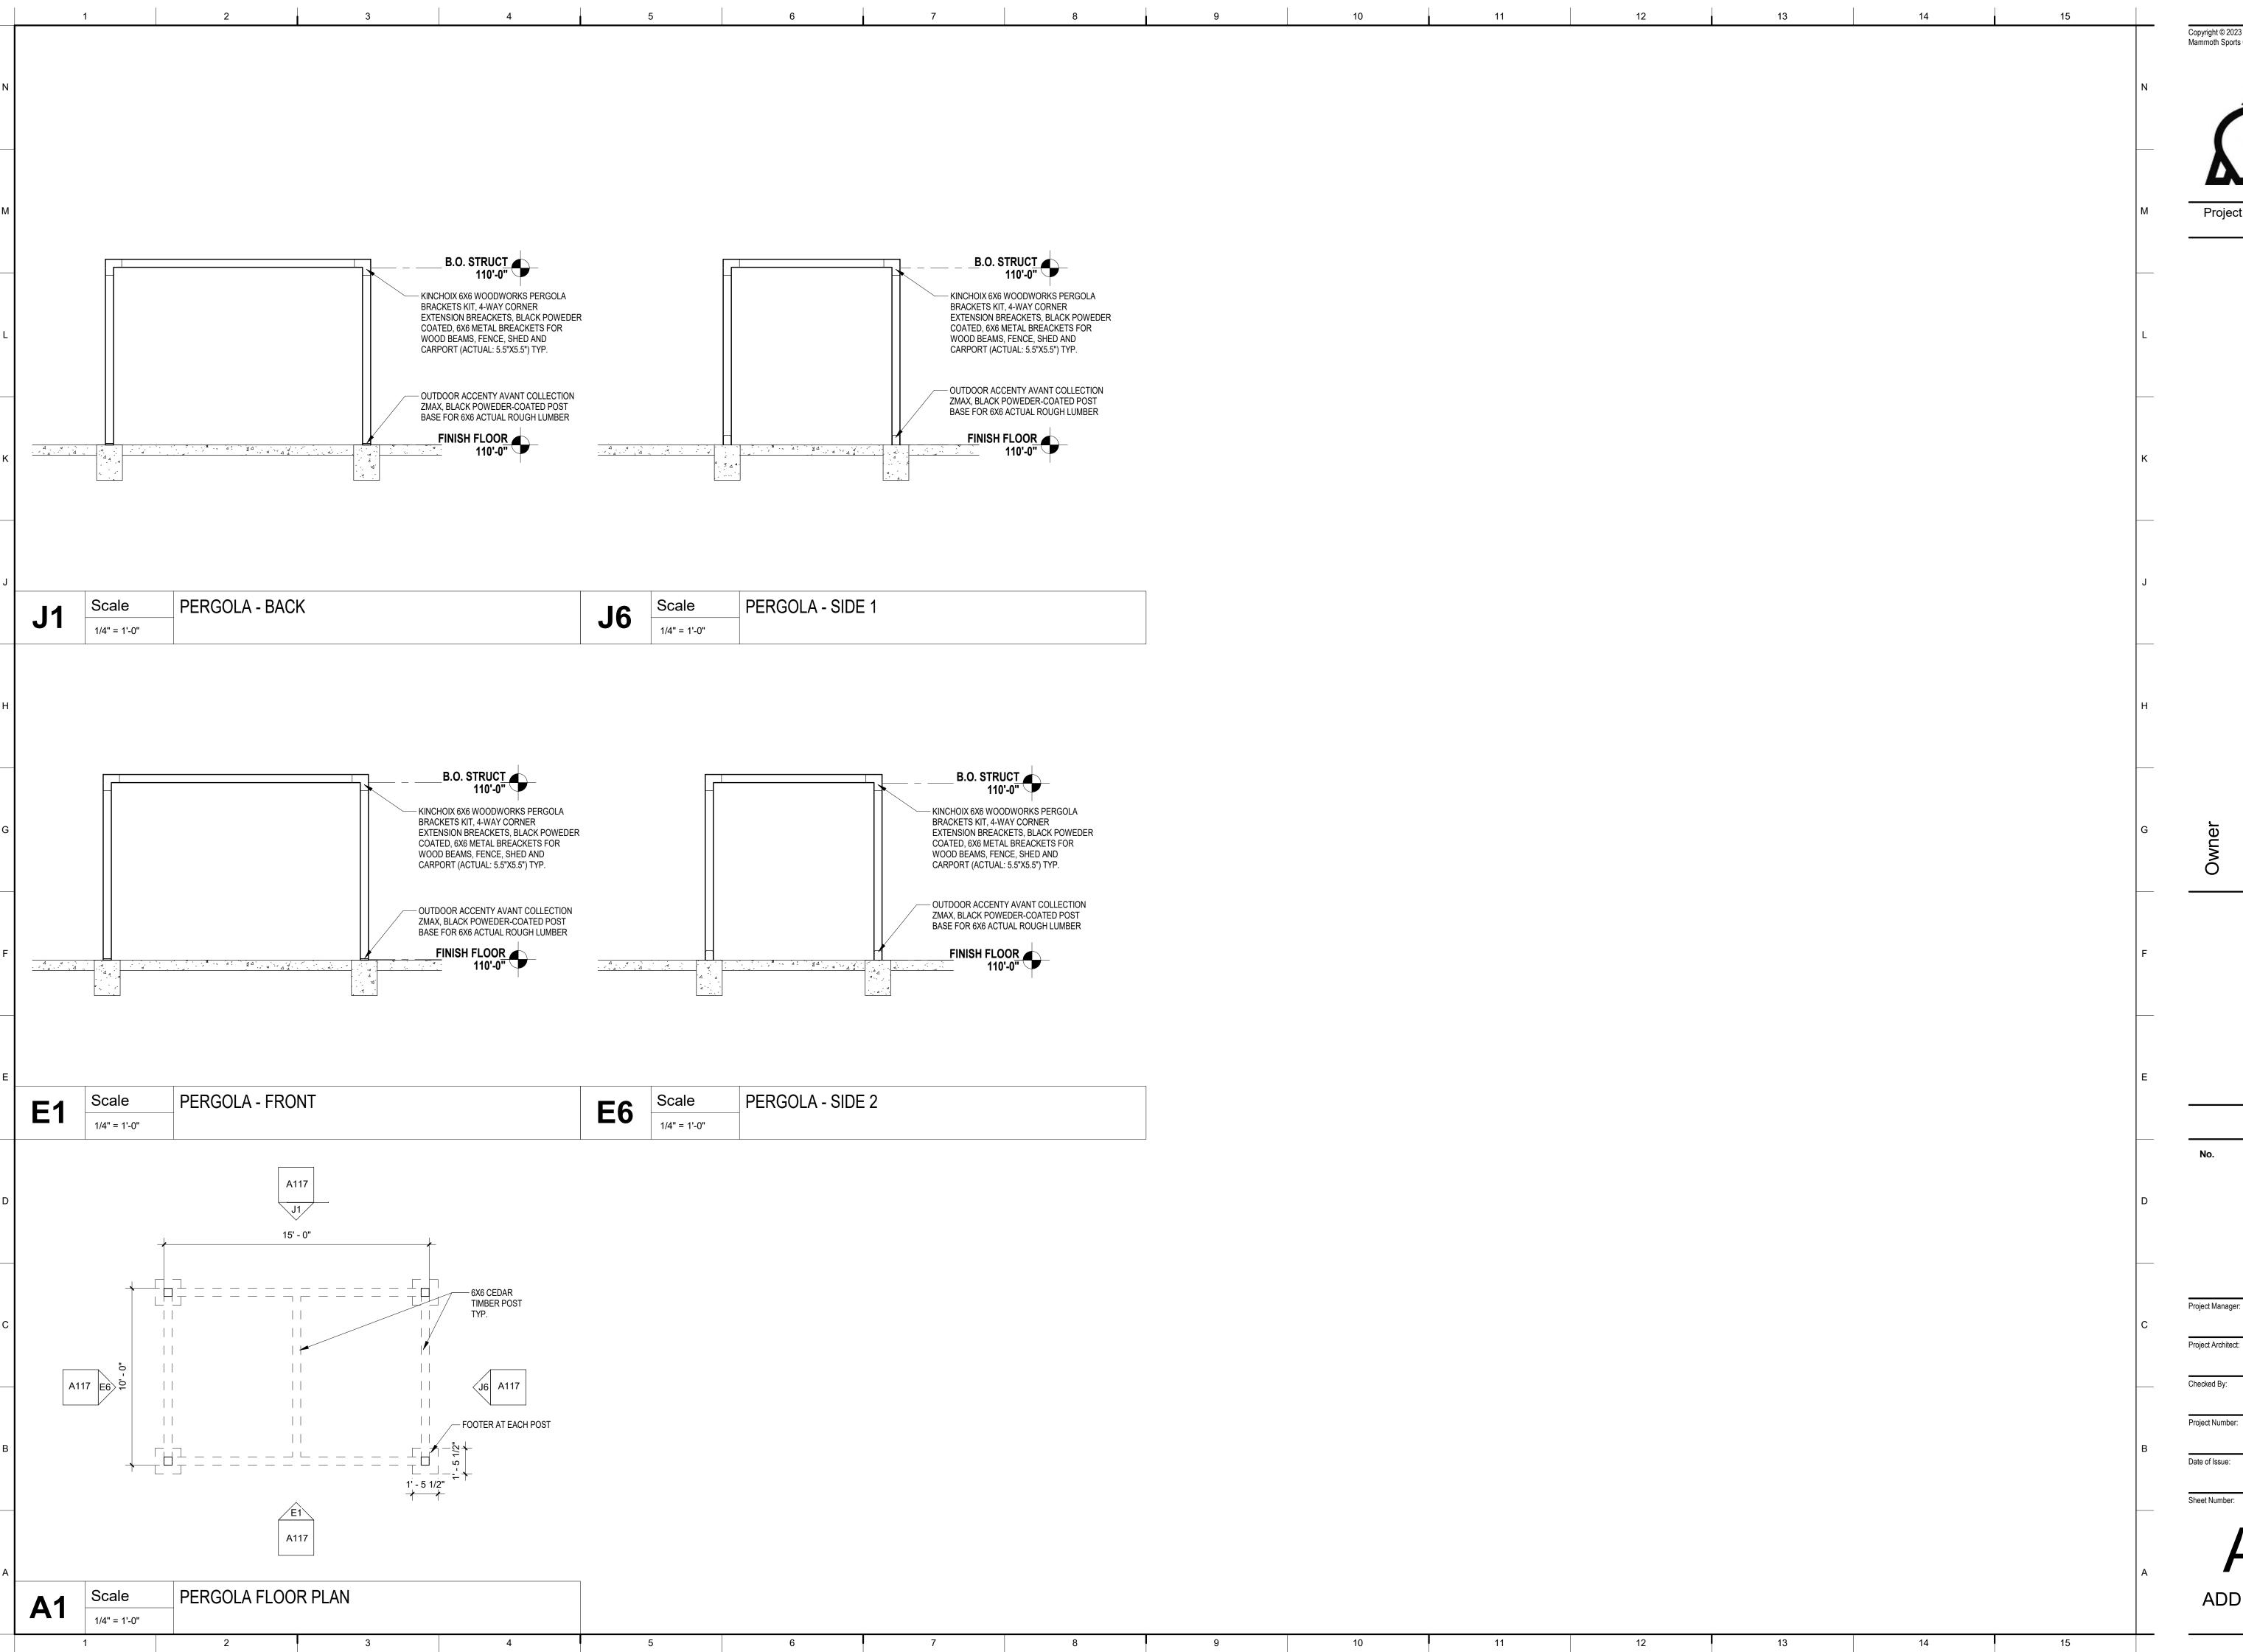

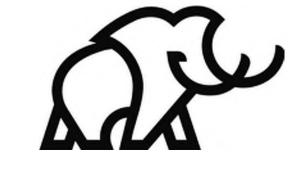

Project Status: CONSTRUCTION DOCUMENTS

O D 2




Revision Key


Checker 23-0176

Issue Date: 9/20/2023

ADD ALT - PERGOLA **PLANS**

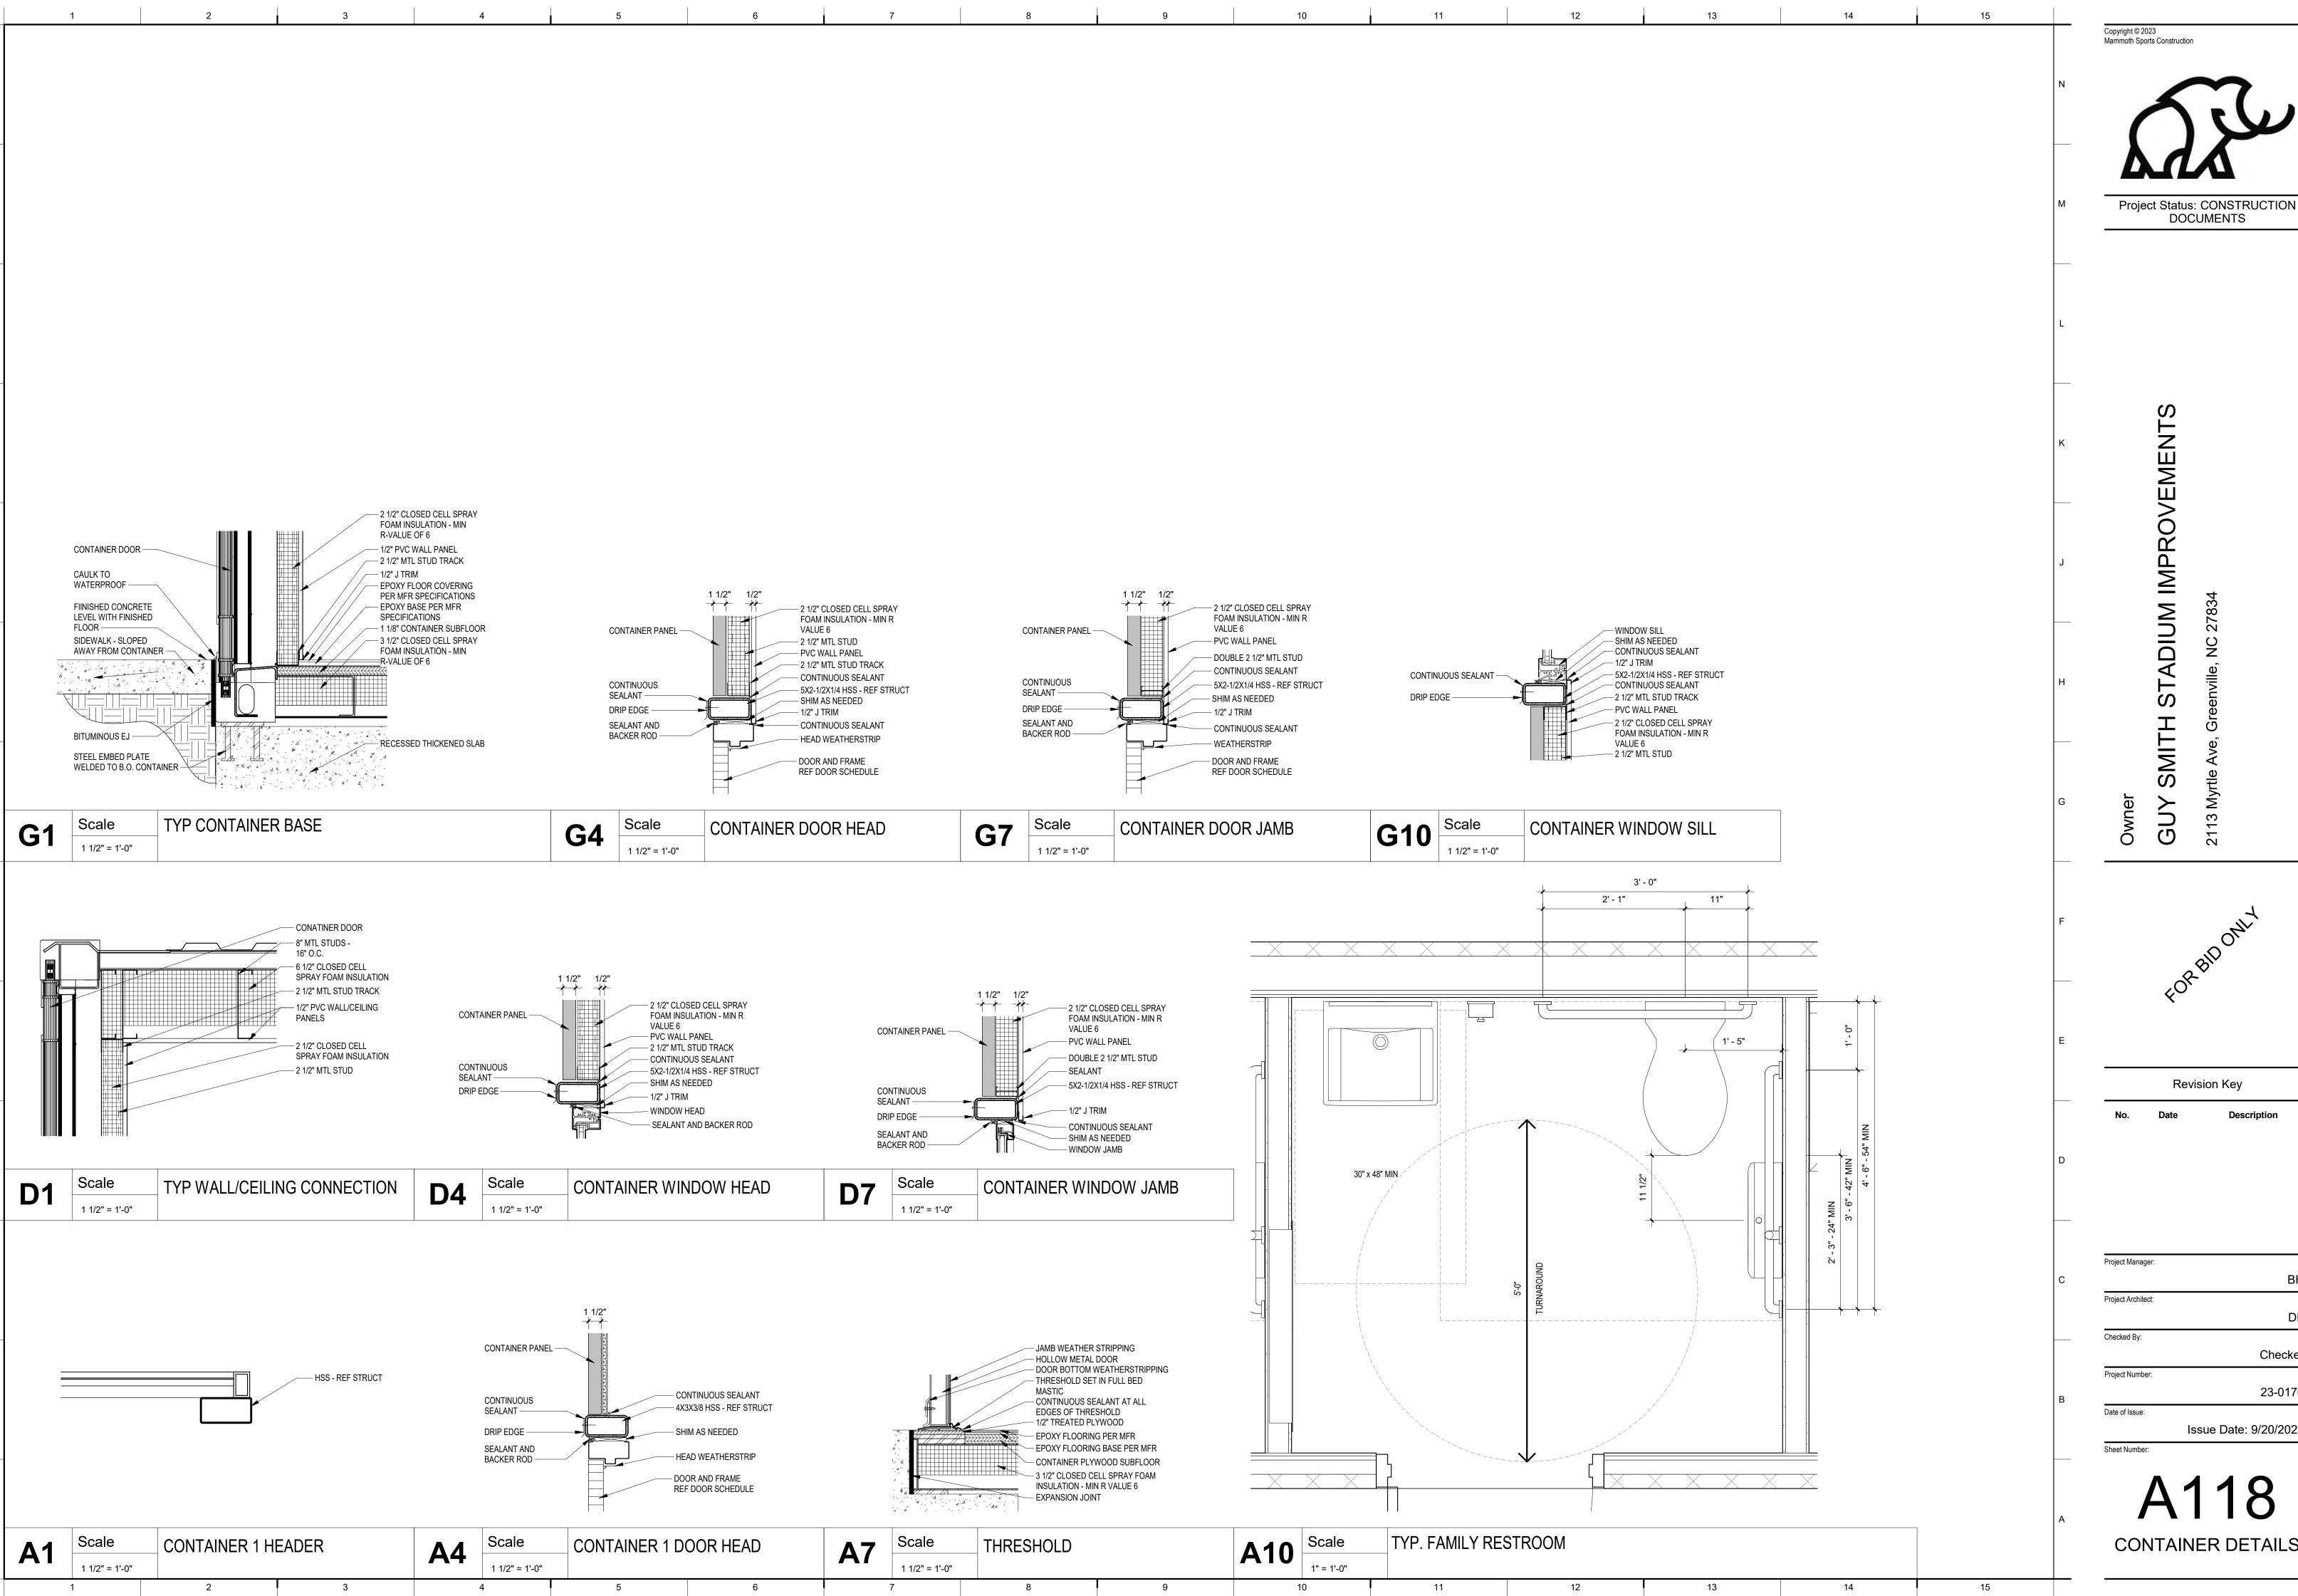

Mammoth Sports Construction

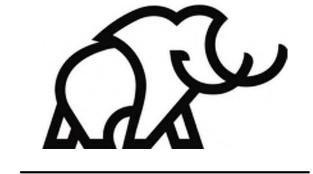



DOCUMENTS

Revision Key Description

Project Manager: Project Architect: Checker 23-0176 Issue Date: 9/20/2023

CONTAINER DETAILS

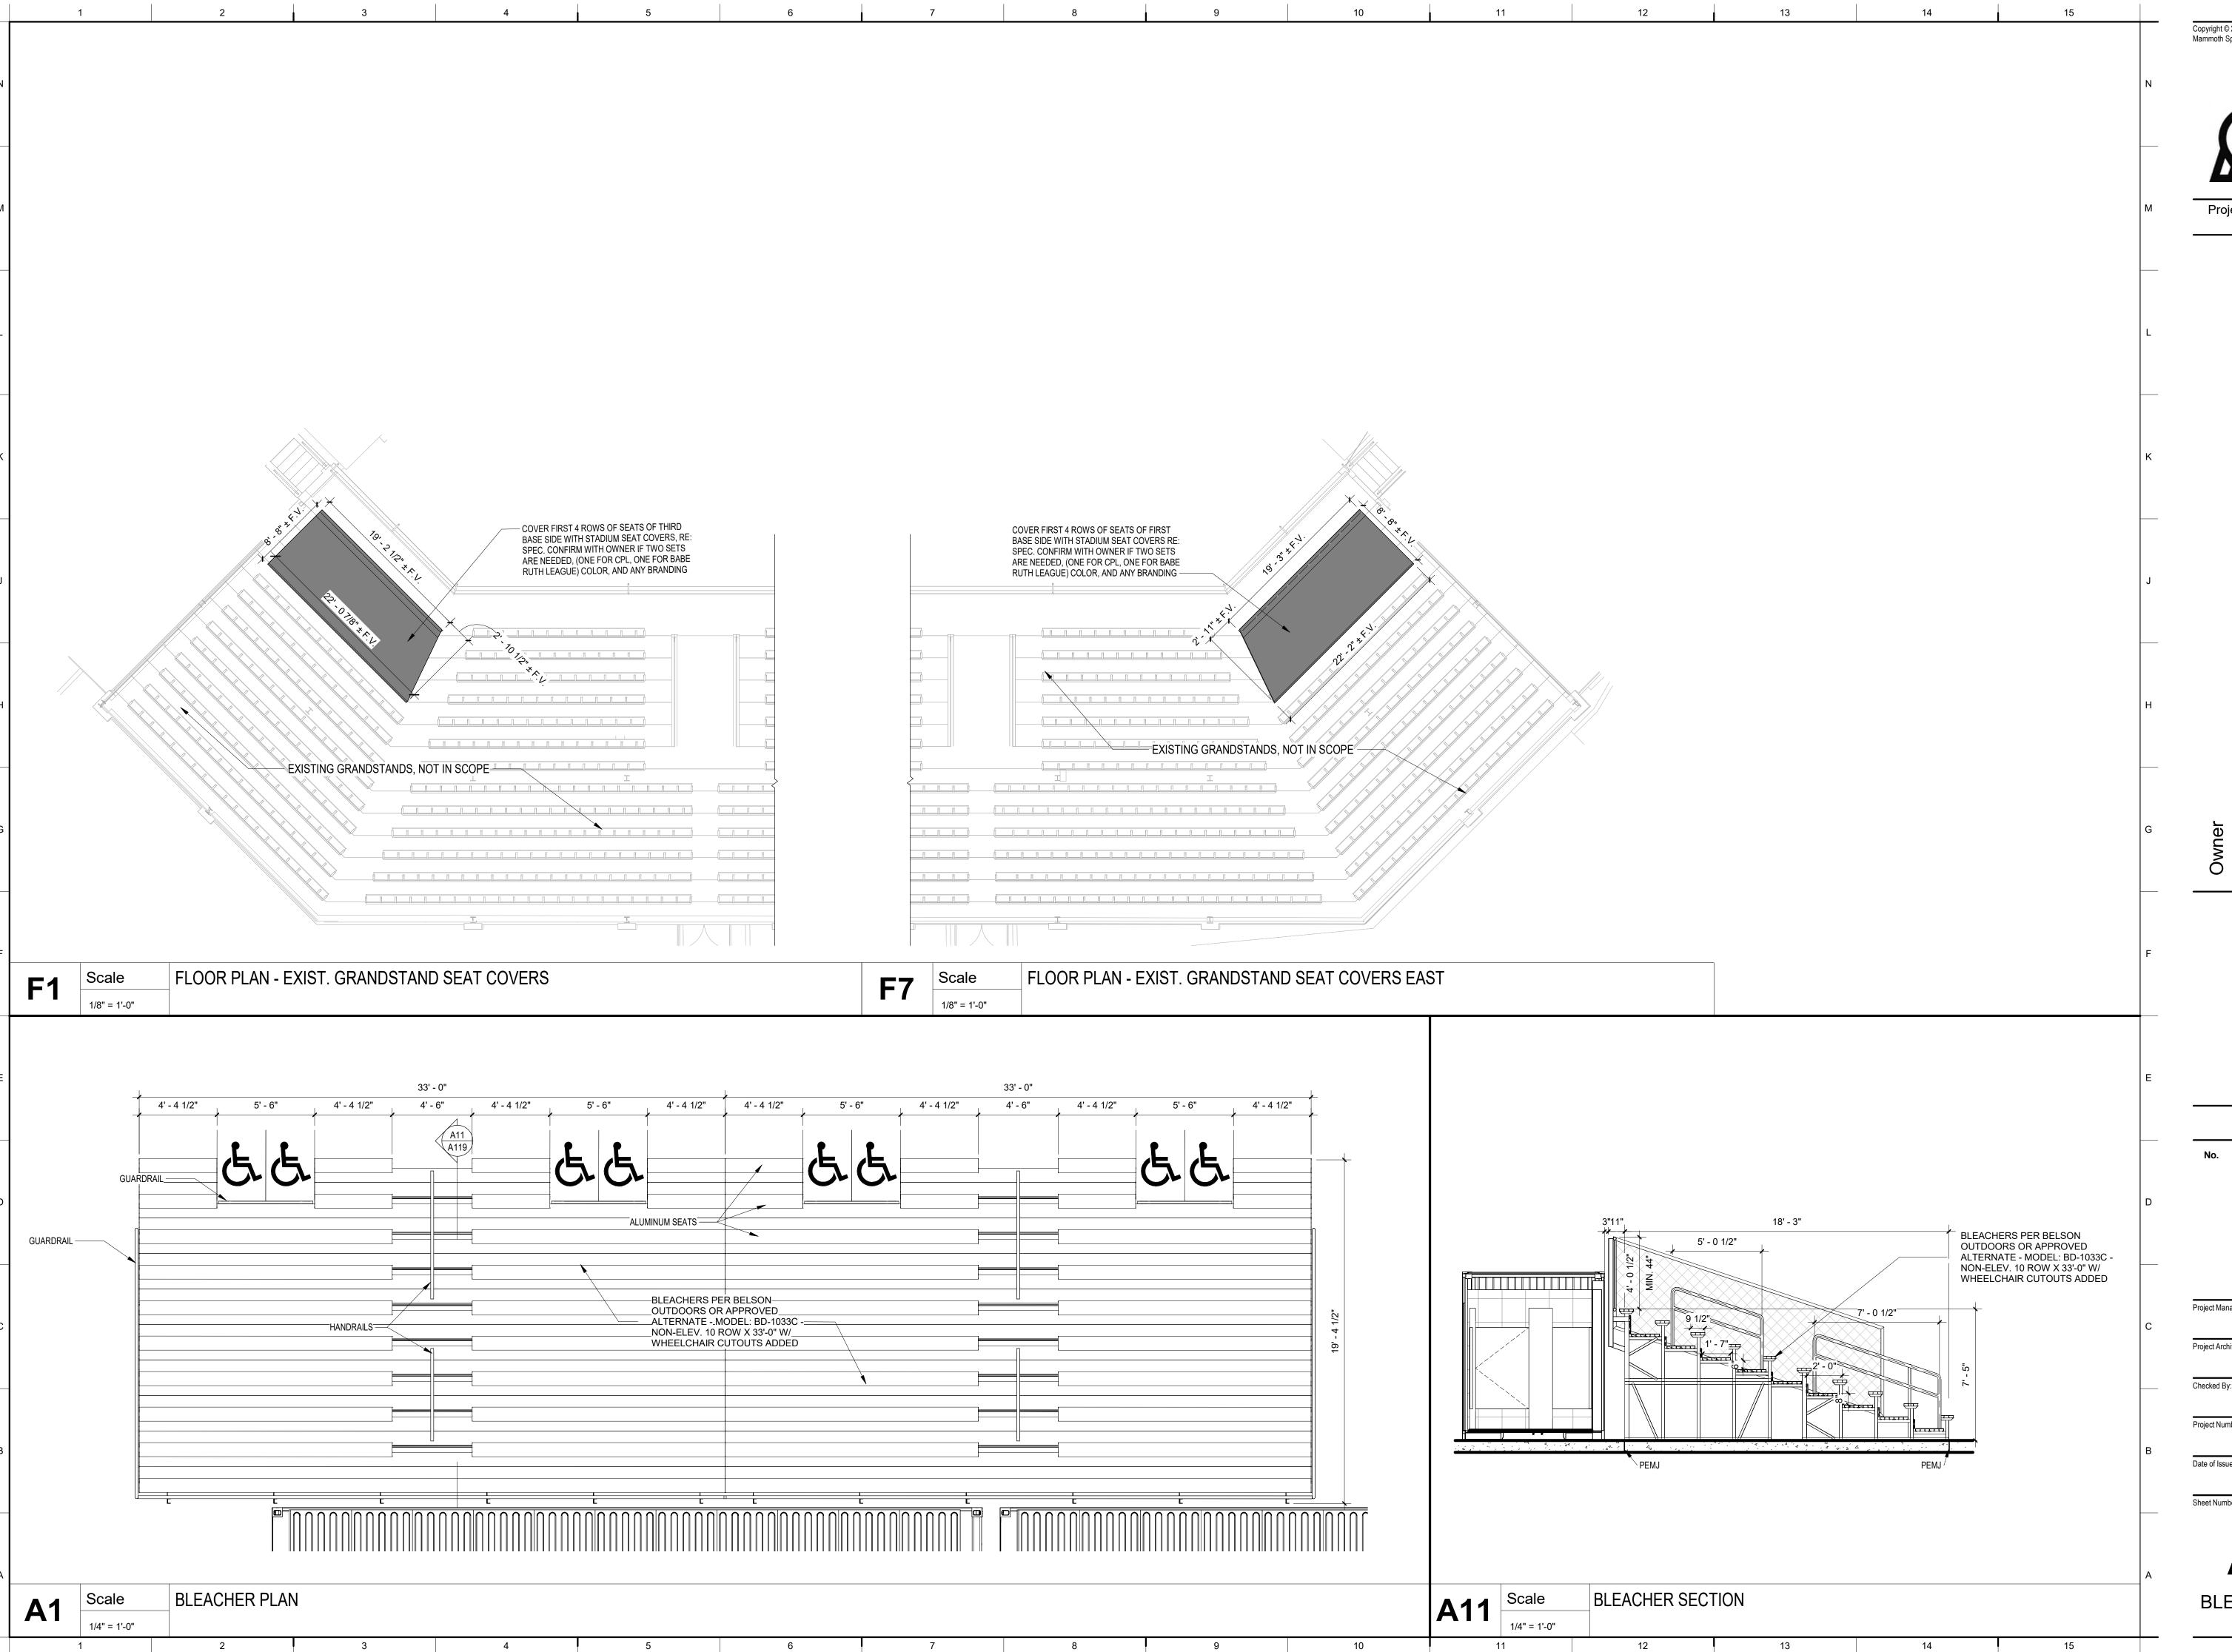

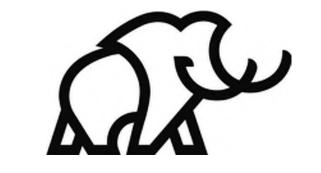

Project Status: CONSTRUCTION DOCUMENTS


Revision Key

Project Manager: Project Architect:

Project Number:

23-0176 Date of Issue: Issue Date: 9/20/2023

BLEACHER PLAN AND SECTION

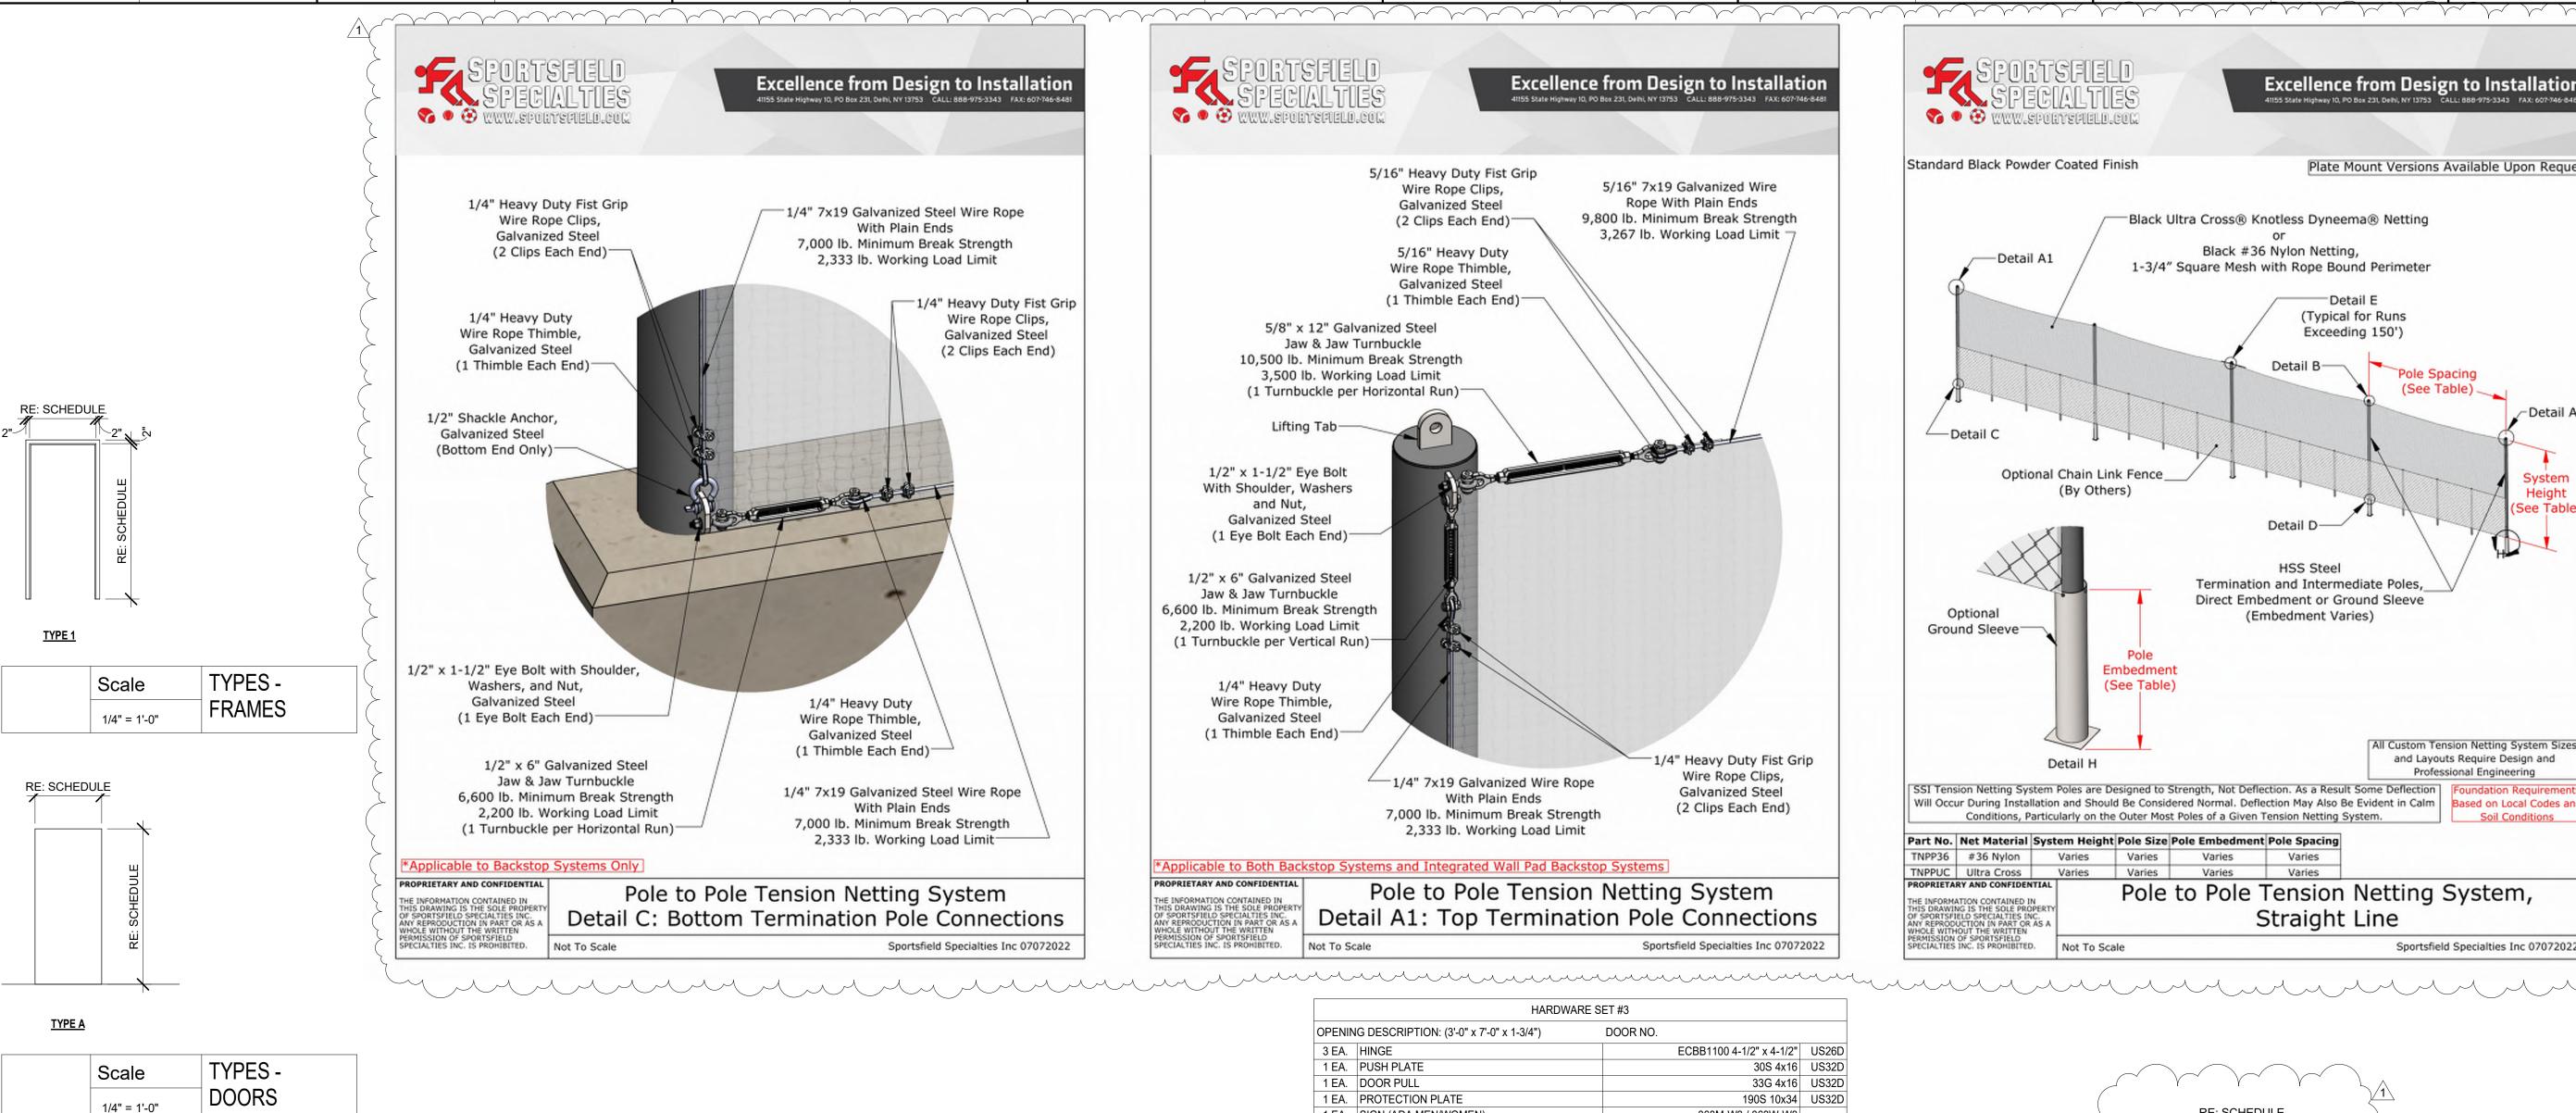

DOOR & FRAME SCHEDULE

METAL

METAL

METAL

METAL

METAL

METAL

METAL

MATERIAL

GLASS

TYPE

N/A

N/A

THICKNESS

1 3/4"

1 3/4"

1 3/4"

1 3/4"

1 3/4"

1 3/4"

1 3/4"

FRAME

TYPE

GLASS

N/A

N/A

N/A

N/A

N/A

N/A

N/A

HARDWARE

REFERENCED GENERAL NOTES

DOOR

7' - 0"

7' - 0"

7' - 0"

7' - 0"

7' - 0"

7' - 0"

7' - 0"

7' - 0"

3' - 0"

3' - 0"

SIGNAGE GRAPHICS


NUMBER TYPE MATERIAL


A H.M.


Scale

3" = 1'-0"

5-1B

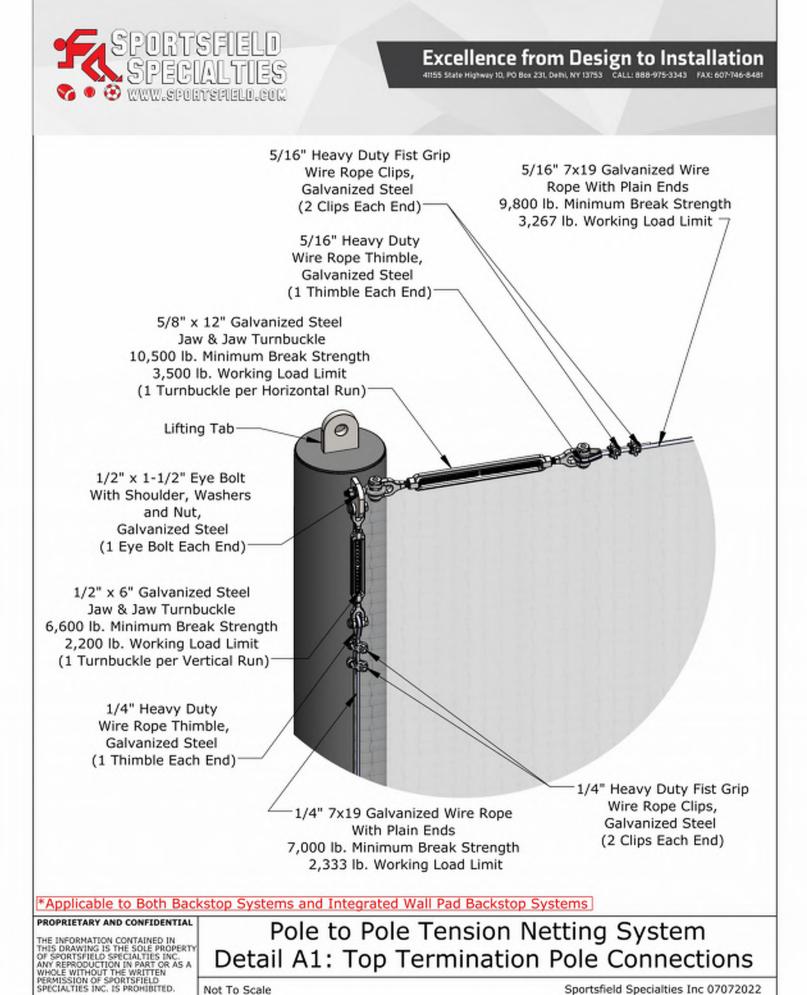

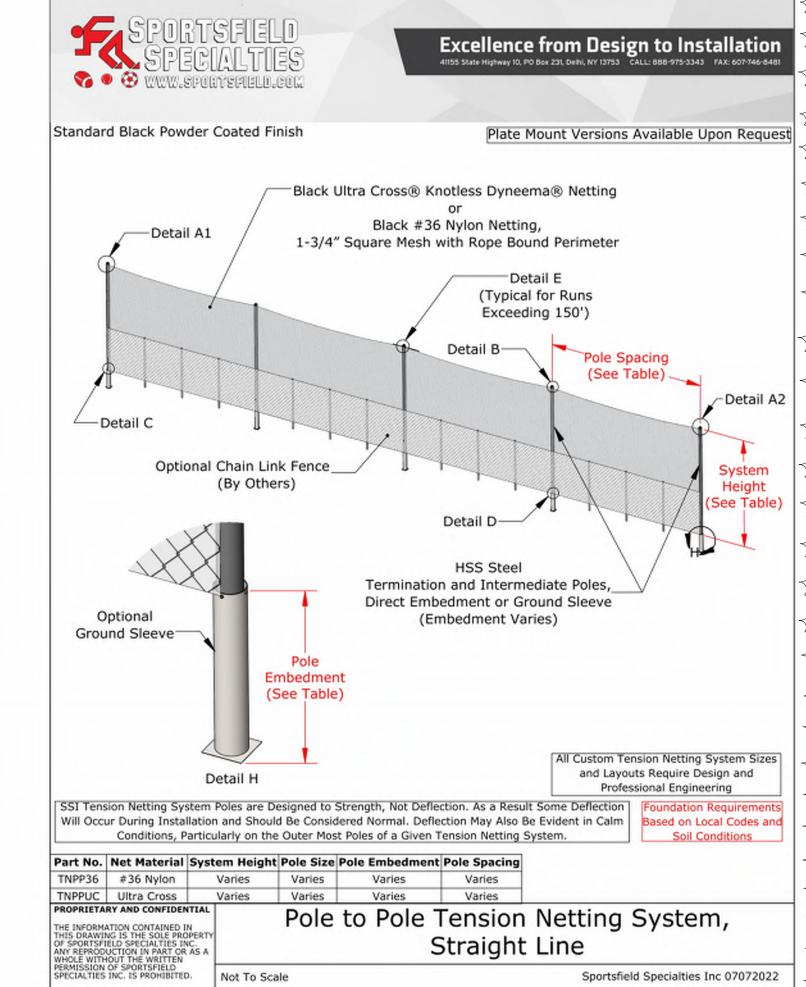

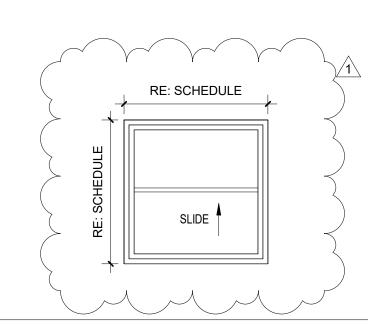

Sportsfield Specialties Inc 07072022

WINDOW SCHEDULE				
Type Mark	Width	Height	Manufacturer	Description
4-1	3' - 0"	3' - 0"	JELD-WEN	35.5" X 35.5" V-2500 SERIES WHITE VINYL SINGLE HUNG WINDOW WITH FIBERGLASS MESH SCREEN
4-1	3' - 0"	3' - 0"	JELD-WEN	35.5" X 35.5" V-2500 SERIES WHITE VINYL SINGLE HUNG WINDOW WITH FIBERGLASS MESH SCREEN
4-1	3' - 0"	3' - 0"	JELD-WEN	35.5" X 35.5" V-2500 SERIES WHITE VINYL SINGLE HUNG WINDOW WITH FIBERGLASS MESH SCREEN
4-1	3' - 0"	3' - 0"	JELD-WEN	35.5" X 35.5" V-2500 SERIES WHITE VINYL SINGLE HUNG WINDOW WITH FIBERGLASS MESH SCREEN

(Round Up to whole # for Calculated Load. Addt'l Occupants

Occupants

	HARDWA	RE SET #3		
OPENIN	IG DESCRIPTION: (3'-0" x 7'-0" x 1-3/4")	DOOR NO.		
3 EA.	HINGE		ECBB1100 4-1/2" x 4-1/2"	US26E
1 EA.	PUSH PLATE		30S 4x16	US32E
1 EA.	DOOR PULL		33G 4x16	US32E
1 EA.	PROTECTION PLATE		190S 10x34	US32E
1 EA.	SIGN (ADA MEN/WOMEN)		368M-W3 / 368W-W3	
1 EA.	CLOSER		SC81 RW/PA	689
1 EA.	WALL STOP		236W	US32[
1 EA.	LOCKSET		W581BD D	US26E
1 EA.	CONSTRUCTION CORE		80-035	GRN
1 EA.	BEST PERMANENT CORE BY OTHERS			
3 EA.	SILENCERS		307D	GRAY
1 EA.	THRESHOLD		412S 36	MIL
1 EA.	DOOR SWEEP		754S N 36	CLF
1 EA.	WEATHERSTRIPPING		891S V 1x36", 2x84"	MIL

HARDWARE SET #10				
OPENIN	NG DESCRIPTION: (4'-0" x 7'-0" x 1-3/4")	DOOR NO. 101, 200, & 203		
3 EA.	HINGE	ECBB1100 4-1/2" x 4-1/2" NRP	US26D	
1 EA.	LOCKSET (STOREROOM)	W581BD D	US26D	
1 EA.	CONSTRUCTION CORE	80-035	GRN	
1 EA.	BEST PERMANENT CORE BY OTHERS			
1 EA.	PROTECTION PLATE	194S 10x34	US32D	
1 EA.	DRIP CAP	810S x 40	MIL	
1 EA.	THRESHOLD	412S 36	MIL	
1 EA.	DOOR SWEEP	754S N 36	CLR	
1 SET	WEATHERSTRIPPING	891S V 1x36". 2x84"	MIL	

	10"		8"		8"		8"	
is R	ESTROOM	6" MIN. PICTOGRAM FIELD 3/4"	WOMEN	6" MIN. PICTOGRAM FIELD 3/4" 8"	MEN	6" MIN. PICTOGRAM FIELD 3/4"	WOMEN	6" MIN. PICTOGRAM FIELD
N	(dots)	only for on of Braille)	(dots posit	s only for ion of Braille)	(dot pos	ts only for iition of Braille)	(do pos	ະ ເຮ only for iition of Braille)
S	IGN TYPE 1	,	SIGN TYPE 2		SIGN TYPE 3		SIGN TYPE 4	

				Occupant	may be added per Building Official's Approval)
Number	Name	Function of Space	Area	Load Factor	Occupant Load - Calculated
1-1	TEAM STORE	Business Areas	149 SF	100 SF	2
2-1	WOMEN'S ADA	N/A	129 SF	0 SF	
2-2	MEN'S ADA	N/A	129 SF	0 SF	
3-1	WOMEN'S RR 1	N/A	127 SF	0 SF	
3-2	WOMEN'S RR 2	N/A	127 SF	0 SF	
4-1	CONTAINER 2 CONCESSION	Kitchens, Commercial	111 SF	200 SF	1
4-2	FAMILY RR 1	N/A	49 SF	0 SF	
4-3	FAMILY RR 2	N/A	49 SF	0 SF	
4-4	FAMILY RR 3	N/A	49 SF	0 SF	
5-1	KITCHEN	Kitchens, Commercial	267 SF	200 SF	2

WORKSHEET - ROOM OCCUPANCY

Copyright © 2023 Mammoth Sports Construction



Project Status: CONSTRUCTION

DOCUMENTS



	Revision Key				
No.	Date 9/29/23	Description REV #1			

Project Manager:	
	ВН
Project Architect:	
	DF
Checked By:	
	Checker
Project Number:	
	23-0176
Date of Issue:	
	Issue Date: 9/22/2023
Sheet Number:	

SCHEDULES, SIGNAGE, **NETTING DETAILS**

